52 EMERALD BAY LAGUNA BEACH, CA 92651





<u>OWNER</u> STEVE OLSON 52 EMERALD BAY LAGUNA BEACH, CA 92869 PH: 949.981.5678

<u>ARCHITECT</u>

CHARLES d'ARCY d'ARCY & ASSOC. ARCHITECTURE, INC. 18 TECHNOLOGY DRIVE SUITE 158 IRVINE, CA 92618 PH: 949.407.7760 charles@darcyarchitecture.com

<u>CIVIL ENGINEER</u>

www.toalengineering.com

EMERALD BAY

LANDSCAPE ARCHITECT


ADAM TOAL TOAL ENGINEERING, INC. 139 AVENIDA NAVARRO SAN CLEMENTE,CA 92672 PH: 949.492.8586 JOHN PORZUCZEK ZEPHYR LANDSCAPE ARCHITECTURE PH: (949) 412-4981 john@zephyrlandscape.com



PROJECT LOG	PROJECT DESCRIPTION	CODE ANALYSIS OVERVIEW		PROJECT DATA		MUNICIPALITY NOTES
DESCRIPTION E.B. CONCEPT ARCHITECTURAL REVIEW SUBMITTAL E.B. CONCEPT ARCHITECTURAL REVIEW SUBMITTAL E.B. CONCEPT ARCHITECTURAL REVIEW / APPROVED UPDATES	NEW 2 STORY W/ BASEMENT 6,524.7 SF SINGLE FAMILY RESIDENCE WITH 4 BEDROOMS, 7 1/2 BATHS, CALIFORNIA ROOM, GYM, AND OTHER COMMON LIVING SPACES. THIS PROJECT IS TO BE CONSTRUCTED AFTER COMPLETE DEMOLITION OF EXISTING RESIDENCE WITHIN THE EMERALD BAY COMMUNITY.	PROJECT TYPE: CONSTRUCTION TYPE: OCCUPANCY: FIRE SPRINKLER:	SINGLE FAMILY DETACHED TYPE VB R3 NON-SPRINKLERED	PROJECT ADDRESS: APN: TRACT:	52 EMERALD BAY LAGUNA BEACH, CA 92869 053-060-92 940	DEFERED SUBMITTAL:
COASTAL DEVELOPMENT PERMIT RESUBMITTAL COASTAL DEVELOPMENT PERMIT RESUBMITTAL		APPLICABLE CODES:	2019 CALIFORNIA RESIDENTIAL CODE 2019 CALIFORNIA MECHANICAL CODE 2019 CALIFORNIA ELECTRICAL CODE 2019 CALIFORNIA ENERGY CODE 2019 CALIFORNIA GREEN BUILDING CODE ALL LOCAL ORDINANCES AND REQUIREMENTS	LOT: STORIES: LOT AREA: BUILDING AREA: AREA TABULAT PROPOSED FLOOR AREA: PROPOSED LOWER BASEMENT AREA PROPOSED MAIN LEVEL AREA PROPOSED GARAGE MAIN LEVEL AREA PROPOSED UPPER LEVEL AREA TOTAL FLOOR AREA:	2 STORIES + BASEMENT 4,598 SF (0.11 ACRES) EXISTING 2,528 SQ. FT. 2044.5 SF 1685.9 SF 774.5 SF 2019.8 SF 6524.7 SF	SPECIAL INSPECTIONS:
LOCATION MAP	DRAWING SYMBOLS			LIVABLE SQUARE FOOTAGE: PROPOSED SITE COVERAGE:	5750.2 SF 2767.4 SF	
EMERALD BAY	REVISION DESIGNATION WID WALL TAG REVISION DESIGNATION WALL TAG KEYNOTE REFERENCE DETAIL REFERENCE			OVERALL SITE: PROPOSED LOT COVERAGE: (UNLIMITED LOT COVERAGE) TOTAL STRUCTURAL AREA LESS GARAGE (TOTAL STRUCT. AREA - REQ. ENCLOSED PARKING) (6524.7 SF - 430 SF - 215 SF)	4598.0 SF 60.1% ————————————————————————————————————	

INTERIOR ELEVATION REFERENCE ELEVATION NUMBER OUTER SHEET NUMBER INSIDE

ENLARGED AREA REFERENCE PLAN NUMBER OVER SHEET NUMBER

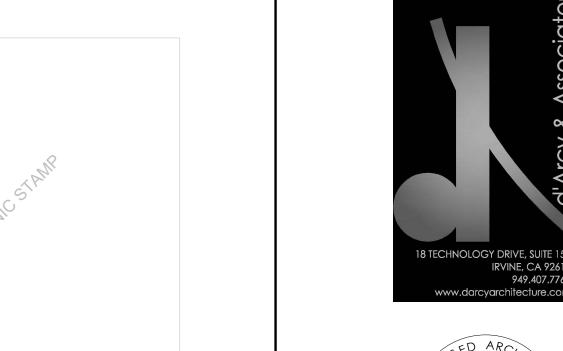

SHEET INDEX

SITE PLAN - AVERAGE DEPTH CALCULATION

SHEET # DESCRIPTION

ARCHITECTURAL

LANDSCAPE

TOTAL SHEETS

SITE CONTEXT PHOTOS EXTERIOR PERSPECTIVES


PROPOSED SITE PLAN TOPOGRAPHIC SURVEY

BASEMENT LEVEL REFERENCE MAIN LEVEL REFERENCE UPPER LEVEL REFERENCE

PRELIMINARY GRADING PLAN PRELIMINARY HARDSCAPE PLAN

PRELIMINARY PLANTING & LIGHTING PLAN

EXTERIOR ELEVATIONS EXTERIOR ELEVATIONS **BUILDING SECTIONS BUILDING SECTIONS**

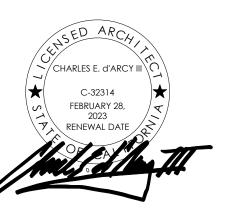


JOB # 2143 07/08/2022


COVER SHEET


SCALE: AS NOTED



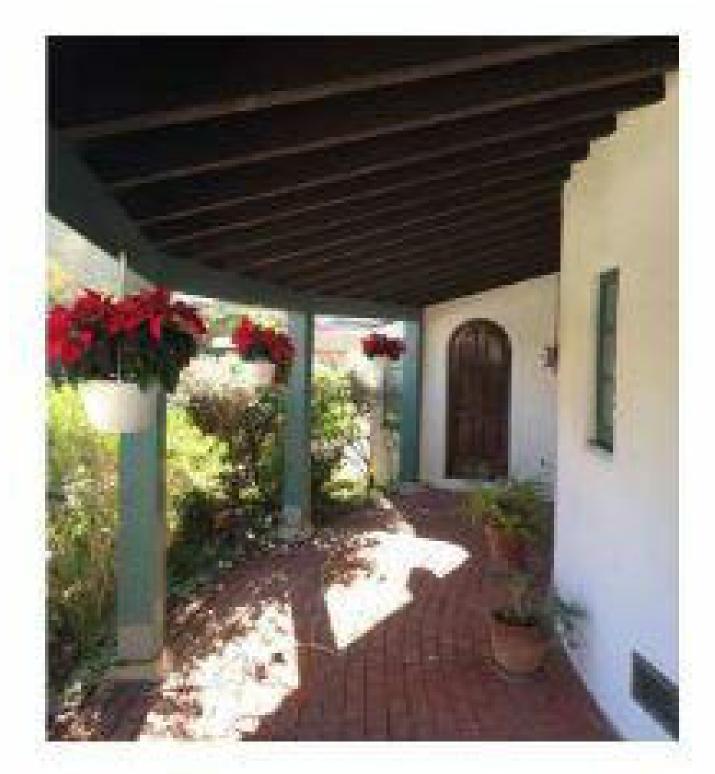





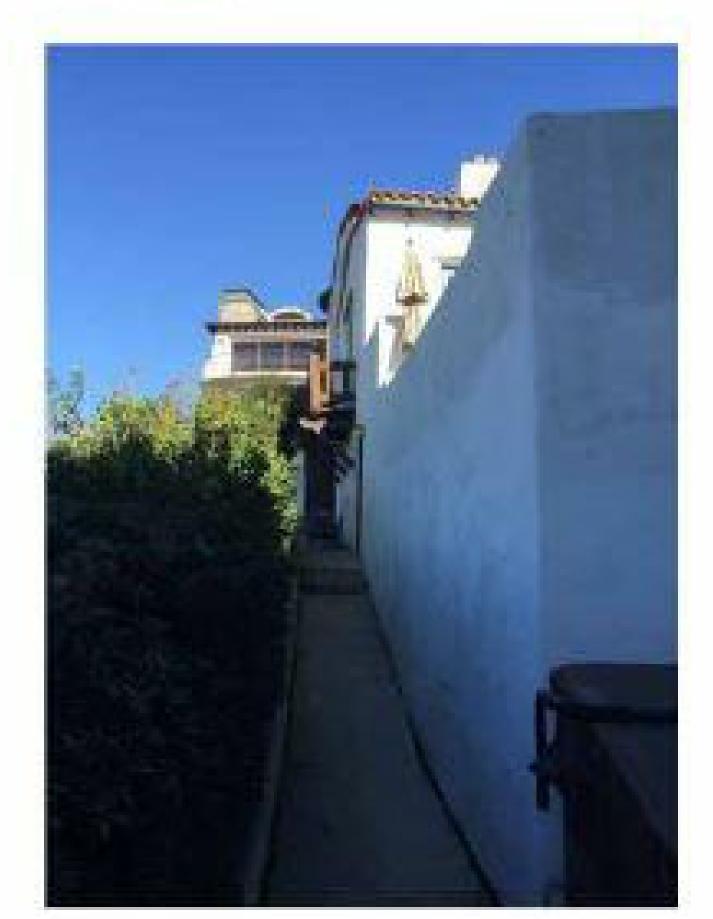

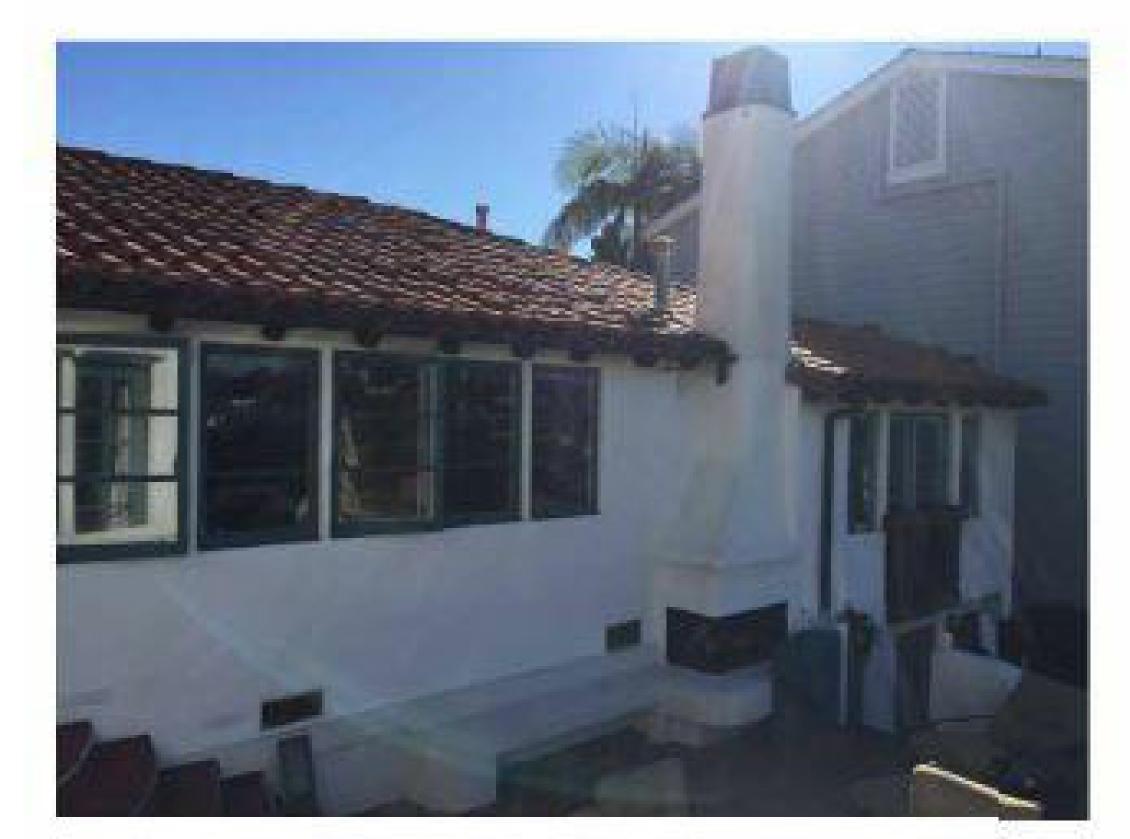



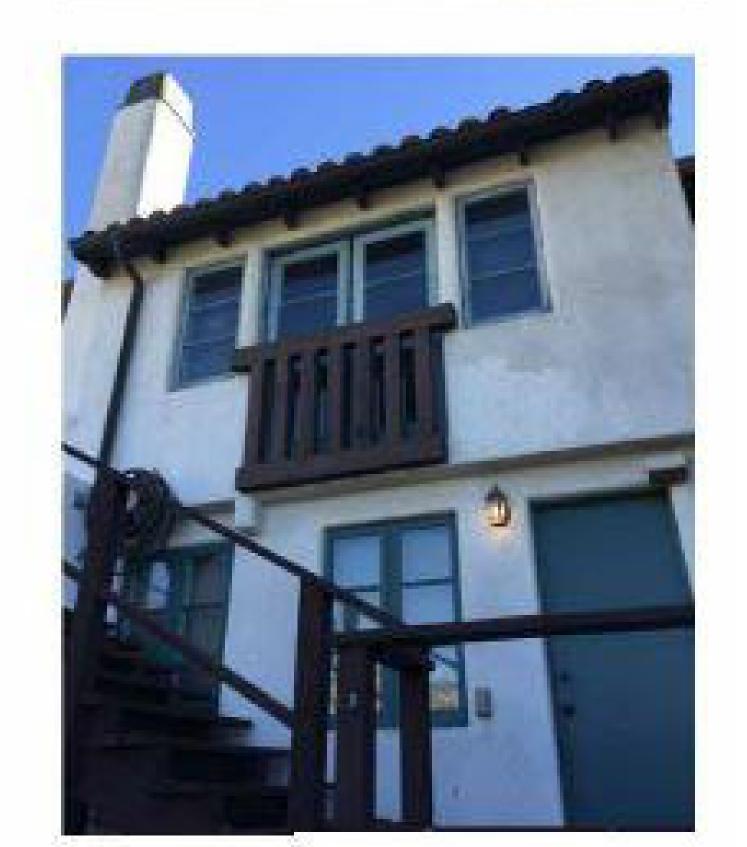

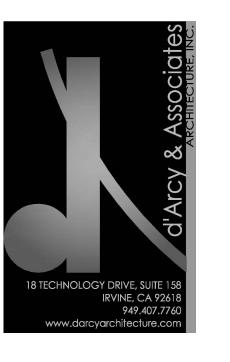

REVISIONS


JOB # 2143

07/08/2022

SITE CONTEXT PHOTOS

A050

SCALE: NTS

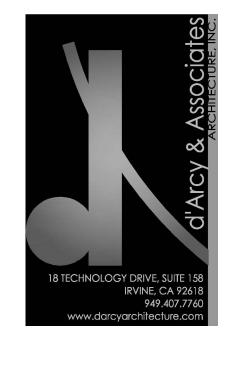

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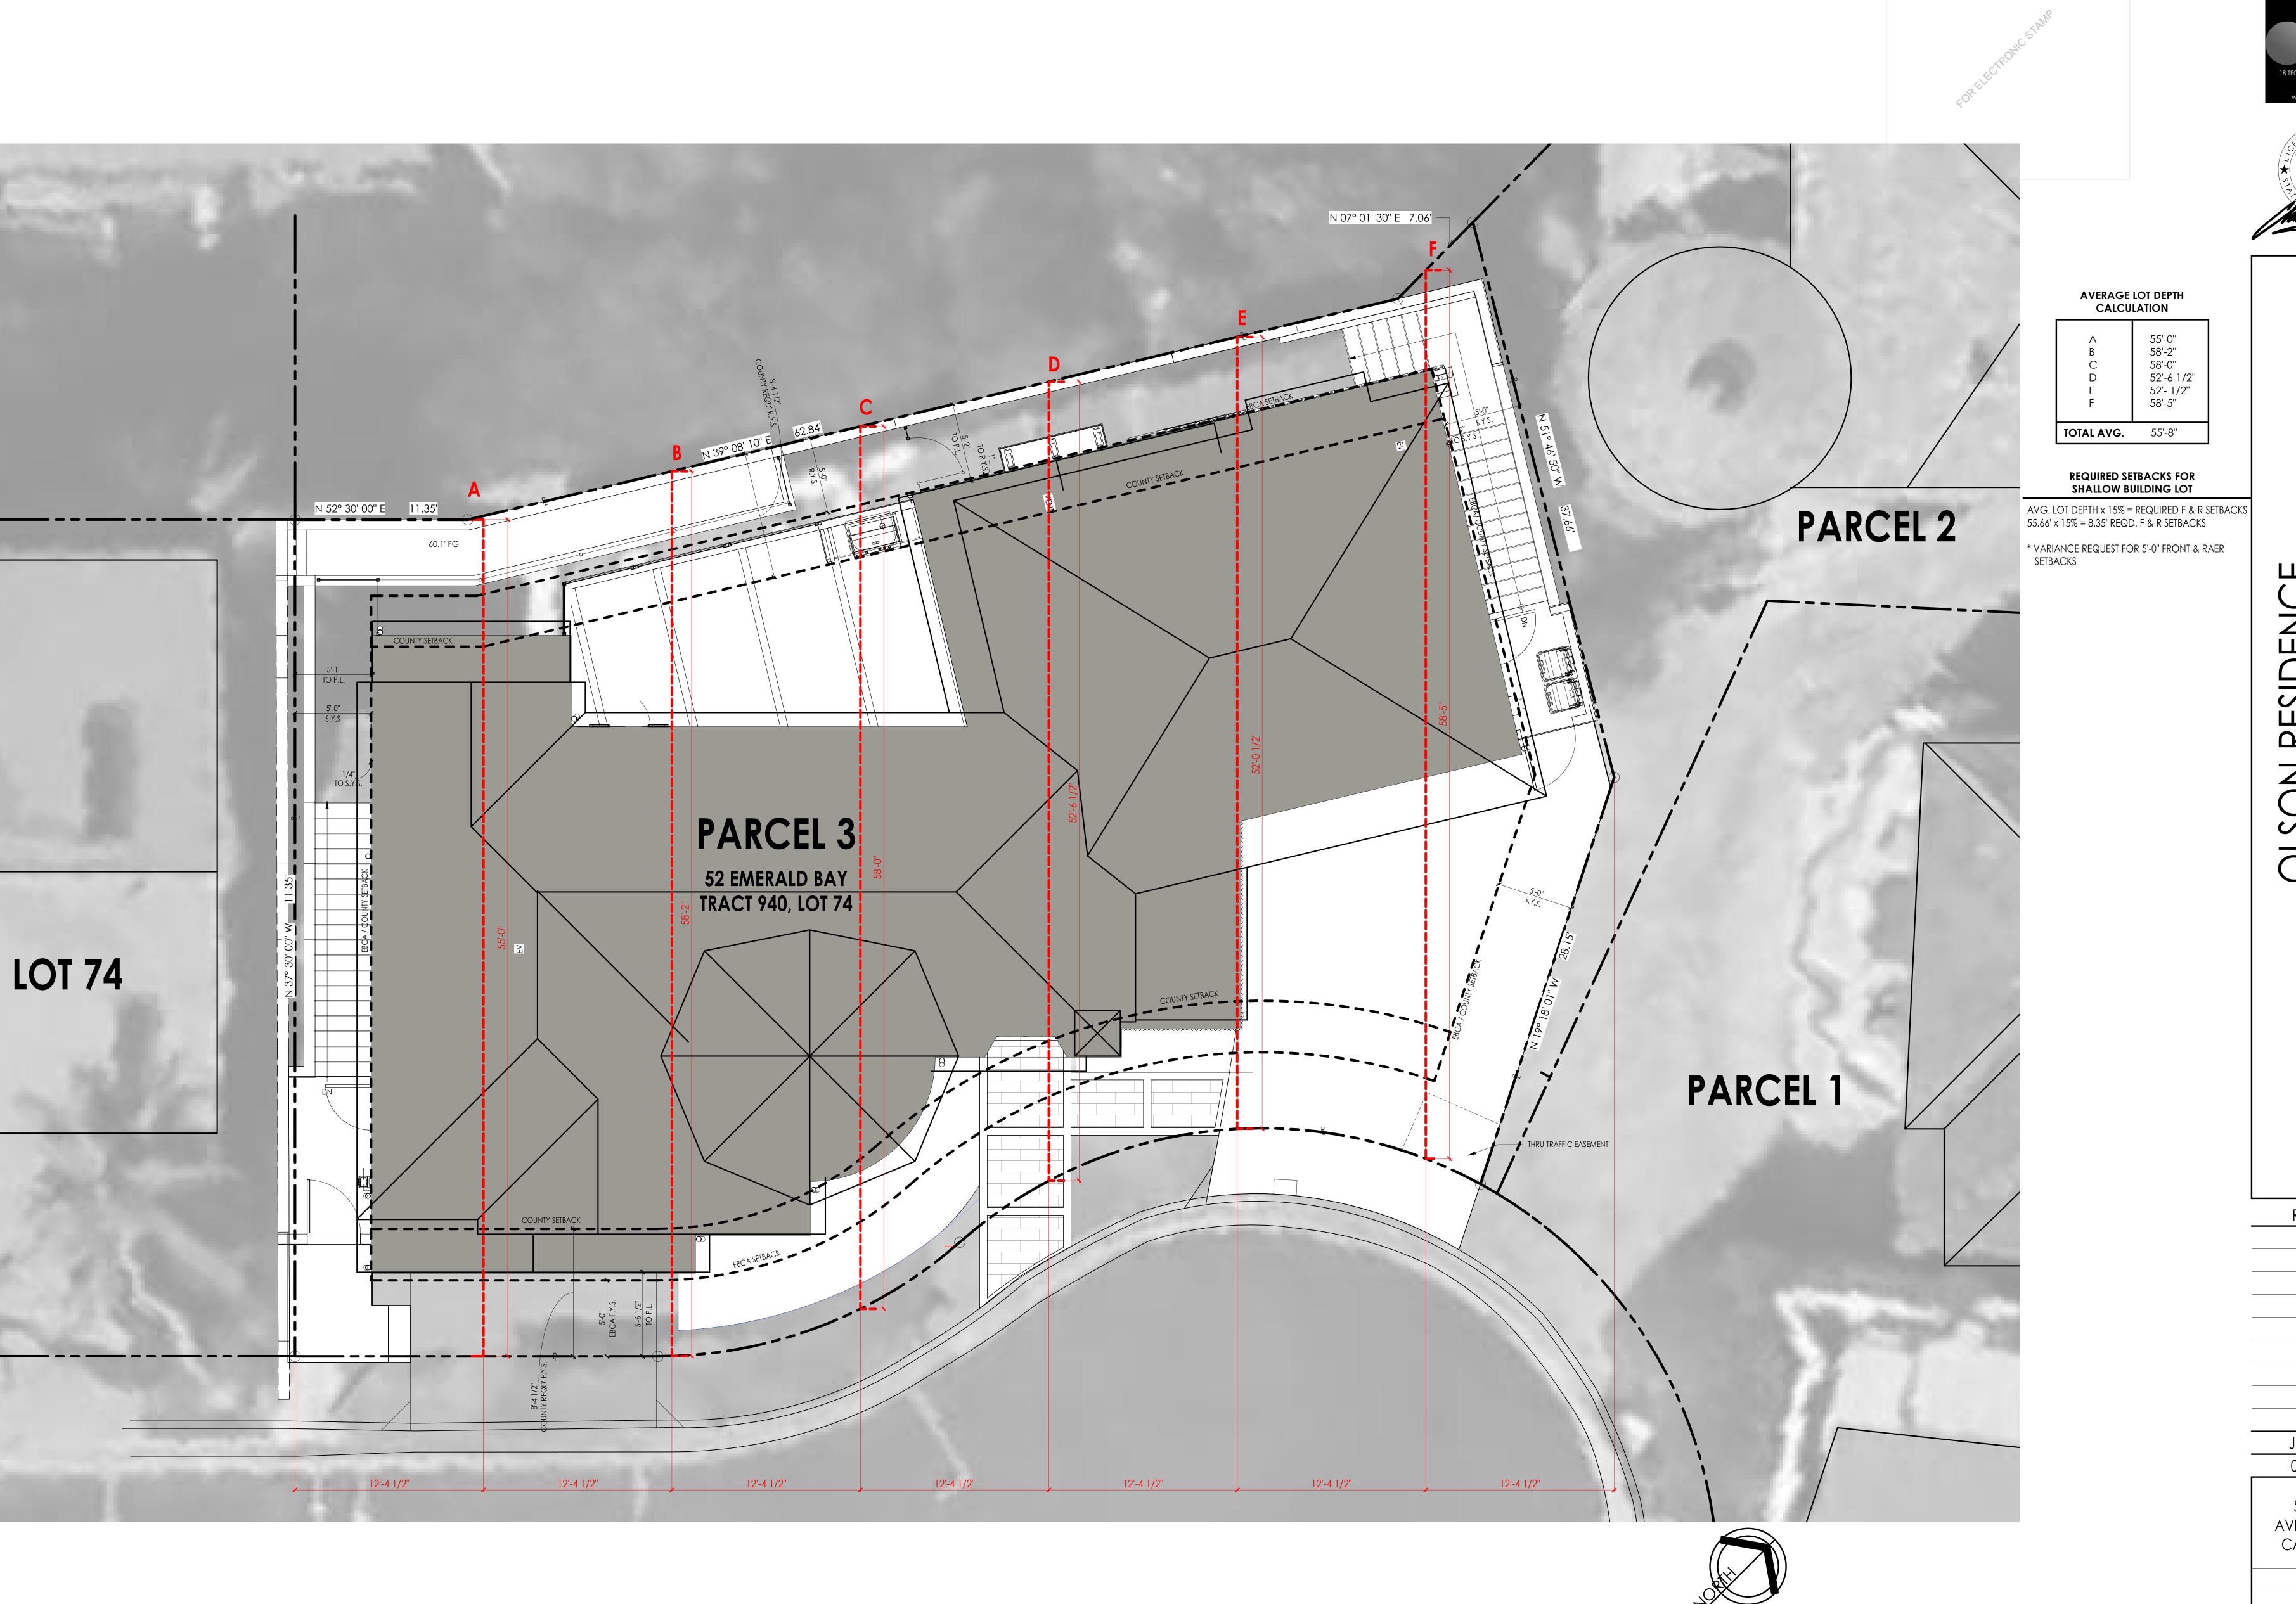
EXTERIOR PERSPECTIVES



nt view (proposed)



REAR VIEW (PROPOSED)








RESIDE

REVISIONS

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SITE PLAN -AVERAGE DEPTH CALCULATION



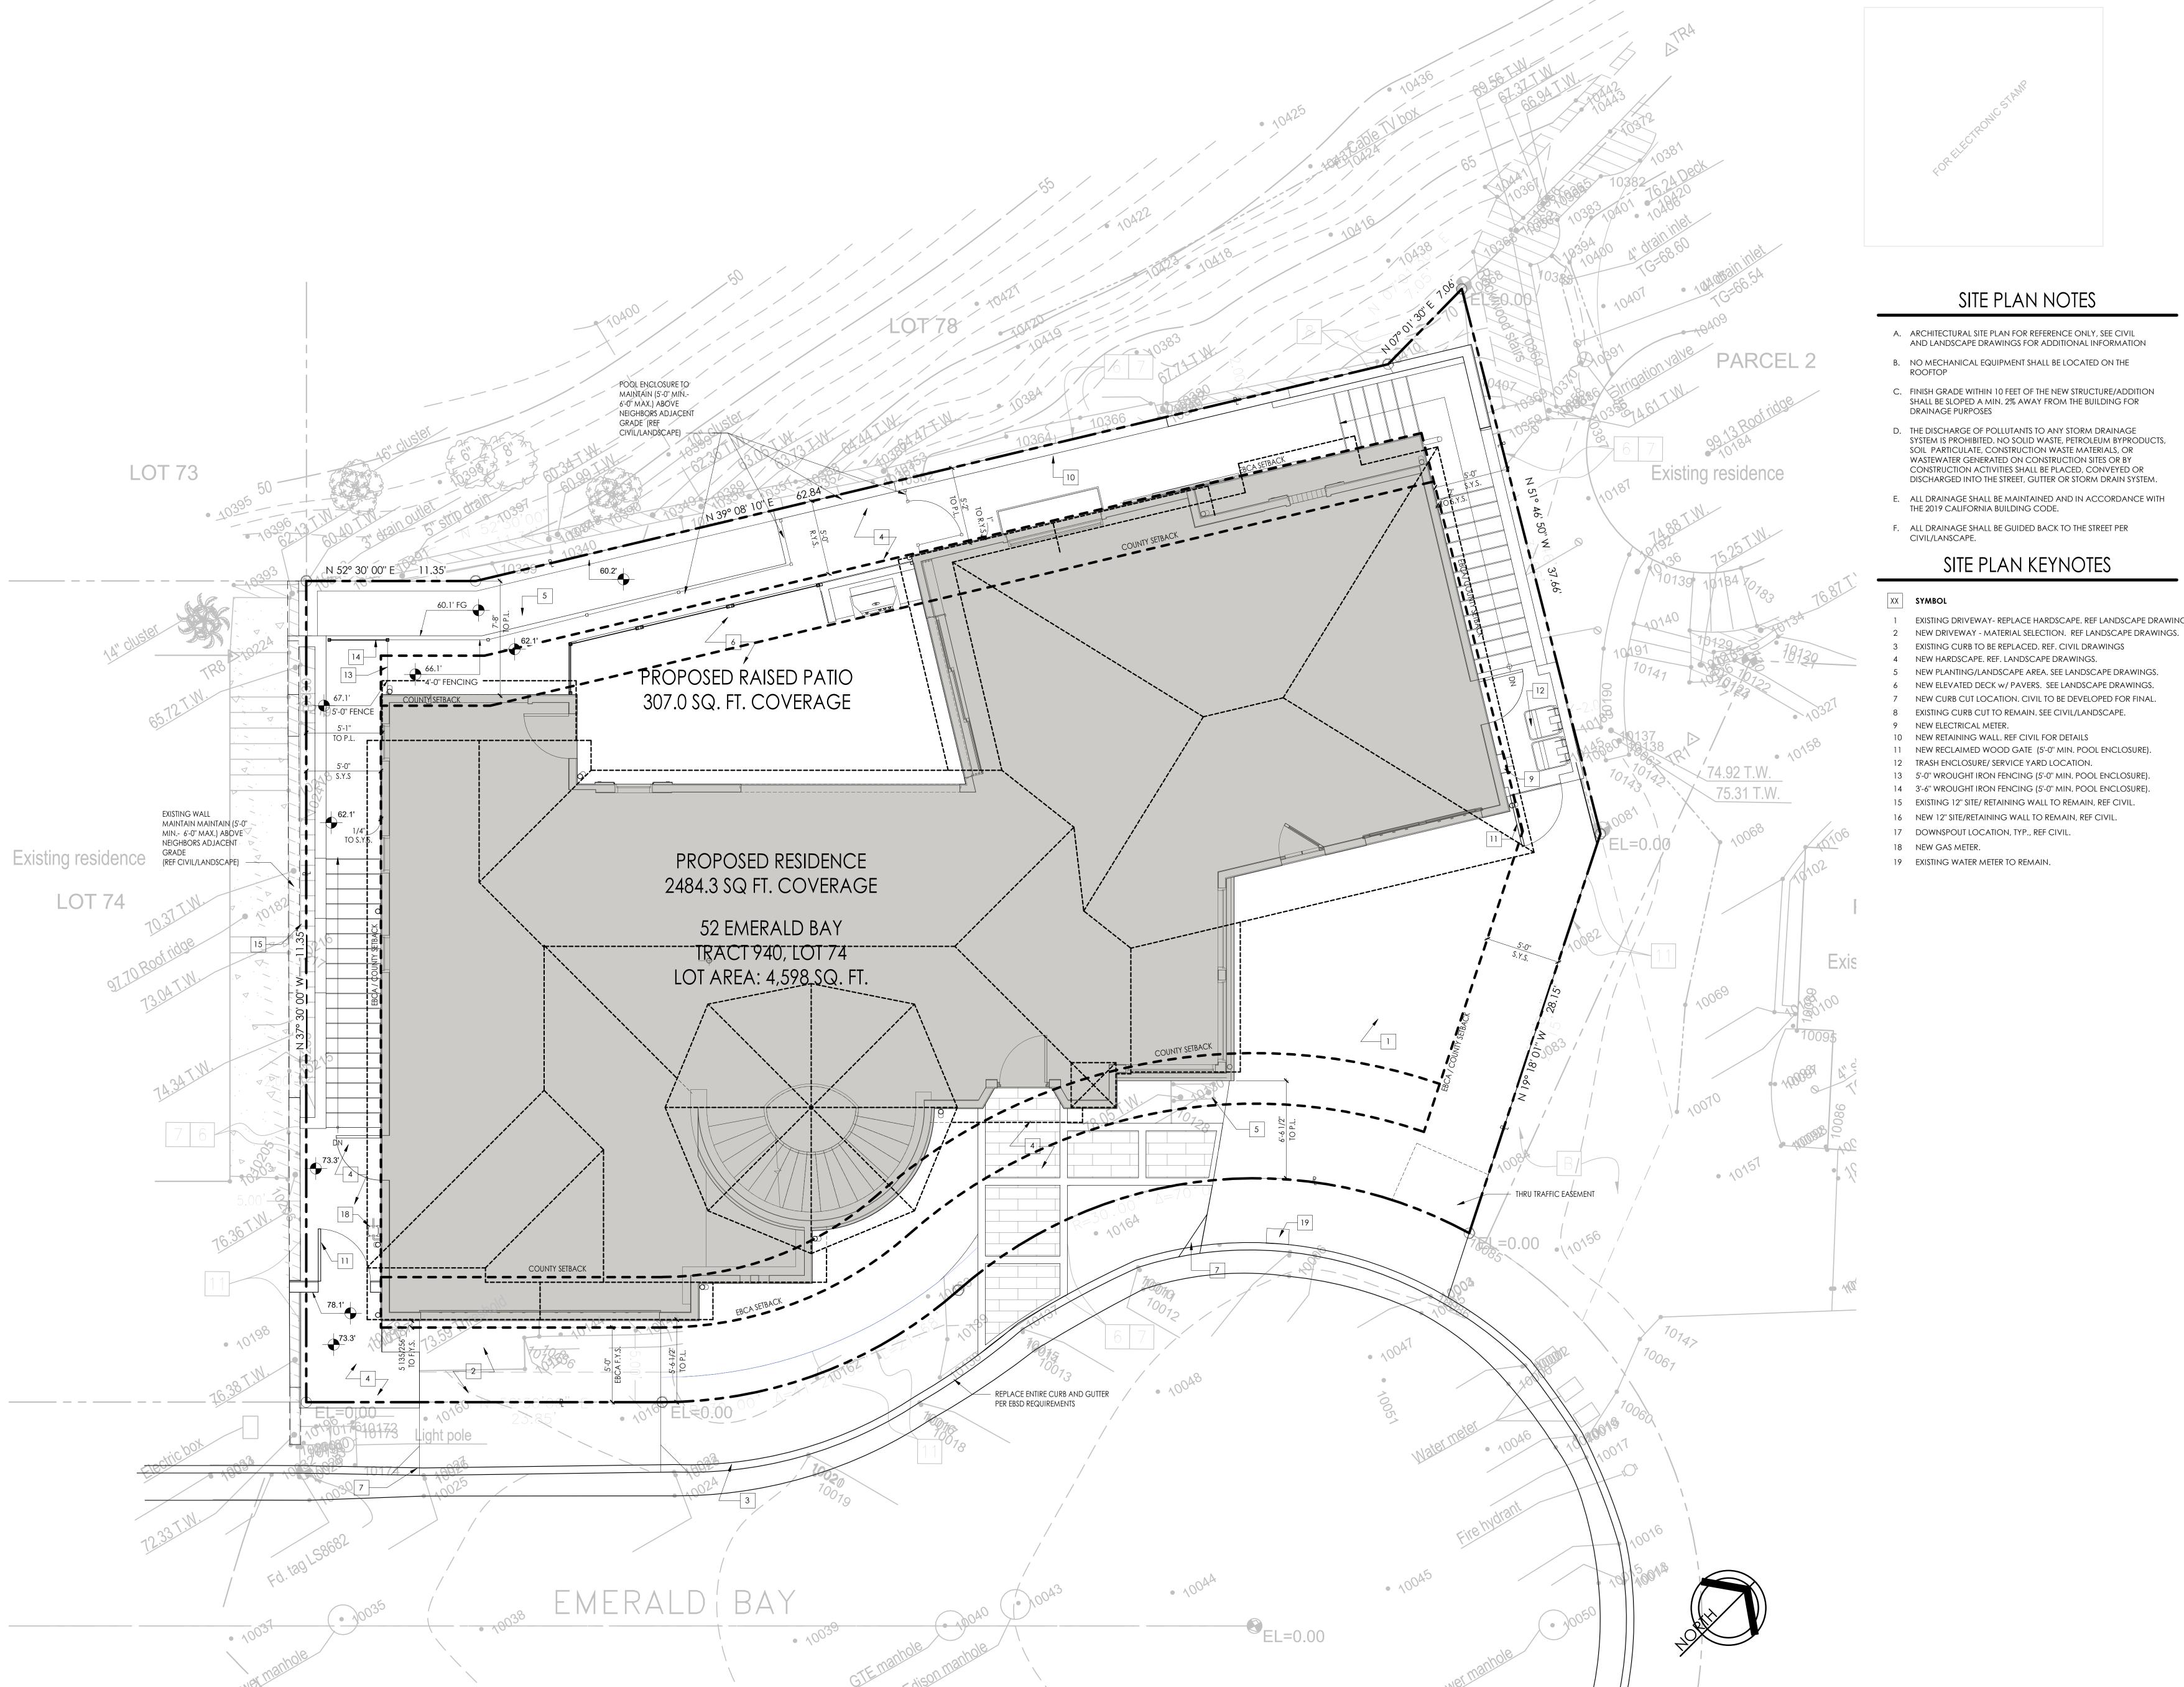



SITE PLAN NOTES

- A. ARCHITECTURAL SITE PLAN FOR REFERENCE ONLY, SEE CIVIL AND LANDSCAPE DRAWINGS FOR ADDITIONAL INFORMATION
- B. NO MECHANICAL EQUIPMENT SHALL BE LOCATED ON THE ROOFTOP
- C. FINISH GRADE WITHIN 10 FEET OF THE NEW STRUCTURE/ADDITION SHALL BE SLOPED A MIN. 2% AWAY FROM THE BUILDING FOR
- D. THE DISCHARGE OF POLLUTANTS TO ANY STORM DRAINAGE WASTEWATER GENERATED ON CONSTRUCTION SITES OR BY CONSTRUCTION ACTIVITIES SHALL BE PLACED, CONVEYED OR
- DISCHARGED INTO THE STREET, GUTTER OR STORM DRAIN SYSTEM. E. ALL DRAINAGE SHALL BE MAINTAINED AND IN ACCORDANCE WITH THE 2019 CALIFORNIA BUILDING CODE.
- F. ALL DRAINAGE SHALL BE GUIDED BACK TO THE STREET PER CIVIL/LANSCAPE.

SITE PLAN KEYNOTES

- 1 EXISTING DRIVEWAY- REPLACE HARDSCAPE. REF LANDSCAPE DRAWINGS.
- 3 EXISTING CURB TO BE REPLACED. REF. CIVIL DRAWINGS NEW HARDSCAPE. REF. LANDSCAPE DRAWINGS.
- NEW PLANTING/LANDSCAPE AREA. SEE LANDSCAPE DRAWINGS.
- 6 NEW ELEVATED DECK w/ PAVERS. SEE LANDSCAPE DRAWINGS.
- NEW CURB CUT LOCATION. CIVIL TO BE DEVELOPED FOR FINAL. 8 EXISTING CURB CUT TO REMAIN. SEE CIVIL/LANDSCAPE.
- 9 NEW ELECTRICAL METER.
- 10 NEW RETAINING WALL. REF CIVIL FOR DETAILS 11 NEW RECLAIMED WOOD GATE (5'-0" MIN. POOL ENCLOSURE).
- 12 TRASH ENCLOSURE/ SERVICE YARD LOCATION.
- 13 5'-0" WROUGHT IRON FENCING (5'-0" MIN. POOL ENCLOSURE). 14 3'-6" WROUGHT IRON FENCING (5'-0" MIN. POOL ENCLOSURE).
- 16 NEW 12" SITE/RETAINING WALL TO REMAIN, REF CIVIL. 17 DOWNSPOUT LOCATION, TYP., REF CIVIL.
- 18 NEW GAS METER.
- 19 EXISTING WATER METER TO REMAIN.

ESIDE Δ

REVISIONS

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PROPOSED SITE PLAN

EASEMENT NOTES:

NUMBERING SEQUENCE PER FIDELITY NATIONAL TITLE COMPANY PRELIMINARY REPORT NO. 00317748-997, DATED AUGUST 27, 2020.

- 4 Restrictions and conditions subsequent as contained in the deed from William Miles. Jr. to William T. Craig recorded September 13, 1928 in Book 197, Page 232 Official Records and in the deed from Ada Patterson Callender, as executrix, to William T Craig, recorded September 13, 1928 in Book 197, Page 234, Official Records. (Restricts Oil drilling)(Does not contain easements which affect fee parcel)
- 5 Covenants, conditions, and restrictions, in the document recorded May 22, 1931 in Book 283, Page 1 of Official Records. Modified and recorded Dec 23, 1936 in Book 283, Page 1 of Official Records. Modified and recorded Dec 23, 1936 in Book 862, Page 150 of Official Records. Modified and recorded Dec 18, 1943 in Book 1225, Page 225 of Official Records. Modified and recorded Oct 14, 1944 in Book 1288, Page 272 of Official Records. Modified and recorded Feb 13, 1948 in Book 1627, Page 495 of Official Records. Modified and recorded Aug 3, 1950 in Book 2050, Page 415 of Official Records. Modified and recorded Feb 6, 1968 in Book 8511, Page 880 of Official Records. Modified and recorded Feb 6, 1968 in Book 8511, Page 885 of Official Records. Modified and recorded Feb 6, 1968 in Book 8511, Page 918 of Official Records. Modified and recorded Sep 6, 1985 as Inst. No. 85–338088 of Official Records. Modified and recorded Dec 8, 1986 as Inst. No. 86–602137 of Official Records. Modified and recorded Nov 18, 1988 as Inst. No. 88–594765 of Official Records. Modified and recorded Apr 20, 2000 as Inst. No. 00–205298 of Official Records. Modified and recorded Dec 6, 2002 as Inst. No. 02–1104931 of Official Records. Modified and recorded Apr 2, 2009 as Inst. No. 02—1104931 of Official Records. Modified and recorded Apr 2, 2009 as Inst. No. 09—160191 of Official Records. Modified and recorded Apr 7, 2009 as Inst. No. 09-167954 of Official Records. Modified and recorded Jan 21, 2010 as Inst. No. 10-31632 of Official Records. (Affects, blanket)
- 6 An Easement for road and incidental purposes, and a 2.00' wide easement for public utilities, sewers and/or storm drains affecting that portion of Parcel 2 of LLA 99-041 per that document recorded August 28, 1935 in Book 760, Page 217 of Official Records.(Plotted Hereon)
- 7 An Easement for Public utilities and incidental purposes, Recording Date: May 14, 1940 Recording No.: Book 1041, Page 485 and Recording Date: June 13, 1942 and Recording No.: Book 1148, Page 339, Official Records. (Plotted Hereon)
- 8 An Easement for television aerial lead-in-wires, Recording Date: October 16, 1958 Recording No: Book 4450, Page 29, Official Records. (Plotted Hereon)
- 9 An Easement for Perpetual air or flight easement, also referred to as Avigation rights Recording Date: March 17, 1964 Recording No.: Book 6965, Page 721, Official Records. (Affects all the air space above said property, not plotted hereon)
- Matters contained in that certain document, Entitled Settlement and Mutual Release Agreement Dated: September 24, 1999, Recording Date: October 8, 1999, Recording No.: 1999-717080, Official Records, As Document Declaring Modifications thereof Recording Date: November 25, 2002 Recording No.: 2002-1068898, Official Records. (Plotted Hereon)
- 11 An Easement for Public utilities, sanitary sewers, and/or storm drains Recording Date: September 21, 2000 Recording No: 2000-496747, Official Records (Plotted hereon)
- 12 An Easement for Public utilities, sanitary sewers, and/or storm drains Recording Date: September 21, 2000 Recording No: 2000-496747, Official Records (Plotted hereon)
- Matters contained in that certain document Entitled Grant Deed With Reservation of Easements Dated: December 4, 2002, Recording Date: December 6, 2002, Recording No.: 2002-1104932, Official Records. (Plotted hereon)
- PARCEL B:

AN PERPETUAL, NON-EXCLUSIVE EASEMENT FOR PEDESTRIAN AND VEHICULAR INGRESS AND EGRESS PURPOSES, AS SAID EASEMENT IS SET FORTH IN THAT CERTAIN EASEMENT DEED RECORDED DECEMBER 6, 2002, AS INSTRUMENT NO. 2002-1104933, BY OFFICIAL RECORDS OF ORANGE COUNTY, CALIFORNIA. (Plotted hereon)

PARCEL 3 LLA 99-04 Existing residence PARCEL 1 Existing residence Existing residence EMERALD BAY



SCALE: 1/8"=1"

LEGEND

XXXXXXXXX

F.F.

F.S.

GRADE BREAK LINE

FENCE

MSE WALL

CONCRETE SURFACE

MASONRY WALL

WOOD WALL

ROCK WALL

FINISHED FLOOR

FINISHED SURFACE

TOP OF GRATE

INVERT OF PIPE

TOP OF CURB

TOP OF WALL

EDGE OF PAVEMENT

FOUND MONUMENT

SURVEY CONTROL POINT

INDEX CONTOUR LINE

INTERMEDIATE CONTOUR LINE

ESTIMATED PROPERTY LINE

9 4 9 . 4 9 2 . 8 5 8 6 www.toalengineering.com VIKTOR P. MEUM P.L.S. 8682 DATE: 4-19-2021

PLANS PREPARED BY:

CIVIL ENGINEERING LAND SURVEYING

STORMWATER QUALITY

139 Avenida Navarro

San Clemente, CA 92672

PREPARED FOR: STEVE AND KERI OLSON

H. SCALE: 4-21-20 V. SCALE: 4-8-20 DWG. NO.

SURVEY DATE: DRN.: MSF

APPD.: VM JOB NO. 20053

BOUNDARY NOTE:


BENCHMARK NOTE: OCSBM 3K-56-04

NAVD88 DATUM, 2004 ADJ.

ELEV=85.701

THE PLAT SHOWN HEREON REPRESENTS A BEST FIT OF THE RECORD BOUNDARY TO THE FOUND MONUMENTS

AND LINES OF OCCUPATION. IT SHALL NOT BE CONSIDERED THE FINAL BOUNDARY, AND A BOUNDARY SURVEY IS RECOMMENDED PRIOR TO DESIGN OR CONSTRUCTION OF IMPROVEMENTS.

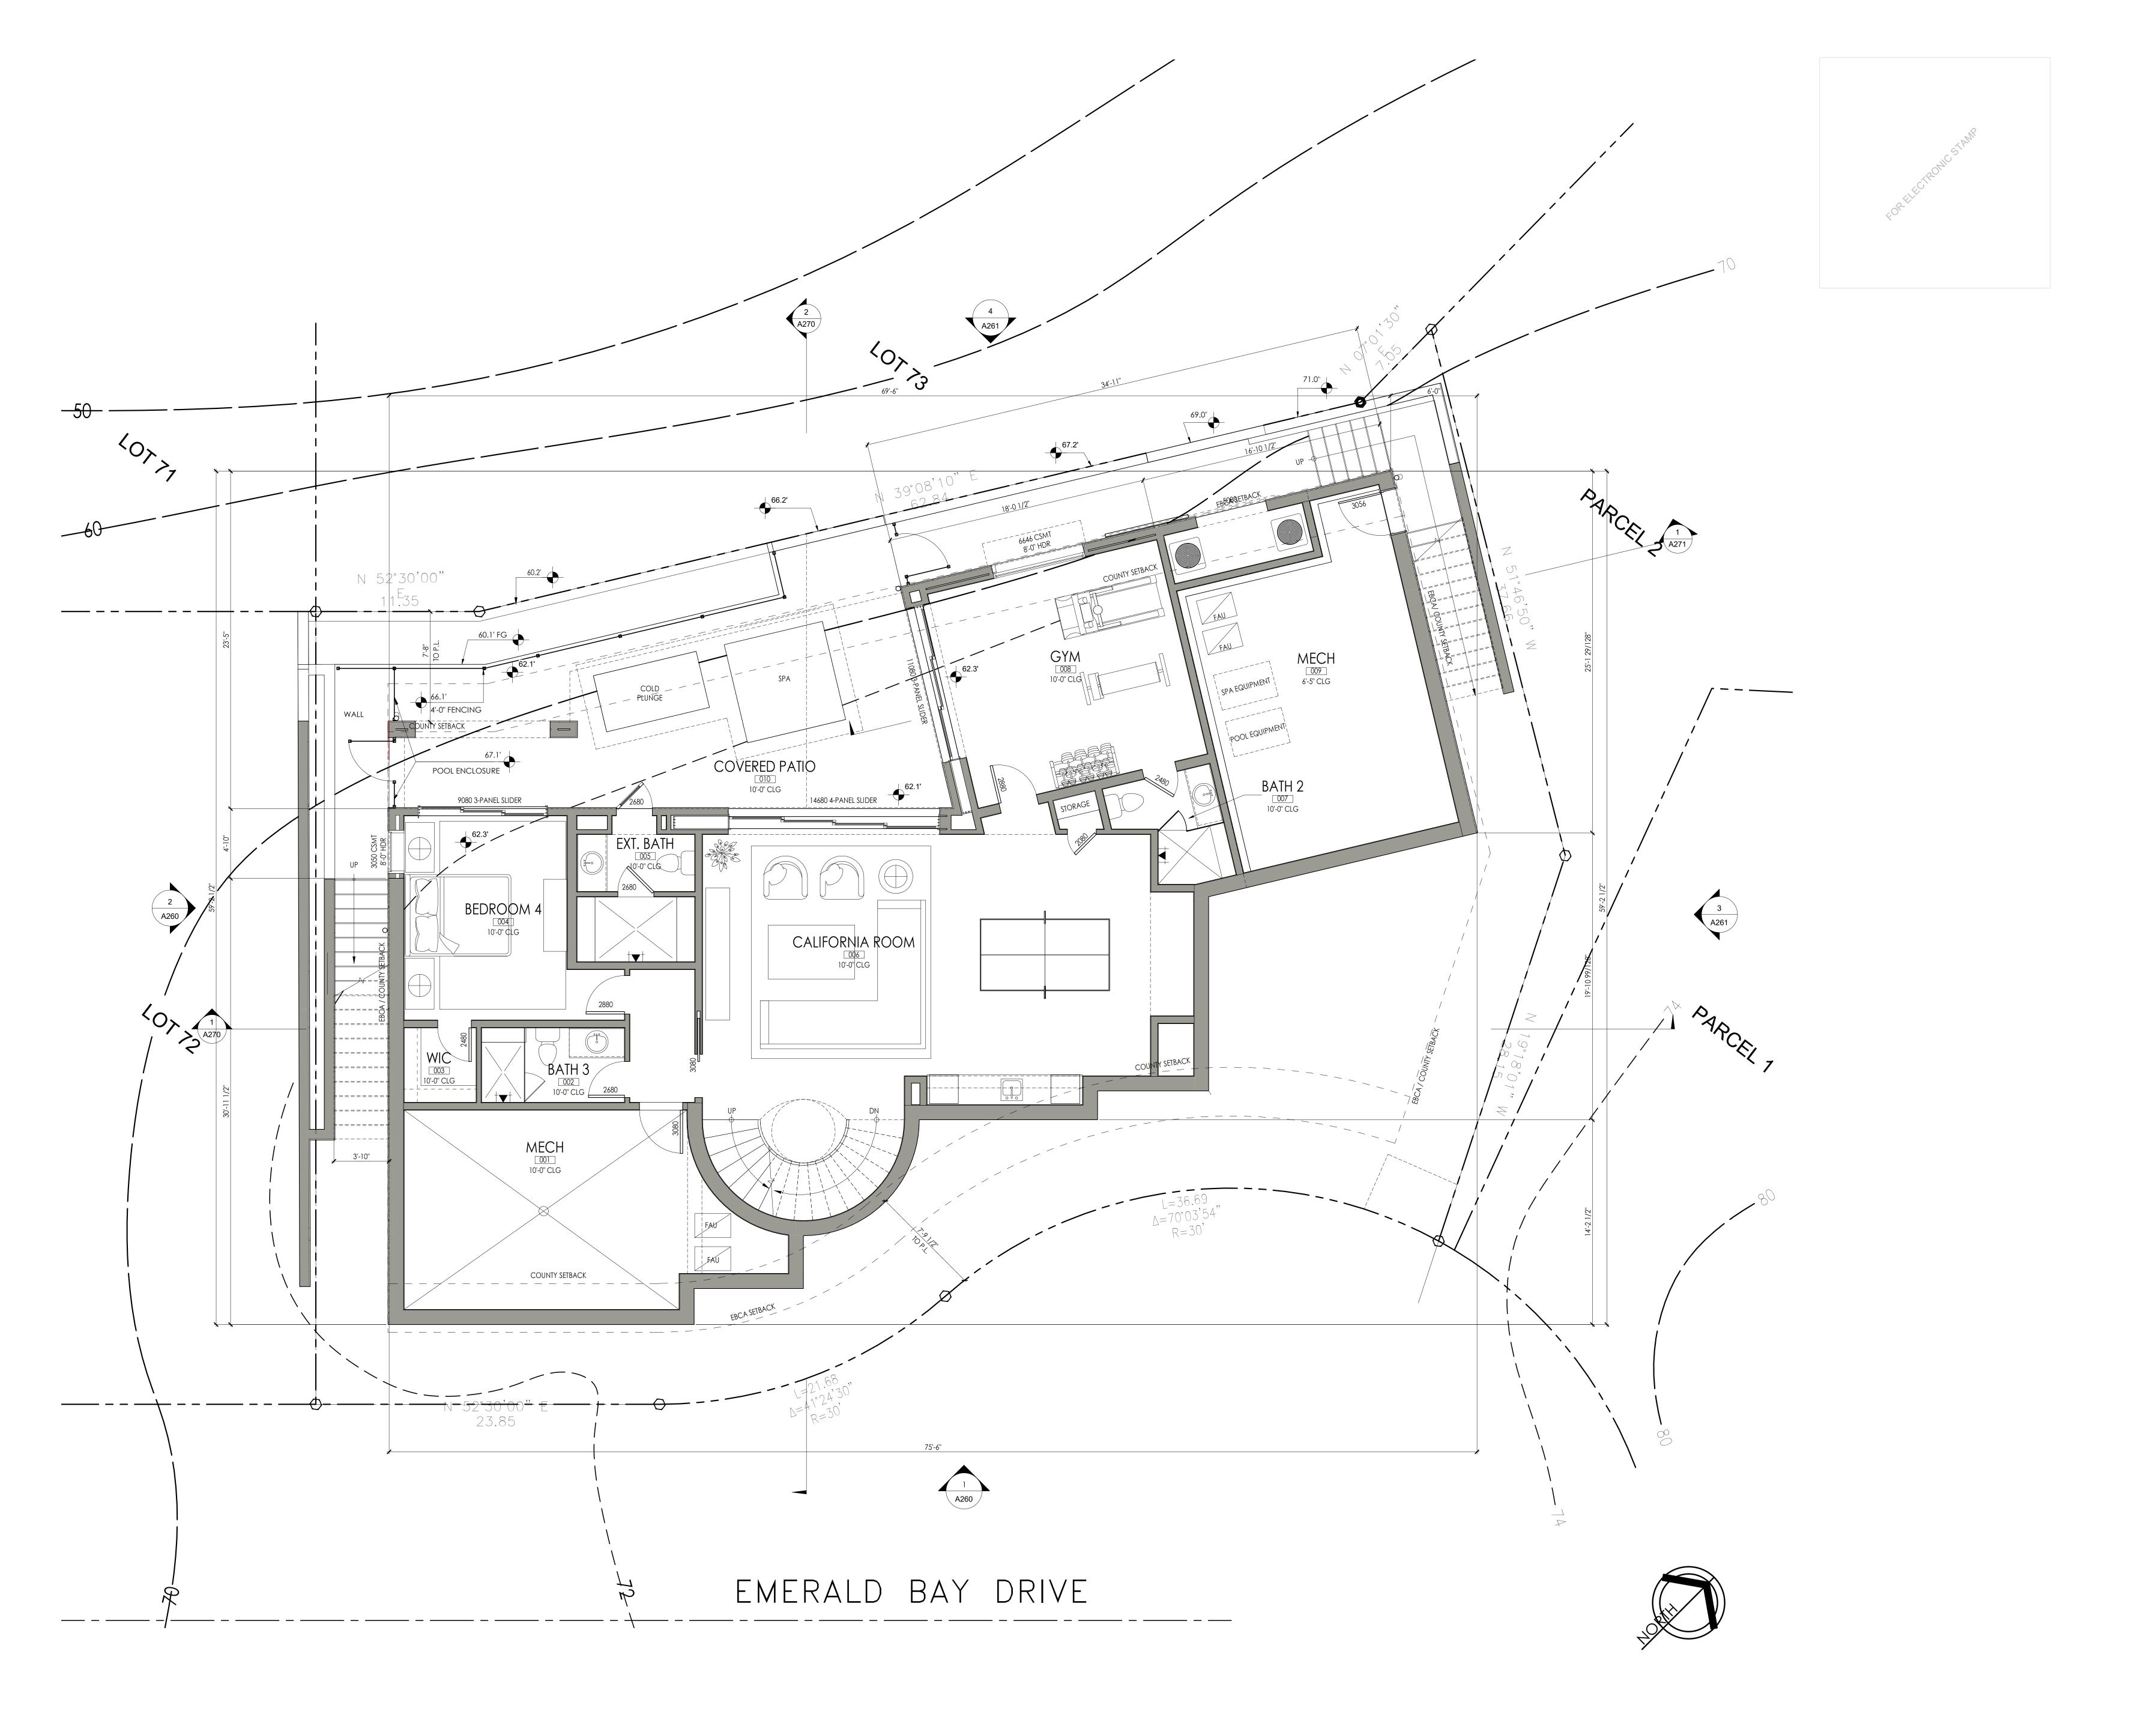








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BASEMENT LEVEL REFERENCE





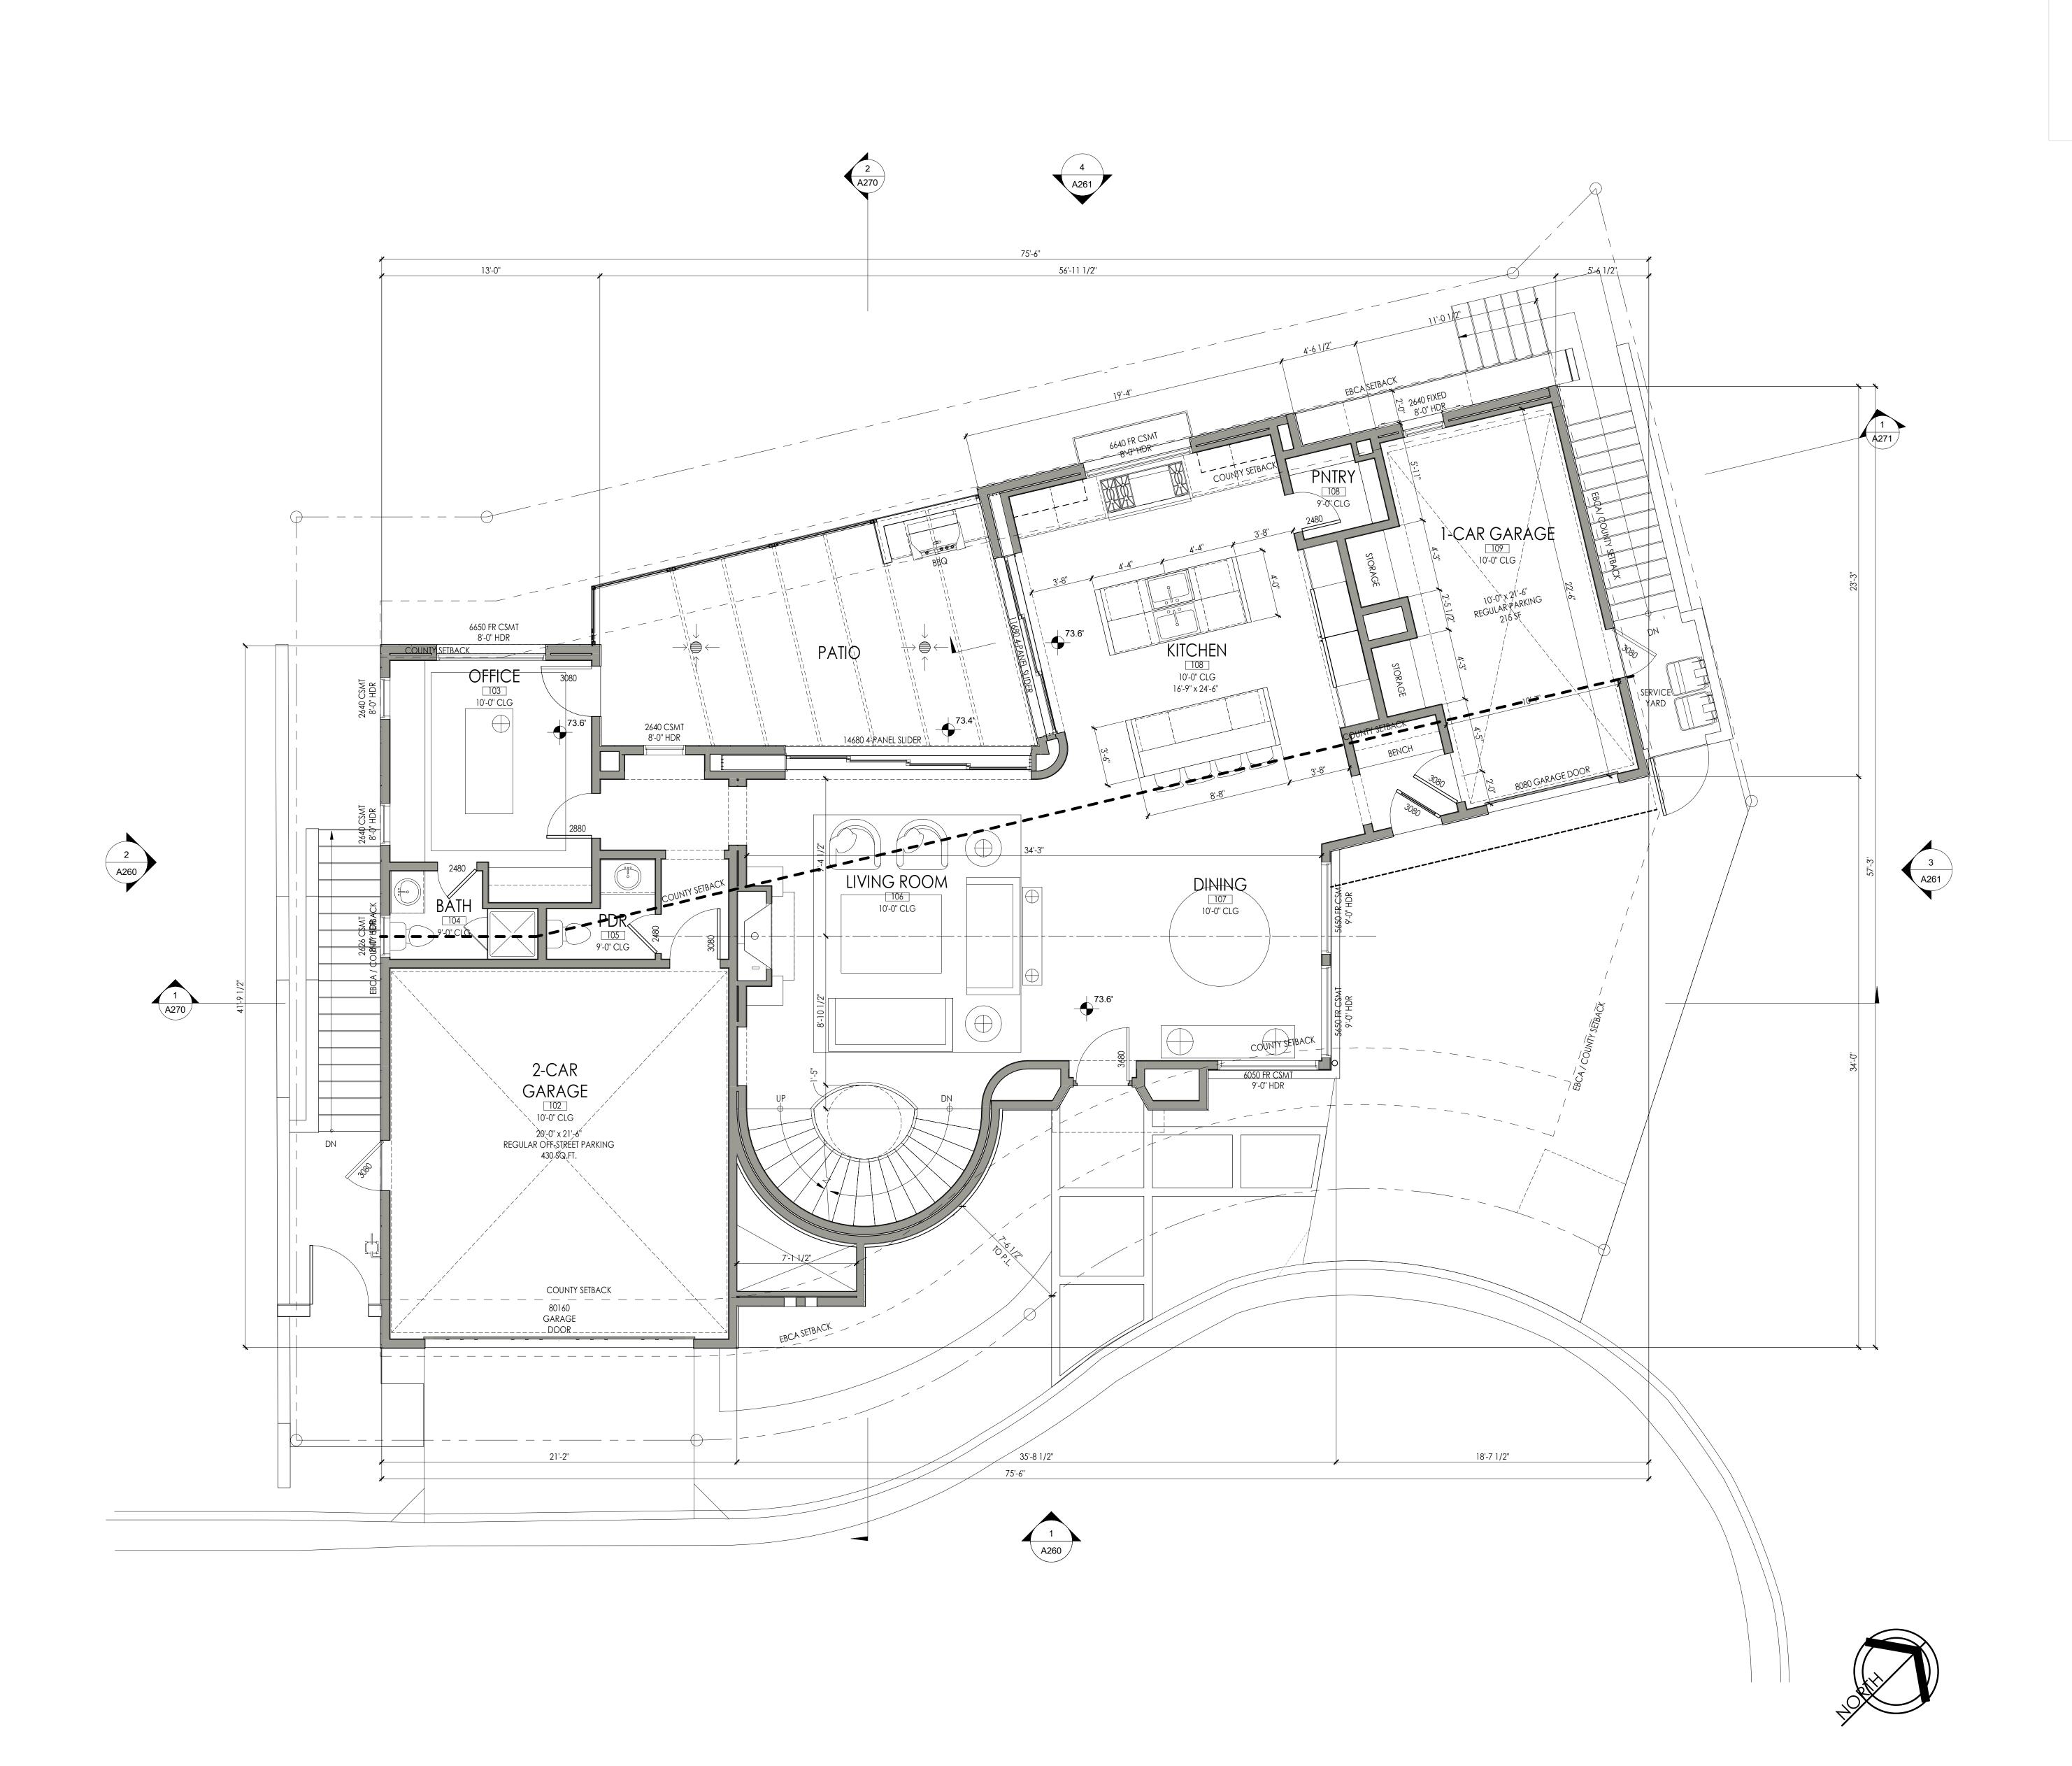

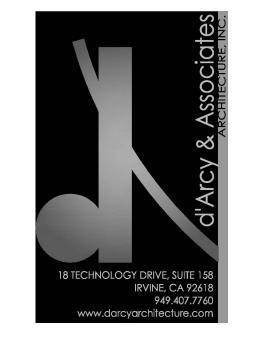
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MAIN LEVEL REFERENCE

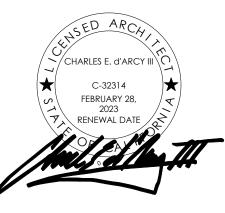A220







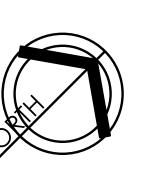



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> UPPER LEVEL REFERENCE

A230





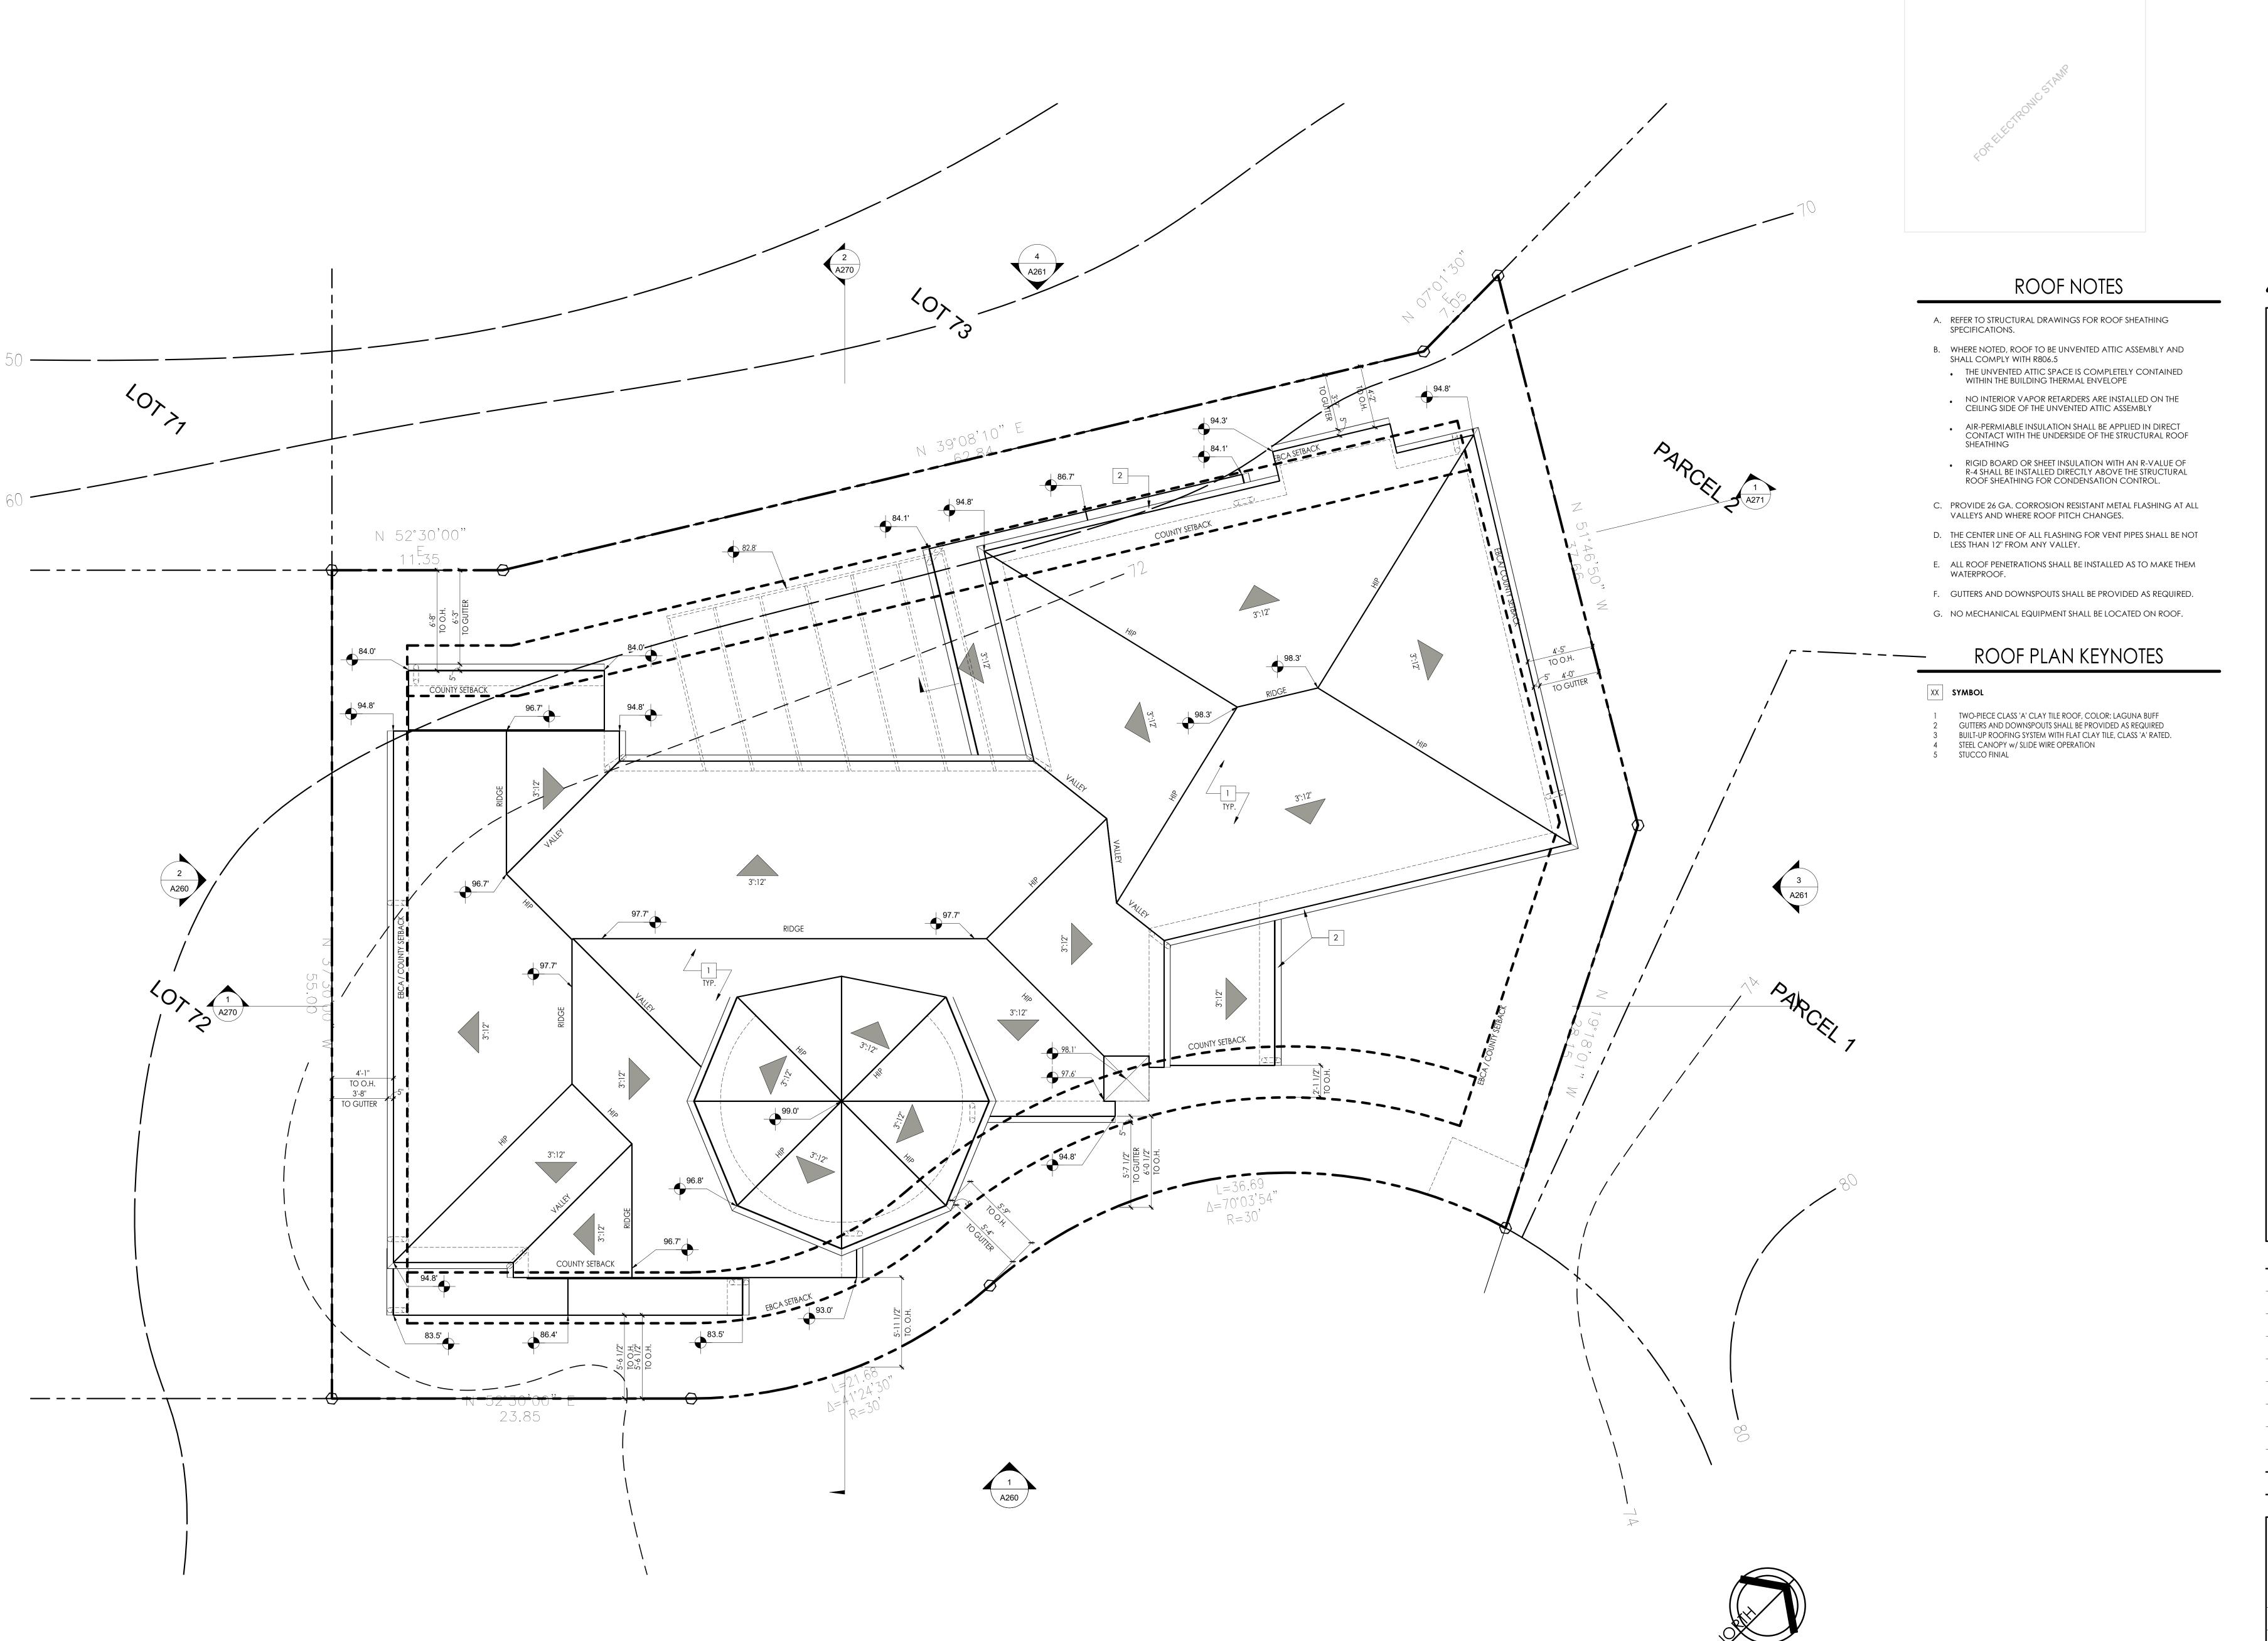
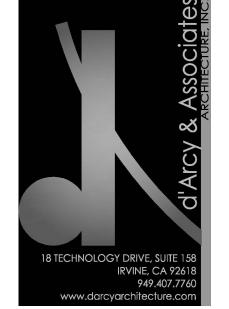
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ROOF PLAN

SCALE: 1/4" = 1'-0"











EXTERIOR ELEVATION NOTES

- CONSTRUCTION METHODS AND CONDITIONS.
- C. REFER TO CIVIL AND HARDSCAPE PLANS FOR FINISH GRADE ELEVS.

- 7/8" MIN. EXTERIOR CEMENT PLASTER, SMOOTH TROWEL FINISH. PAINT: OMEGA 431 TWO-PIECE CLASS 'A' CLAY TILE ROOF WITH MUD BOOST, LAGUNA BUFF BLEND RECLAIMED WOOD RAFTER TAILS
- STEEL CANOPY STRUCTURE w/ SLIDE WIRE OPERATION DARK ANODIZED BRONZE ALUMINUM DOOR & WINDOW SYSTEMS
- LOUVERED MECHANICAL DOORS, RECLAIMED WOOD TO MATCH STUCCO FINIAL
- 42" WROUGHT IRON GUARDRAILING
- COPPER ROOF GUTTER & DOWNSPOUTS
 RECLAIMED WOOD GATE, 5'-0" HT. MIN. (POOL ENCLOSURE)
 NEW EXTERIOR LIGHT SCONCE, HILLGATE LANTERN PER SELECTION
- 14 48" WROUGHT IRON FENCING (@ POOL ENCLOSURE)
- RECLAIMED WOOD TRIM
- RECLAIMED WOOD PLANT LEDGE/SHELF
- 19 DECORATIVE WOOD BRACKET DETAIL BELOW CANTILEVERED FLOOR SYSTEM

- A. REFER TO GENERAL NOTES SHEETS FOR THE GENERAL
- B. ALL VERTICAL DIMENSIONS SHOWN ARE FROM FINISH FLOOR (TOP OF SHEATHING) U.N.O.
- AND STEP LOCATIONS.

EXTERIOR ELEVATION KEYNOTES

XX SYMBOL

- COPPER ROOF FINIAL

- **BBQ LOCATION**
- CLAY VENT PIPES TRIANGULAR PATTERN
- 18 12" STUCCO CHAMFERED SILLS
- 20 GARAGE DOOR (RECLAIMED BARN WOOD) 21 RECLAIMED WOOD SHUTTERS WITH IRON ACCENTS & DETAILS
- 21 RECLAIMED WOOD SHUTTERS WITH IRON ACCENTS & DETAILS
 22 SPLAYED DECORATIVE STUCCO SURROUND @ ENTRY
 23 DIAMOND CUT FOAM INSERT w/ STUCCO FINISH TO MATCH
 24 WHITE OVERGROUTED BRICK
 25 WHITE OVERGROUTED BRICK CORBELING
 26 WHITE OVER GROUTED BRICK HEADER/ SILL DETAILING
 27 DOG TOOTH BRICK DETAIL BANDING
 28 WROUGHT IRON JULIET BALCONY
 29 RECLAIMED WOOD DOOR w/ GLASS INSERTS
 30 60" WROUGHT IRON GUARDRAILING


REVISIONS


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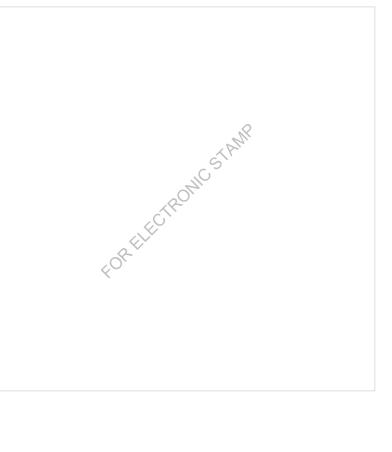
07/08/2022

EXTERIOR ELEVATIONS

SCALE: 1/4" = 1'-0"



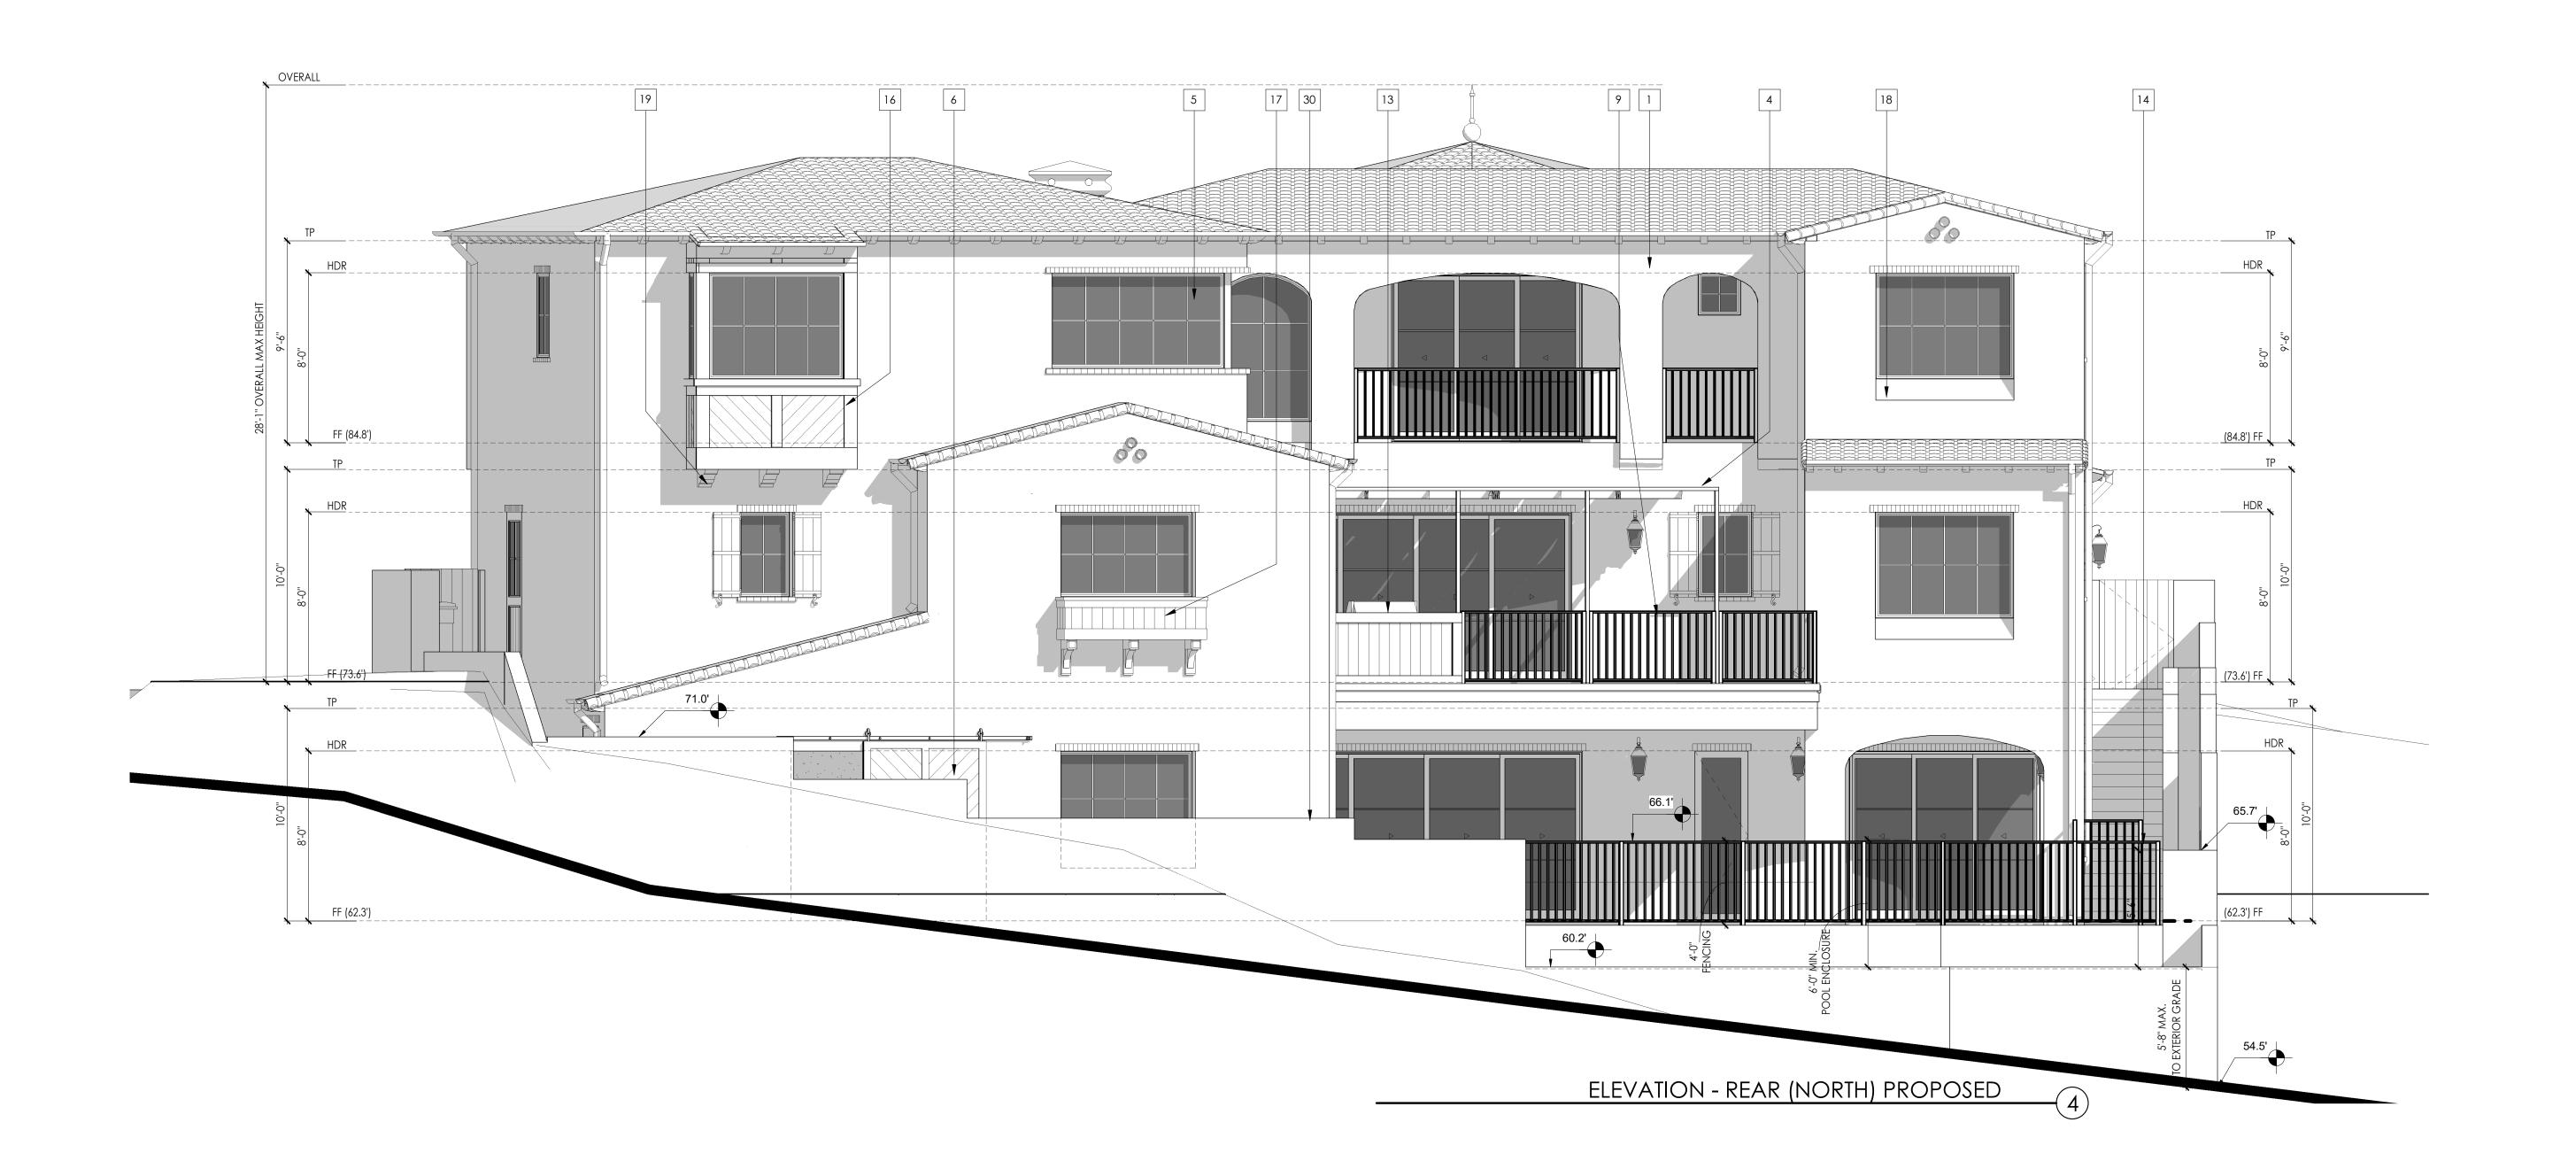

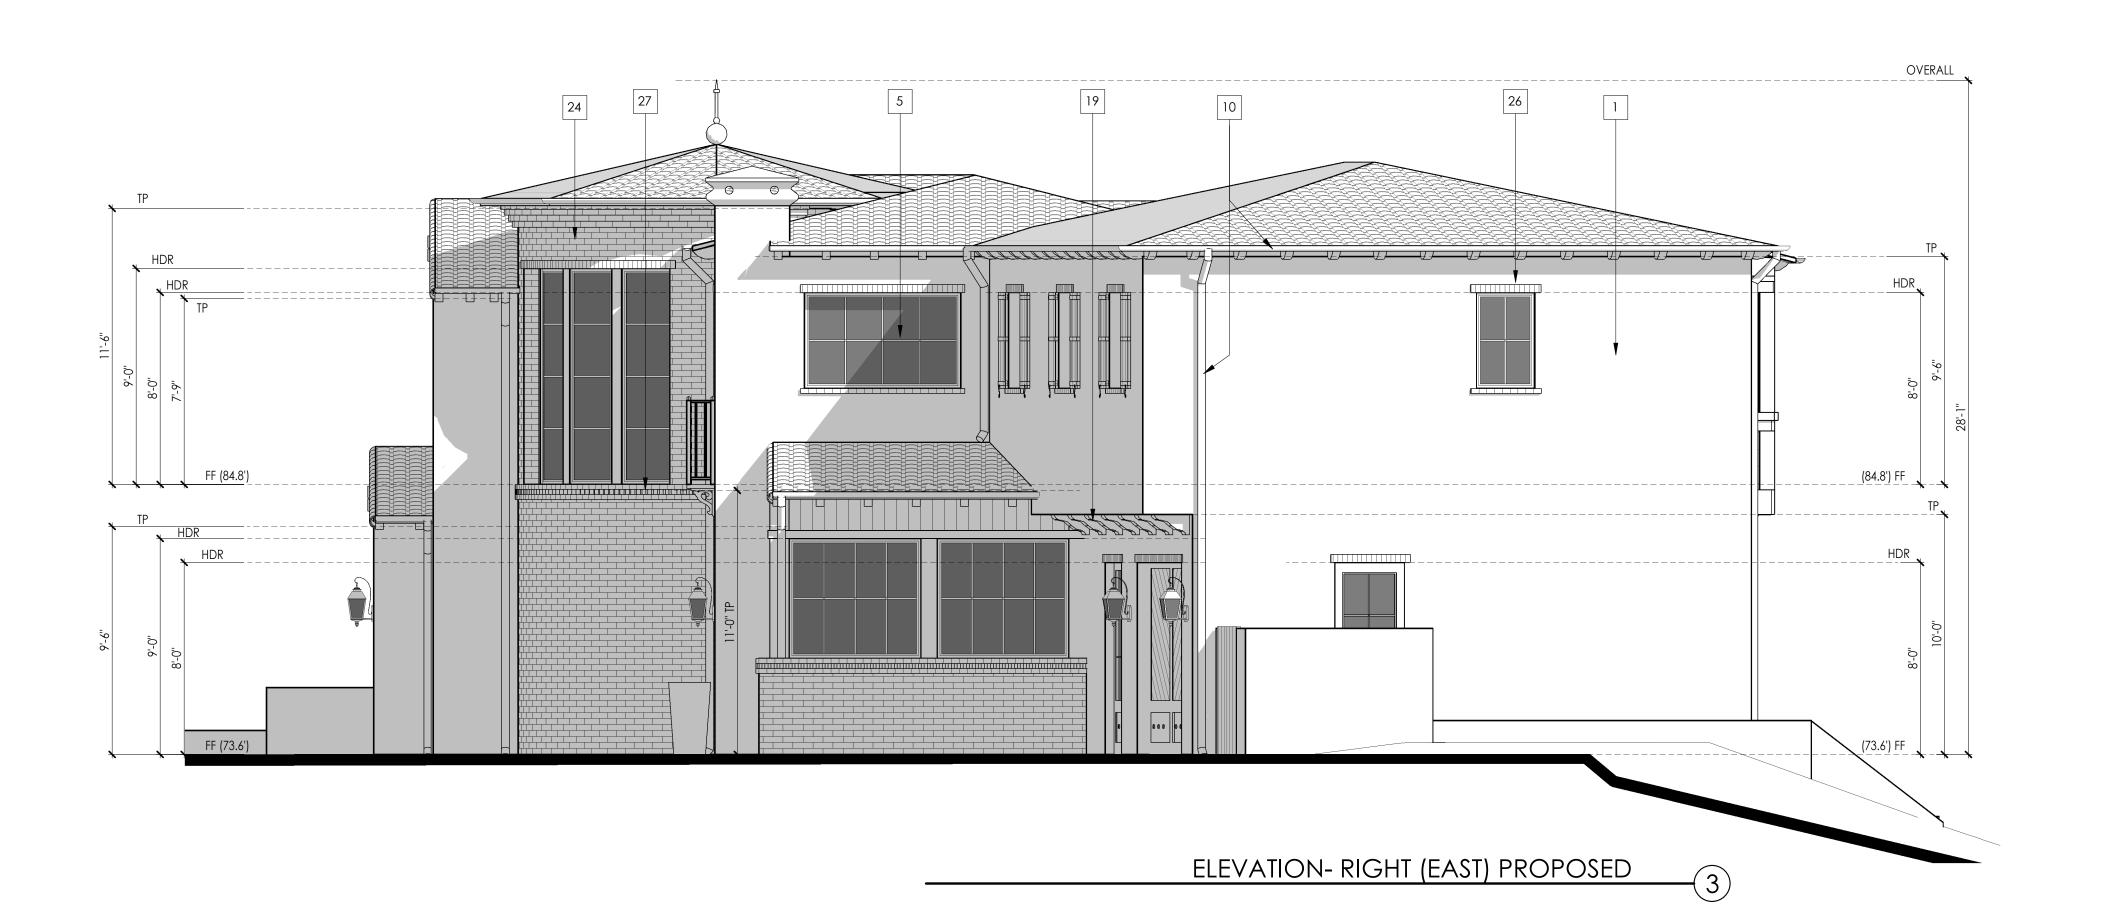



- A. REFER TO GENERAL NOTES SHEETS FOR THE GENERAL CONSTRUCTION METHODS AND CONDITIONS.
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- C. REFER TO CIVIL AND HARDSCAPE PLANS FOR FINISH GRADE ELEVS. AND STEP LOCATIONS.

EXTERIOR ELEVATION KEYNOTES

XX SYMBOL


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- STEEL CANOPY STRUCTURE W/ SLIDE WIRE OPERATION DARK ANODIZED BRONZE ALUMINUM DOOR & WINDOW SYSTEMS LOUVERED MECHANICAL DOORS, RECLAIMED WOOD TO MATCH
- STUCCO FINIAL COPPER ROOF FINIAL
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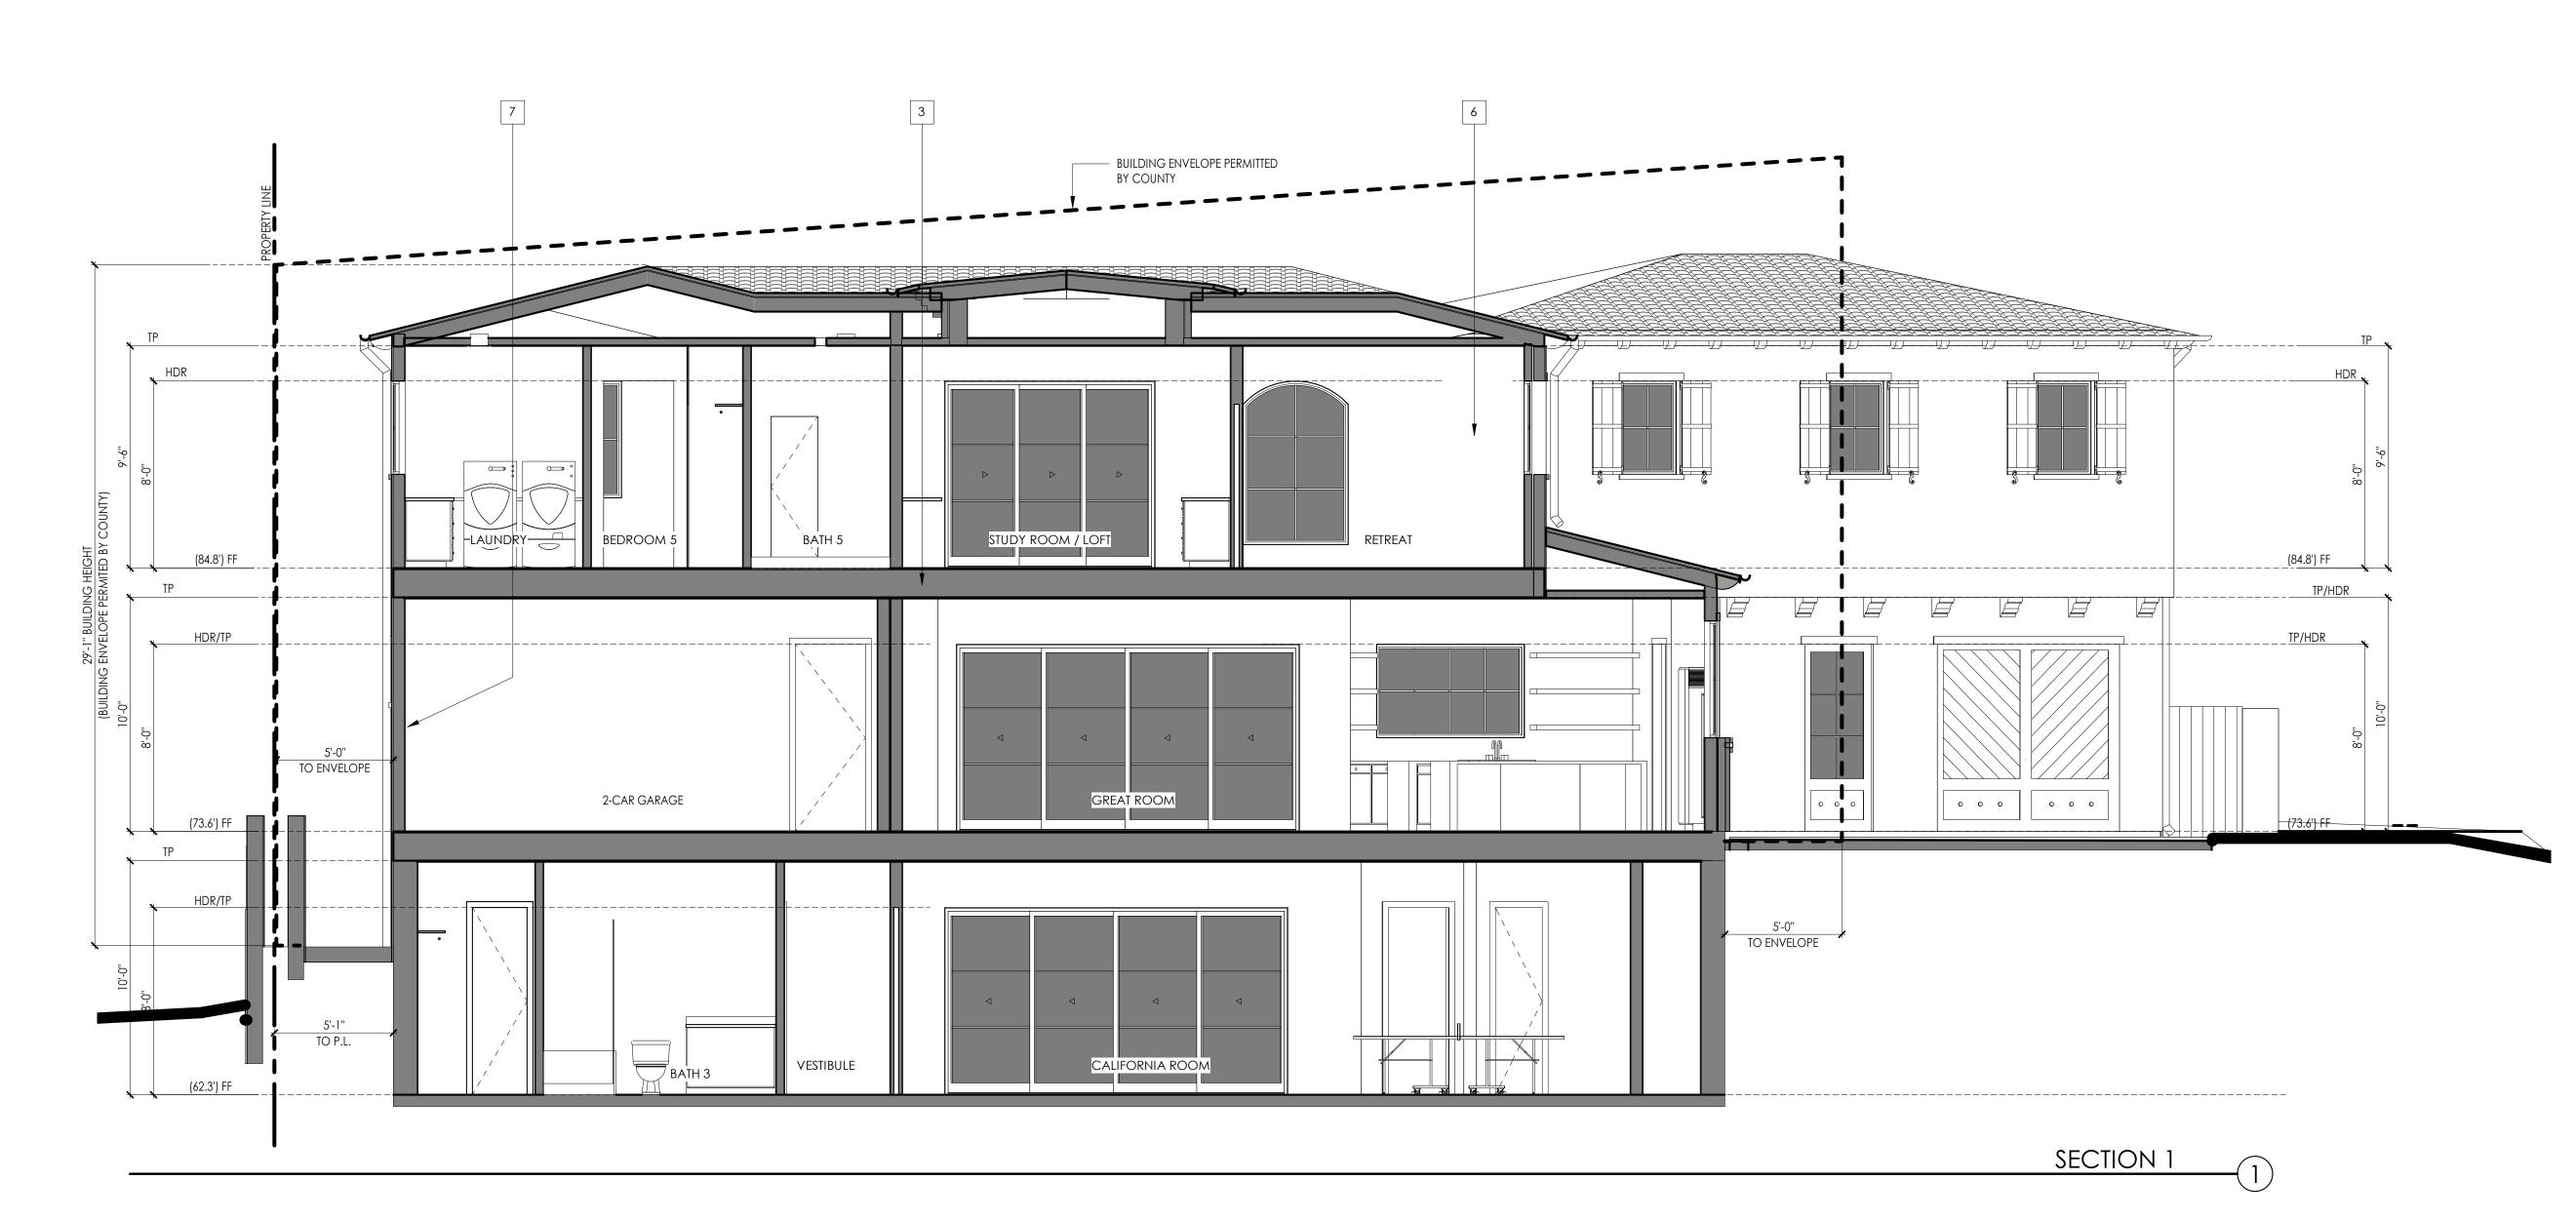
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EXTERIOR ELEVATIONS

A261







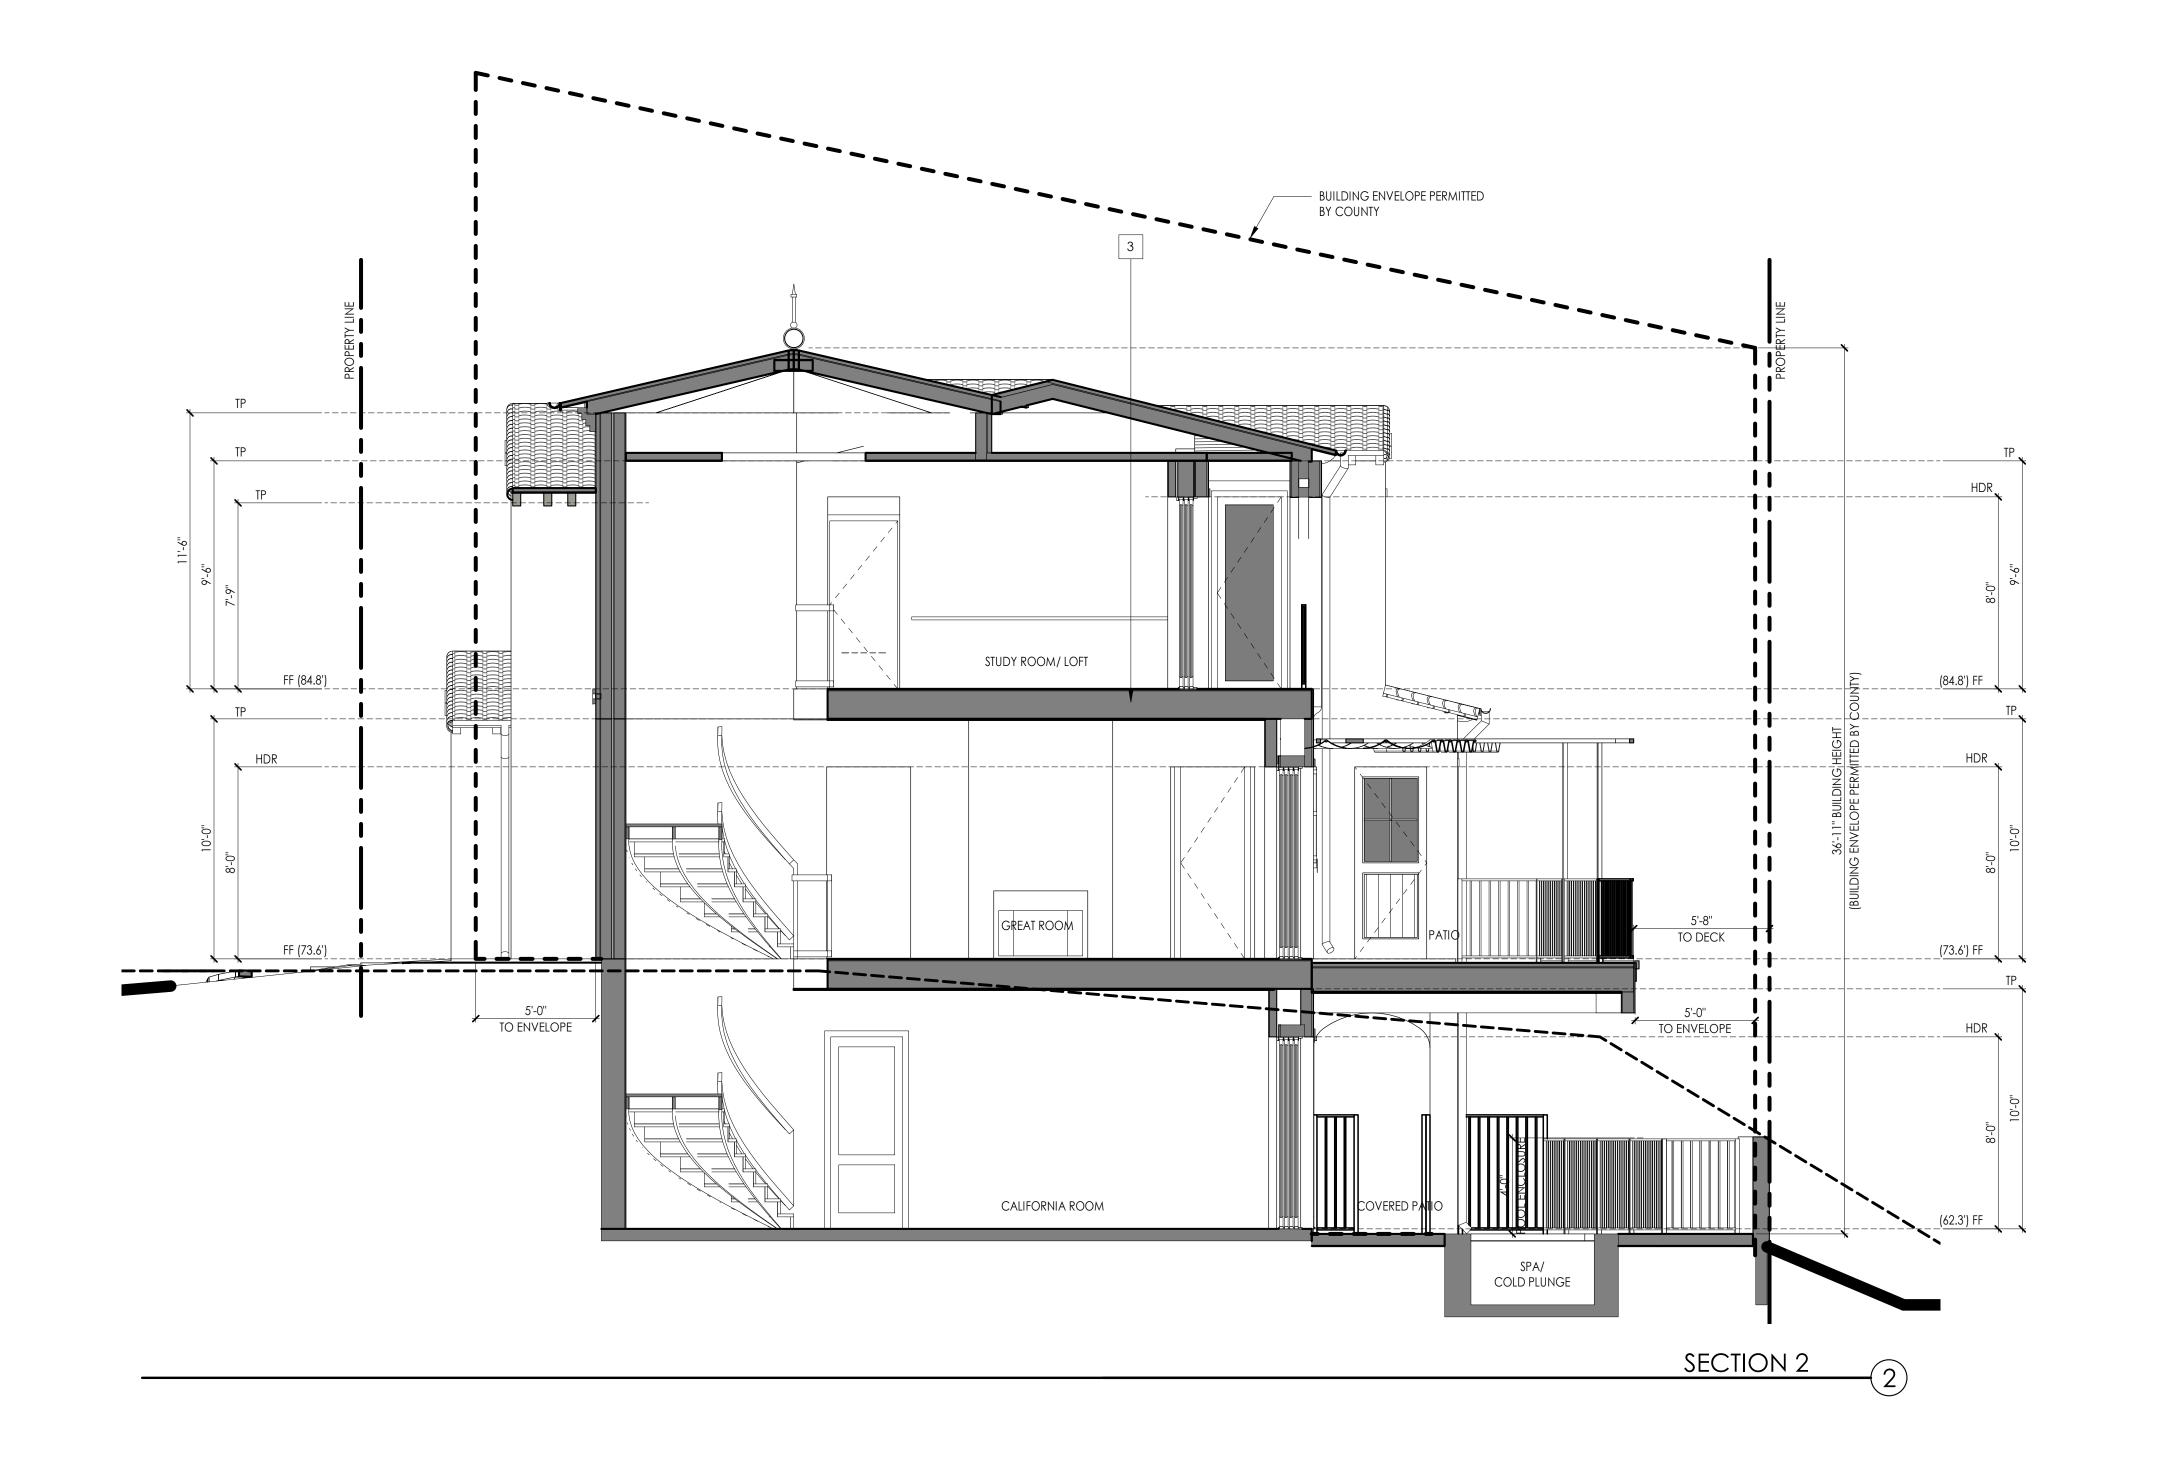



BUILDING SECTION NOTES

- A. REFER TO GENERAL NOTES SHEETS FOR THE GENERAL CONSTRUCTION METHODS AND CONDITIONS.
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- C. REFER TO CIVIL AND HARDSCAPE PLANS FOR FINISH GRADE ELEVS. AND STEP LOCATIONS.

CALCULATIONS FOR ALL STRUCTURAL INFORMATION.

- D. THE FOUNDATION AND FRAMING ELEMENTS SHOWN ARE FOR REFERENCE ONLY. REFER TO THE STRUCTURAL PLANS, DETAILS AND
- E. PROVIDE FIREBLOCKING AND DRAFT STOPS AT FURRED SPACES PER CODE.
- F. INSULATION REQUIREMENTS PER T-24 ENERGY REPORT: R-13 INSULATION IN EXTERIOR WALLS TYP. R-19 INSULATION IN RAISED WOOD FLOOR SPACE TYP.
- R-30 INSULATION IN CEILING SPACE TYP. (R-30 HIGH DENSITY 7.25" THICK "ROXUL COMFORTBATT" INSULATION AS NEEDED.)
- G. WINDOW HEADERS ARE AT 8'-0" TYP. U.N.O. ON ELEVATIONS OR

BUILDING SECTION KEYNOTES

- ROOF SHEATHING: REFER TO FRAMING PLANS ROOF RAFTERS : REFER TO FRAMING PLANS
- FLOOR JOISTS : REFER TO FRAMING PLANS 4 CEILING JOISTS : REFER TO FRAMING PLANS
- 5 SLAB ON GRADE: REFER TO FOUNDATION PLAN INTERIOR FINISH : INTERIOR WALLS SHALL BE COVERED WITH ONE LAYER 1/2" THICK
- MIN. GYPSUM WALLBOARD, SCREWED DIRECTLY TO STUDS AND JOISTS, WITH ALL SEAMS TAPED AND FILLED FLUSH WITH APPROVED JOINT COMPOUND, PER MANUF SPECS, UNLESS NOTED OTHERWISE. PROVIDE WATER RESISTANT GYPSUM WALLBOARD AT ALL BATH AND KITCHEN AREAS.
 - INTERIOR FLOORS SHALL BE FINISHED WITH WOOD, OR THINSET TILE IN WET AREAS, PER INTERIOR DESIGNER SPECIFICATIONS. GARAGE AND MECHANICAL ROOM(S) FLOORS TO BE FINISHED CONCRETE. OCCUPANCY SEPARATION: MINIMUM 1/2" GYPSUM BOARD AT ALL GARAGE WALLS & CEILINGS. MINIMUM 5/8" TYPE 'X' GYPSUM BOARD AT GARAGE CEILINGS BELOW HABITABLE SPACE PER CRC R302.6. DUCTS PENETRATING WALL OR CEILING SEPARATIONS SHALL BE CONSTRUCTED OF MINIMUM 26 GAUGE SHEET METAL AND SHALL


HAVE NO OPENINGS INTO THE GARAGE, PER CRC 302.5.2.

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BUILDING SECTIONS

A270





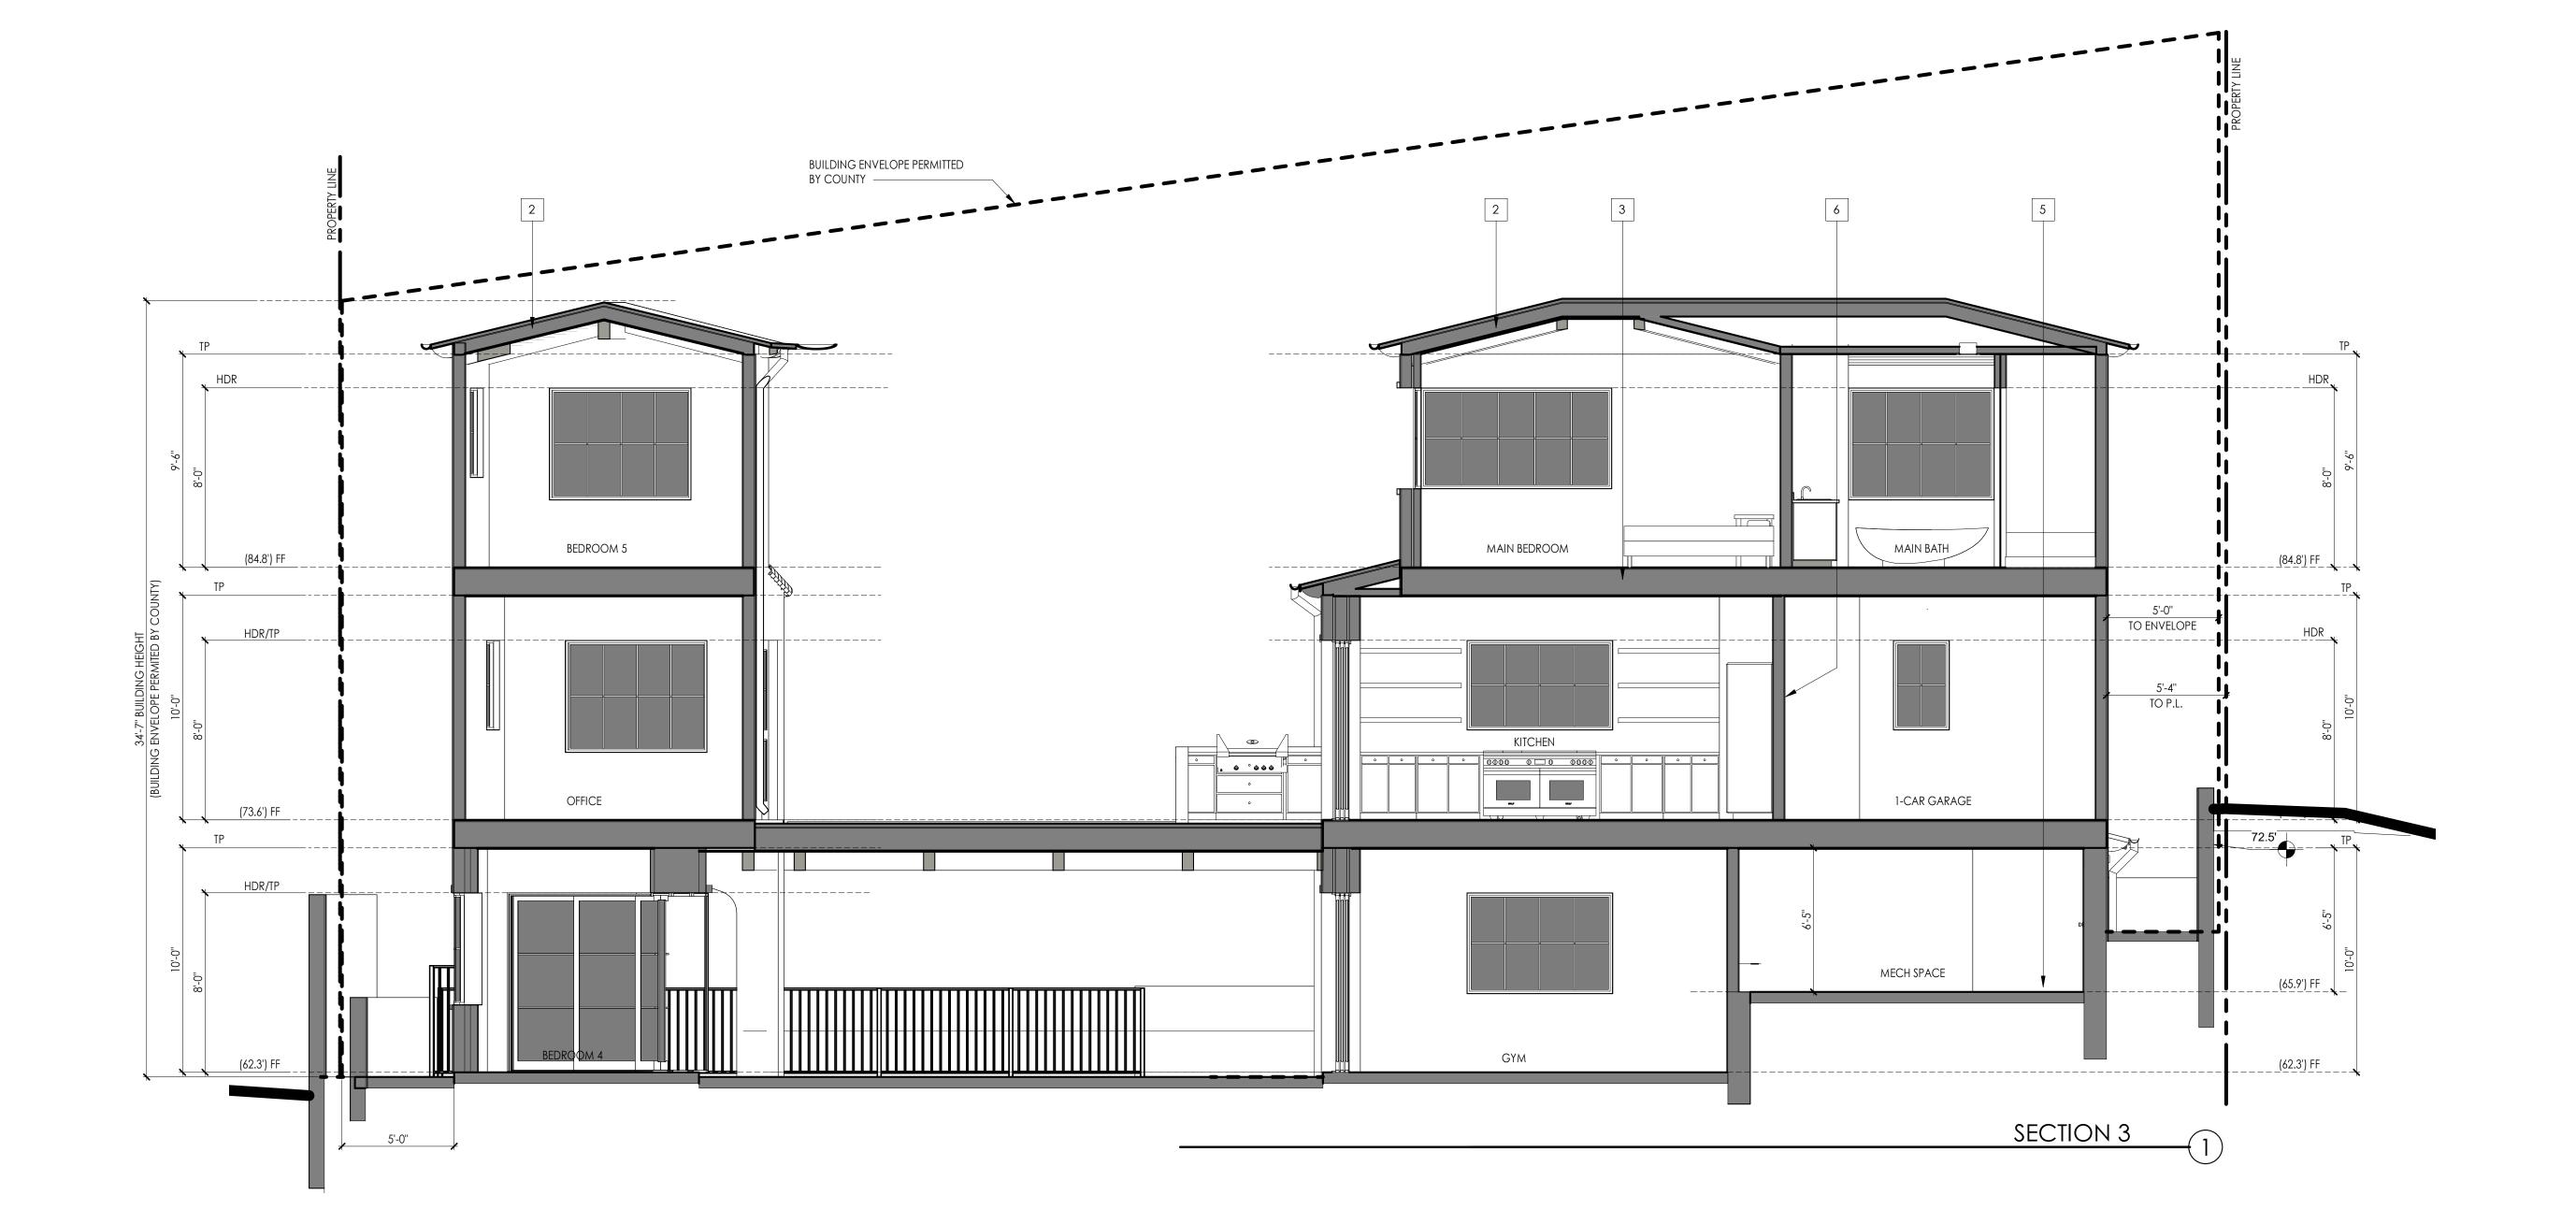



BUILDING SECTION NOTES

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 E. PROVIDE FIREBLOCKING AND DRAFT STOPS AT FURRED SPACES PER
- CODE.

 F. INSULATION REQUIREMENTS PER T-24 ENERGY REPORT:
- R-13 INSULATION IN EXTERIOR WALLS TYP. R-19 INSULATION IN RAISED WOOD FLOOR SPACE TYP. R-30 INSULATION IN CEILING SPACE TYP.
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BUILDING SECTION KEYNOTES

XX SY

- 1 ROOF SHEATHING: REFER TO FRAMING PLANS 2 ROOF RAFTERS: REFER TO FRAMING PLANS
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- INTERIOR WALLS SHALL BE COVERED WITH ONE LAYER 1/2" THICK MIN. GYPSUM WALLBOARD, SCREWED DIRECTLY TO STUDS AND JOISTS, WITH ALL SEAMS TAPED AND FILLED FLUSH WITH APPROVED JOINT COMPOUND, PER MANUF SPECS, UNLESS NOTED OTHERWISE. PROVIDE WATER RESISTANT GYPSUM WALLBOARD AT ALL BATH AND KITCHEN AREAS.

 INTERIOR FLOORS SHALL BE FINISHED WITH WOOD, OR THINSET TILE
- INTERIOR FLOORS SHALL BE FINISHED WITH WOOD, OR THINSET TILE
 IN WET AREAS, PER INTERIOR DESIGNER SPECIFICATIONS. GARAGE
 AND MECHANICAL ROOM(S) FLOORS TO BE FINISHED CONCRETE.


 OCCUPANCY SEPARATION: MINIMUM 1/2" GYPSUM BOARD AT
 ALL GARAGE WALLS & CEILINGS. MINIMUM 5/8" TYPE 'X' GYPSUM
 BOARD AT GARAGE CEILINGS BELOW HABITABLE SPACE PER CRC
 R302.6. DUCTS PENETRATING WALL OR CEILING SEPARATIONS SHALL BE
 CONSTRUCTED OF MINIMUM 26 GAUGE SHEET METAL AND SHALL
 HAVE NO OPENINGS INTO THE GARAGE, PER CRC 302.5.2.

OLSON RESIDENCI

JOB # 2143

BUILDING SECTIONS

07/08/2022

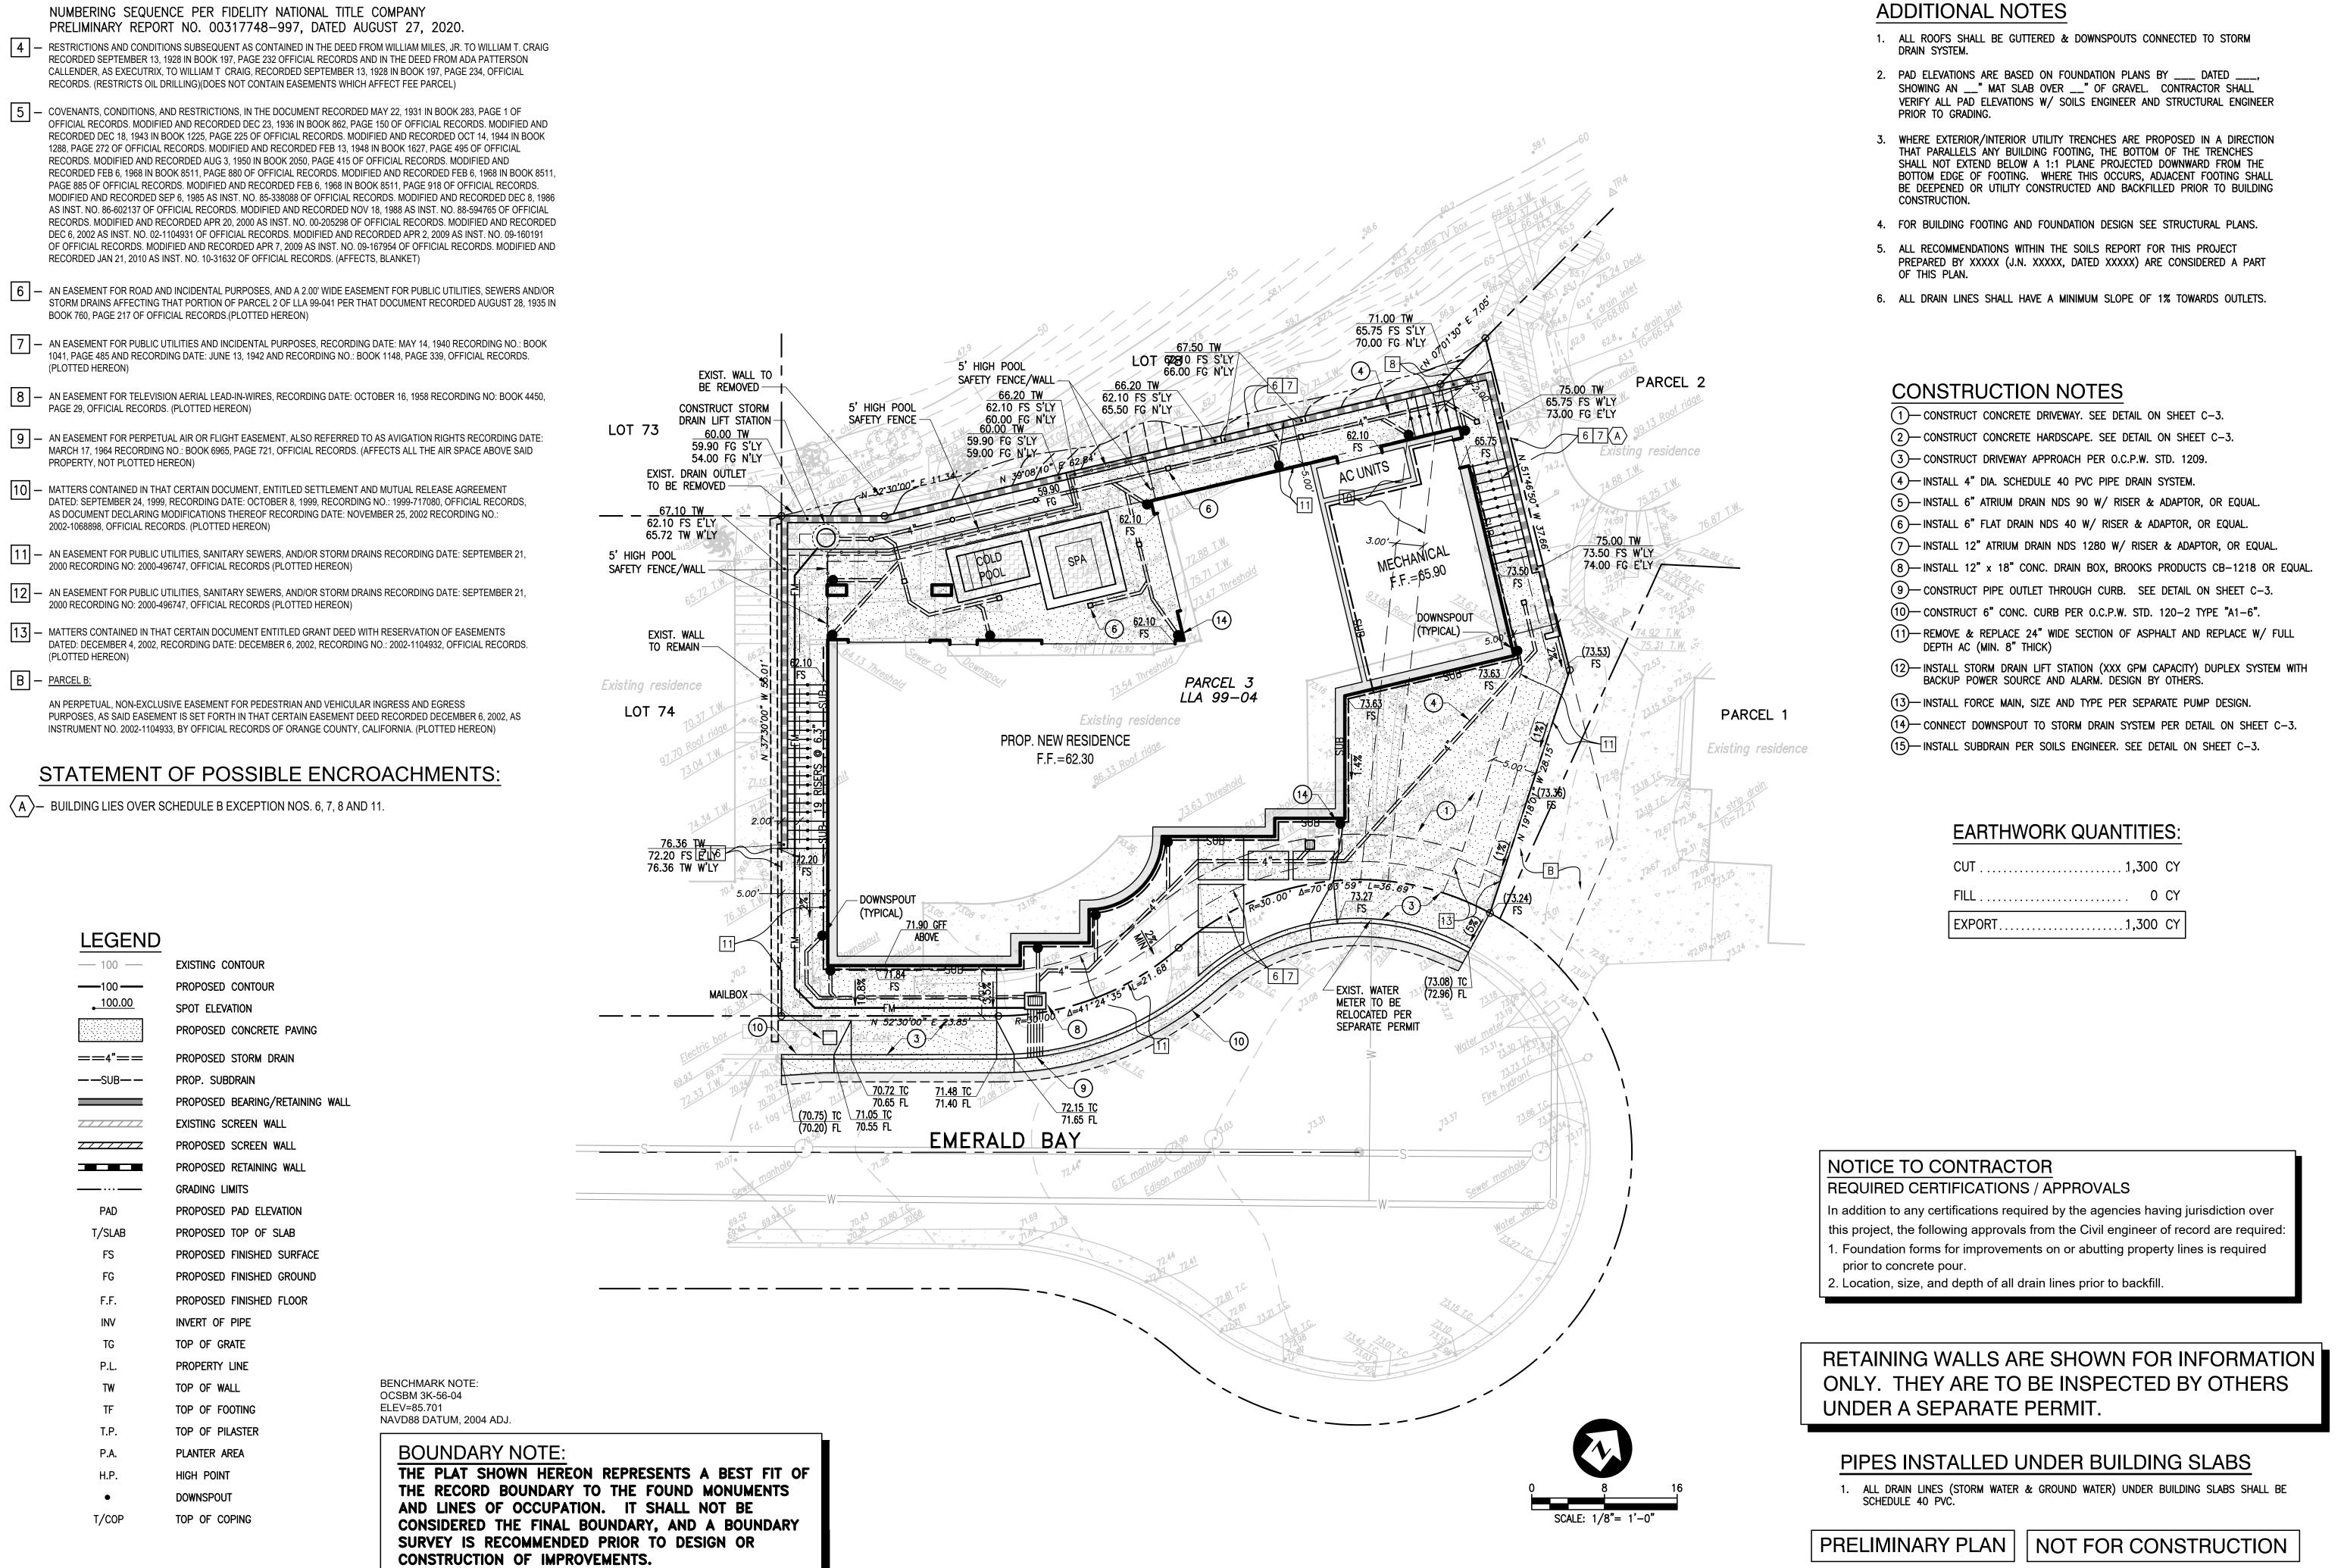


EASEMENT NOTES:

PLANS PREPARED BY:

TOAL ENGINEERING, INC.

CIVIL ENGINEERING LAND SURVEYING STORMWATER QUALITY

139 Avenida Navarro San Clemente, CA 92672 9 4 9 . 4 9 2 . 8 5 8 6 www.toalengineering.com

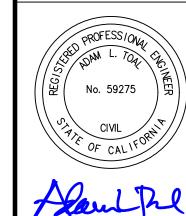

ADAM L. TOAL R.C.E. 59275 DATE: 5 23 22

PREPARED FOR:

d'Arcy & Assoc. Architecture 18 TECHNOLOGY DRIVE, SUITE 158 IRVINE, CA 92618 TEL: (949) 407-7760

S I O N S BY DATE APVD.

CRADING PLAN

PRELIMINARY GRA


COUNTY OF ORANGE PLAN CHECK NO.







RECLAIMED TERRACOTTA STEPS

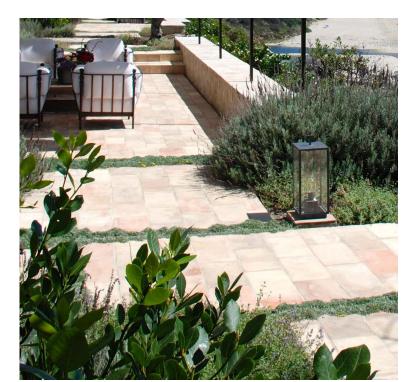

RECLAIMED TERRACOTTA PAVERS







COBBLESTONE DRIVEWAY PAVING

OLSON RESIDENCE HARDSCAPE LEGEND

- NEW GROUTED COBBLESTONE DRIVEWAY W/ DECORATIVE BANDING
- 2. NEW ANTIQUE TERRACOTTA PAVING
- 3. NEW ANTIQUE TERRA COTTA STEPS
- 4. NEW 5'-6" SELF-CLOSING, SELF-LATCHING GATE (5' HT.)
- 5. EXISTING AIR CONDITIONER LOCATION
- PROPOSED A/C UNIT LOCATION
- EXISTING RETAINING WALL TO BE REMAIN
- 9. NEW MASONRY RETAINING WALLS (NOT TO EXCEED 6' FROM FINISH GRADE TO TOP OF WALL - OUTSIDE OF PL.)
- 10. BBQ COUNTER
- 11. PLANTING AREA
- 12. 7' x 7' BUILT-IN SPA
- 13. 4' x 7'-4" COLD PLUNGE
- 14. MAILBOX LOCATION REFER TO ARCHITECT'S PLAN FOR DETAIL
- 15. EXISTING PROPERTY WALL TO REMAIN

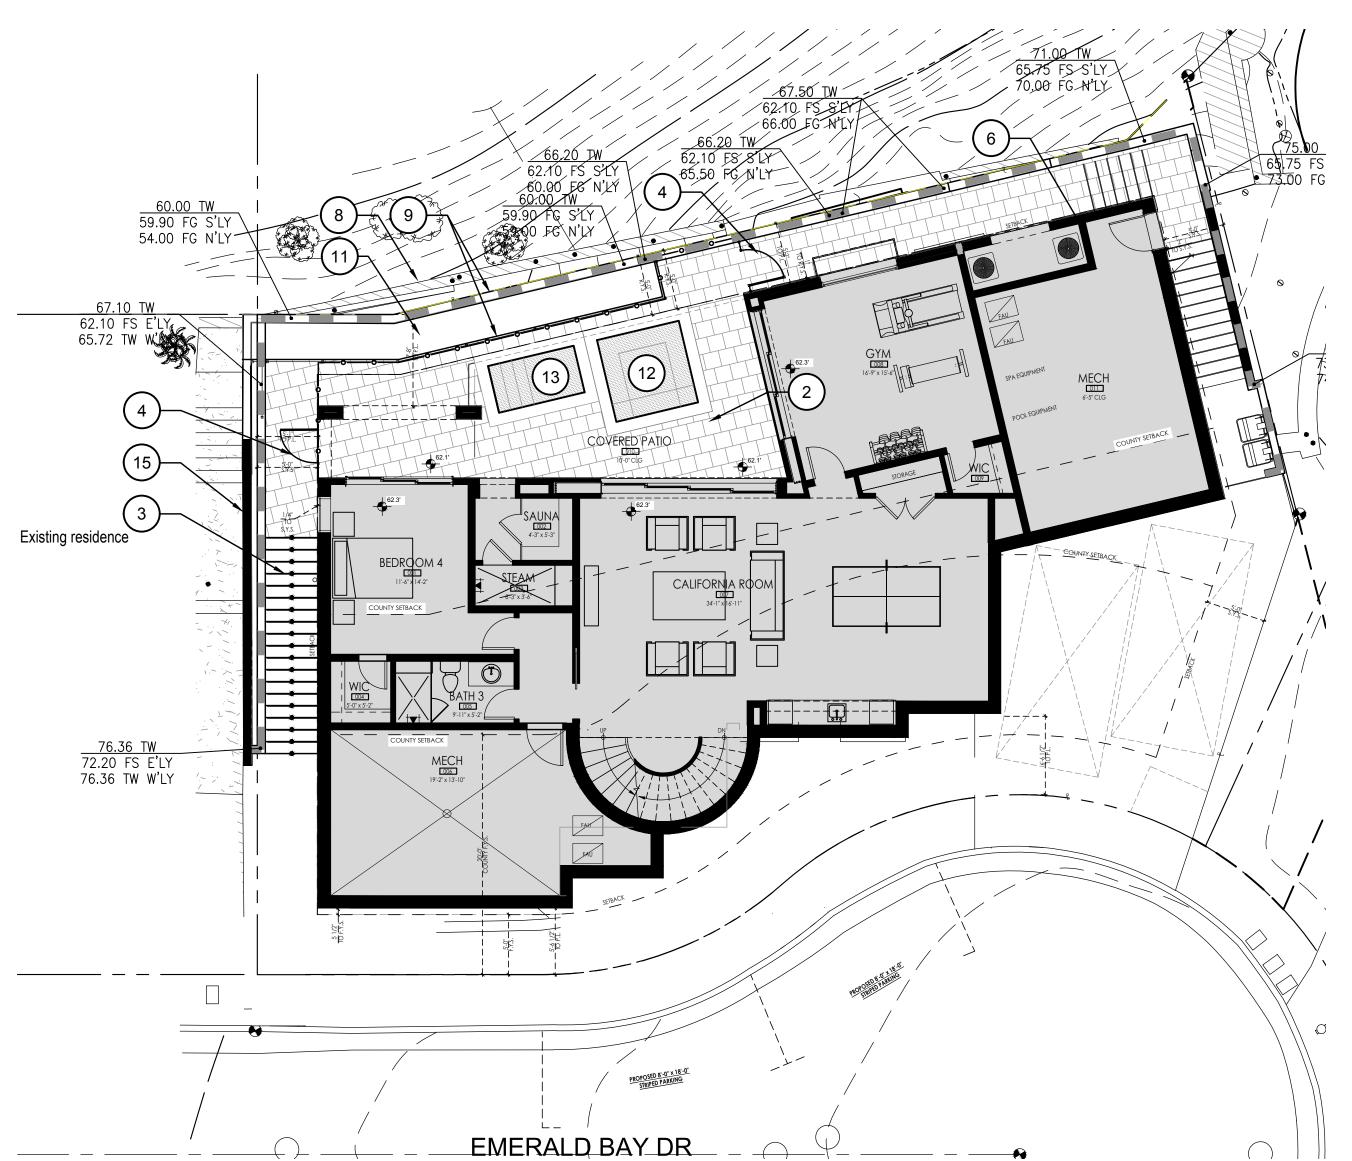


BASEMENT LEVEL - REAR YARD PATIO

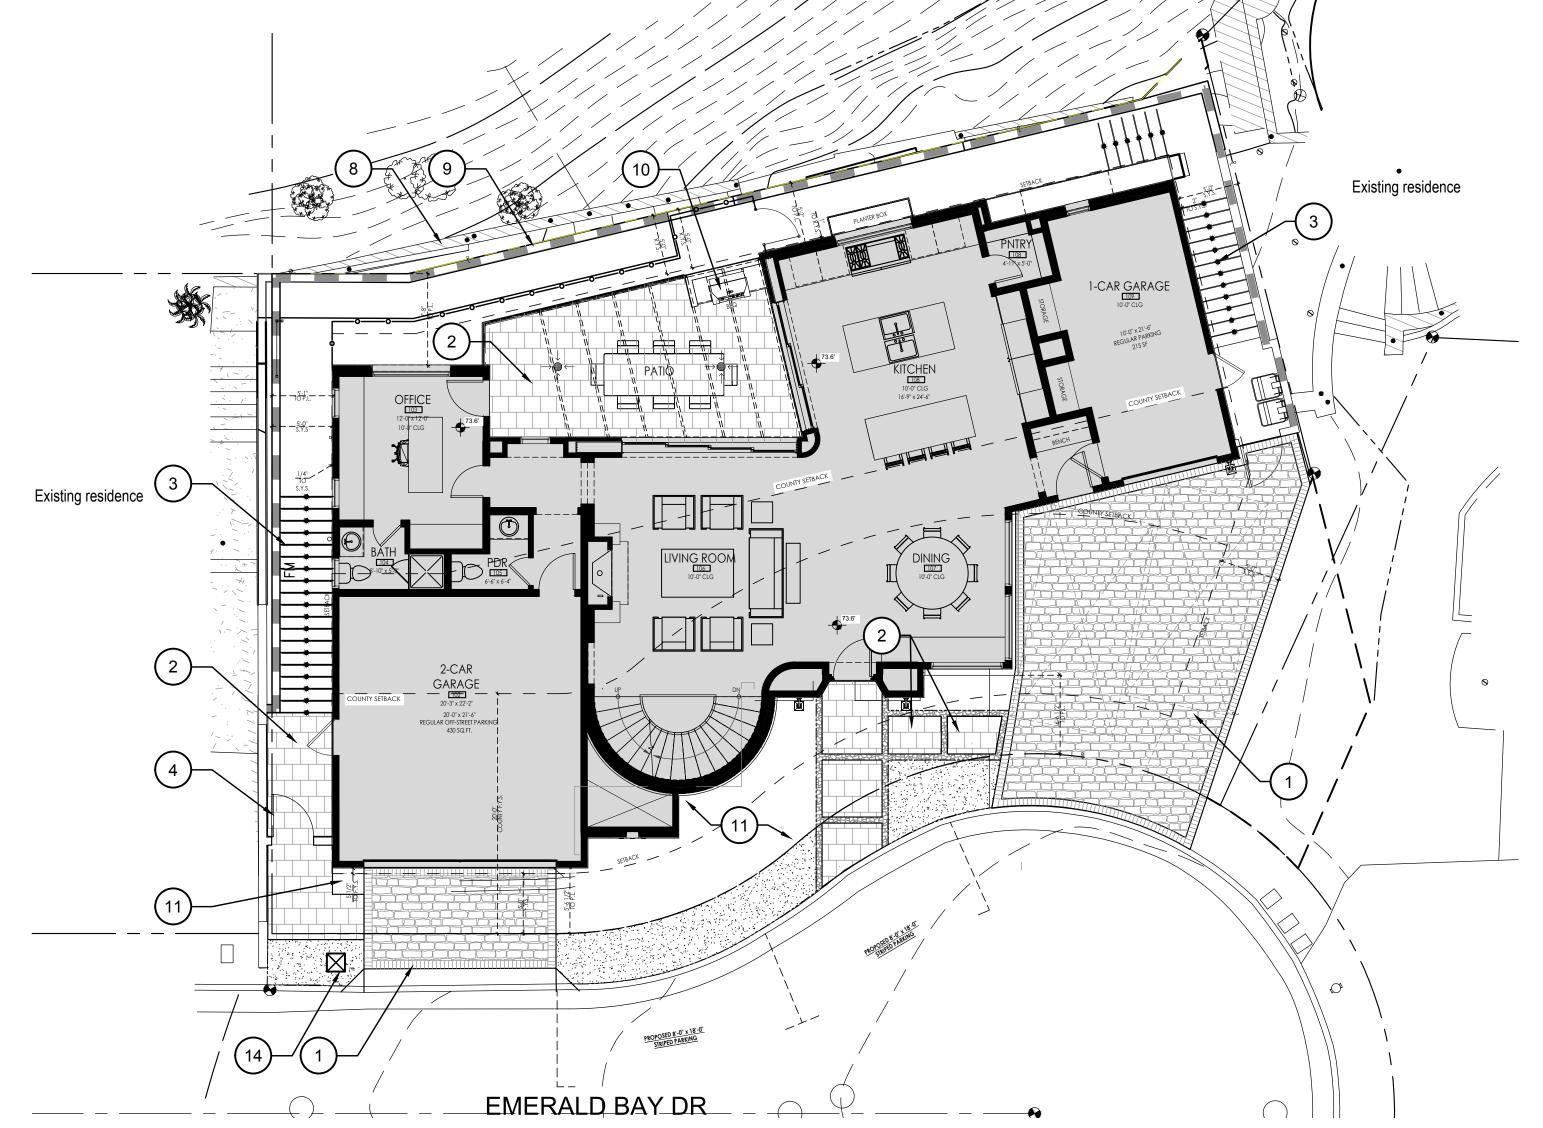


MAIN LEVEL FLOOR PLAN



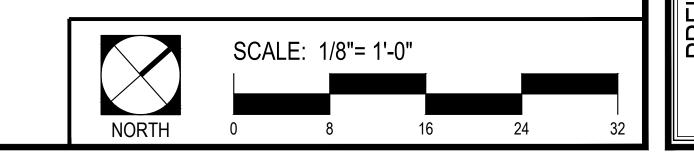




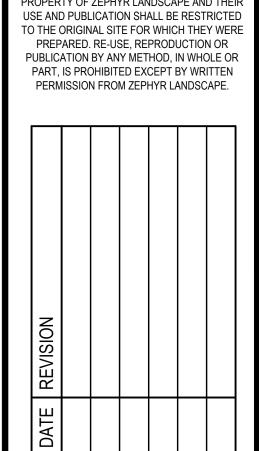

22	SHEET DESCRIPTION
ISSUED: 05/18/202	PRELIMINARY HARDSCAPE PLAN

SHEET NUMBER

1 OF 2 SHEETS

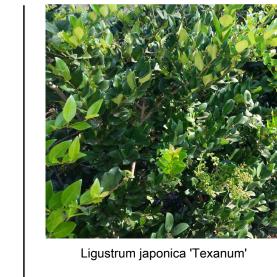

SHRUBS













Agave attenuata

Marina Strawberry Tree 25'W x 40'H

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TO THE ORIGINAL SITE FOR WHICH THEY WERE

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OLSEN RESIDENCE PLANTING LEGEND

ARB MAR Arbutus 'Marina'

Asparagus densiflorus 'Meyeri'

PERENNIALS & GROUNDCOVERS

SHRUBS			
LIG TEX	Ligustrum japonica 'Texanum'	Wax Leaf Privet	4'W x 10'H
OLE EUR	Olea europea 'Montra'	Little Ollie	2'W x 6'H
WES FRU	Westringia fruticosa 'Morning Light'	N.C.N.	4'W x 3'H
SUCCULEN	ITS .		
SUCCULEN AGA ATT	<u>ITS</u> Agave attenuata	Foxtail Agave	4'W x 3'H
AGA ATT		Foxtail Agave	4'W x 3'H
AGA ATT	Agave attenuata S & GROUNDCOVERS	Foxtail Agave Foxtail Fern	4'W x 3'H 2'W x 4'H



SOD LAWN: Marathon II w/ black metal edging

IRF	RIGATION NOTES:
-	ALL LANDSCAPE AREAS TO BE DRIP IRRIGATED WITH A
	AUTOMATIC CONTROLLER INCLUDING A WEATHER
	SENSOR OR SOIL MOISTURE SENSOR & BACKFLOW
	DEVICE PER COUNTY CODES

- IRRIGATION SYSTEM WILL BE DESIGNED IN COMPLIANCE WITH THE COUNTY OF ORANGE WATER EFFICIENT LANDSCAPE ORDINANCE (WELO REQUIRED FOR NEW LANDSCAPE OF 500 SF OR GREATER)
- IRRIGATION PLAN TO BE SUBMITTED TO THE COUNTY OF ORANGE PRIOR TO PULLING PERMIT



La Jolla features a bold, robust frame, strikingly good looks, stellar glarefree performance, and a Copper Louver with precision-machined optics. Use adjacent to paved areas or in planters at the lawns edge, La Jolla: Bold styling, Superior materials, Mechanical innovation, Illuminating performance, Exclusively from Auroralight.

SEE NEXT PAGE FOR ORDERING INFORMATION





CAD FILE SHEET NUMBER

DESIGNED

■ S | DRAWN

DATE

OLSON RESIDEI 52 EMERALD BA LAGUNA BEACH, CA LANDSCAPE IMPROVEME

SHEET DESCRIPTION

PRELIMINARY


PLANTING &

LIGHTING PLAN

05/18/2022

2 OF 2 SHEETS



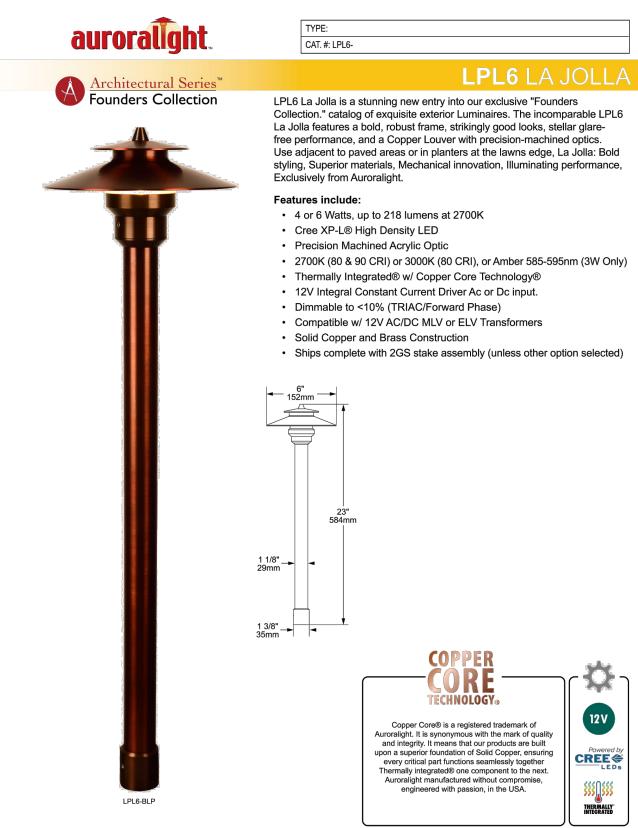



CARLSBAD, CA | PHONE 877 942 1179 | FAX 760 931 2916 | E-MAIL SALES@AURORALIGHT.COM | AURORALIGHT.COM

