CUSTOM RESIDENCE

1016 Emerald Bay Laguna Beach • California • 92651

<u>Abbreviations</u>

	Anchor Bolt	DR	Drawing	MAX	Maximum
	Air Conditioning	D.F.	Drinking Fountain	MET	Metal
OU	Acoustical	EA	Each	MIN	Minimum
	Area Drain	ELEC	Electrical	(N)	New
J	Adjustable	ELEV	Elevation	NIC	Not In Contract
JT	Adjacent	EQUIP	Equipment	N.T.S.	Not To Scale
	Aluminum	EX	Existing	NAT	Natural
-	Alternate	EXP. JT.	Expansion Joint	OC	On Center
PROX	Approximate	EXT	Exterior	OPG	Opening
CH	Architect	EQ	Equal	OD	Outside
3	Asbestos	FOF	Face Of Finish	OH	Dim
)	Asphalt	FOC	Face Of Concrete	PLAS	Overhead
30	As Selected By Owner	FS	Face Of Stud	PL	Plaster
	Board	FIN	Finish	Р	Plate
LD	Building	FP	Fire Proof	PG	Paint Grade
	Block	FS	Finish Surface	PR	Pair
	Blocking	FT	Foot	RAD	Radius
	Beam	FTG	Footing	REQ	Required
Т	Bottom	F.D.	Fire Department	RD	Roof Drain
)	Bedroom	C.	Connection	RM	Room
	Bracket	G	Galvanized	REV	Revised
В	Cabinet	G.I.	Galvanived Iron	RWD	Redwood
	Catch Basin	GA	Gauge	RO	Rough
	Cement	GL	Glass	R.O.	Rough Opening
₹	Ceramic	GYP	Gypsum	REG	Register
	Cast Iron	GC	General Contractor	SCH	Schedule
3	Ceiling	HDWR	Hardware	SECT	Section
	Calking	HWD	Hardwood	SIM	Similar
	Center Line	HT	Height	STD	Standard
OS	Closet	HC	Hollow Core	STL	Steel
2	Clear	НМ	Hollow Metal	STR	Structural
U	Concrete Masonry Unit	HORIZ	Horizontal	SUSP	Suspended
₹	Counter	НВ	Hose Bibb	TEL	Telephone
L	Column	HVAC	Heating Venting AC	TEMP	Temporary
NC	Concrete	IN	Inch	T&G	Tongue & Groove
ND	Condition	ID	Inside Dim.	TC	Top Of Curb/Concrete
NN	Connection	INSUL	Insulation	TS	Top Of Slab
NST	Construction	INT	Interior	TYP	Typical Top Of Wall
NT	Continuous	INV	Invert	TW	Top of Light
NTR	Contractor	JT	Joint	T.LT.WT.	Weight
R	Corridor	KIT	Kitchen	VTR	Vent Thru Roof
	Center	LAV	Lavatory	VERT	Vertical
SK	Countersunk	LIN. FT.	Linear Foot	WC	Water Closet
	Center Line	LINOL	Linoleum	WH	Water Heater
	Ceramic Tile	LG	Long	WT	Weight
2	Clear	LAM	Laminated	WD	Wood
Ī	Detail	LT	Light	WWM	Welded Wire Mesh
	Diameter	MB	Machine Bolt	WI	Wrought Iron
1	Dimension	MECH	Mechanical	WS	Weather Strip
					• 1

<u>Notes</u>

- POOLS, SPAS, WALLS, FENCES, PATIO COVERS AND OTHER FREE-STANDING STRUCTURES REQUIRE SEPARATE REVIEWS AND PERMITS.

- PRIOR TO PERFORMING ANY WORK IN THE CITY RIGHT-OF-WAY AN ENCROACHMENT PERMIT MUST BE OBTAINED FROM THE PUBLIC WORKS DEPARTMENT.

- ISSUANCE OF A BUILDING PERMIT BY THE CITY OF NEWPORT BEACH DOES NOT RELIEVE APPLICANTS OF THE LEGAL REQUIREMENTS TO OBSERVE COVENANTS, CONDITIONS AND RESTRICTIONS WHICH MAY BE RECORDED AGAINST THE PROPERTY OR TO OBTAIN PLANS. YOU SHOULD CONTACT YOUR COMMUNITY ASSOCIATIONS PRIOR TO COMMENCEMENT OF ANY CONSTRUCTION AUTHORIZED BY THE PERMIT.

- A CAL-OSHA PERMIT IS REQUIRED FOR EXCAVATIONS DEEPER THAN 5' AND FOR SHORING AND UNDERPINNING.

- A LICENSED SURVEYOR SHALL COMPLETE FEMA ELEVATION CERTIFICATE AND SUBMIT IT TO THE BUILDING DEPARTMENTINSPECTOR DURING FINAL INSPECTION.

- ALL MECHANICAL AND ELECTRICAL EQUIPMENT, INCLUDING ALL DUCTS TO BE AT OR ABOVE BASE FLOOD ELEVATION OF 9.0 MSL. (NAVD 88)

-PROVIDE SEPARATE WATER SERVICE WITH $\frac{3}{4}$ PLUMBING LINE AND UPGRADE TO 1" PLUMBING LINE IF FIRE SPRINKLERS ARE PROVIDED

Scope of Work

Remodel and addition to existing residence with landscape and hardscape improvements.

Codes

This Project Shall Comply With The Following Codes:

2019 CBC 2019 CPC 2019 Energy 2019 CEC 2019 CRC 2019 CMC 2019 CalGreen 2019 BEES NBMC Chap. 15

<u>Deferred Submittals</u>

Deferred submittals shall be reviewed by the project designer or engineer of record and certified prior to submittal for plan review. Fire Sprinkler Plans

Symbols

evision	^	
ection Line ection Designation	B A6	1
neet Number		
etail Key		,
etail Designation neet Number		(

Approximate Site Area:

Max. Allowable Coverage: 40.0%

Project Data

Lot:	
Tract:	
APN:	053-
Occupancy Group :	
Number of Stories :	
Type of Construction :	
Sprinklered:	

Proposed Coverage : 39.4%			
Proposed Entry Level	EXISTING 2,361.1 sf	PROPOSED 2,568.6 sf	SQ FT ADJUSTMENT +207.5 sf
Lower Level	1,261.8 sf	1,929.4 sf	+667.6 sf
Total Habitable Area	3,622.9 sf	4,498 sf	+875.1 sf
2 Car Garago	100 2 of	5210 of	130 6 of

Total Project 4,122.1 sf 5,029.8 sf 2- Car Garage Parking Calculation 4,599.8 sf

Proposed Deck 745.66 sf 543.8 sf -201.86 sf

Total Deck Area 543.8 sf

Consultants

ARCHITECT: C.J. Light Associates 1401 Quail Street, Suite 120 Newport Beach, CA 92660 (949) 851-8345 Architect: Christian R. Light

Contact: Vanessa Espino

Daniel Stewart & Assoc. Landscape Architects

2753 Camino Capistrano B-2 San Clemente, CA 92672 (949) 361-9388 Contact: Daniel Stewart

CIVIL ENGINEER: CivilScapes Engineering, Inc 28052 Camino Capistrano, Suite 213 Laguna Niguel, CA 92677 (949) 464-8115

8,365 sq ft 3,346 sq ft

STRUCTURAL ENGINEER: ESI/FME, Inc. 1800 E. 16Th ST. STE. B Santa Ana, CA 92701 (714) 835-2800 Contact: William Rolph Contact: Farhad Manshad

<u>Sheet Index</u>

Architectural	
	Cover Sheet
1	Site Plan
.0	Slab Interface Plan
.0	Lower Level Existing Floor / Demolition Plan
.1	Entry Level Existing Floor / Demolition Plan
2	Proposed Lower Level Floor Plan
3	Proposed Entry Level Floor Plan
.4	Schedules
.0	Roof Plan
.0	Sections A & B
.1	Sections C & D
1.0	Elevations
5.1	Elevations
0.0	Lower Level Utility Plan
.1	Entry Level Utility Plan
7.0	Lower Level Reflected Ceiling Plan

Entry Level Reflected Ceiling Plan

Landscape

Construction
Planting
Details
Details
Lighting
Lighting Cut Sheet
Irrigation
Irrigation Details
Planting Details
Irrigation Spec

Civil

1	Topographic St	urve
	1960's ⁻	
	Title S	Shee
	Grading	Pla
	Storm Drainage	Plo
	Erosion Control	Pla

Owner / Client

Doug & Joan Hansen 1016 Emerald Bay Laguna Beach, CA 92651

Vicinity Map




Laguna Beach, CA 92651




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COVER SHEET

CJLA No. 2120 Scale: 7-26-22 Date:



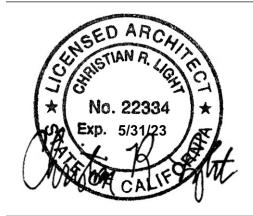

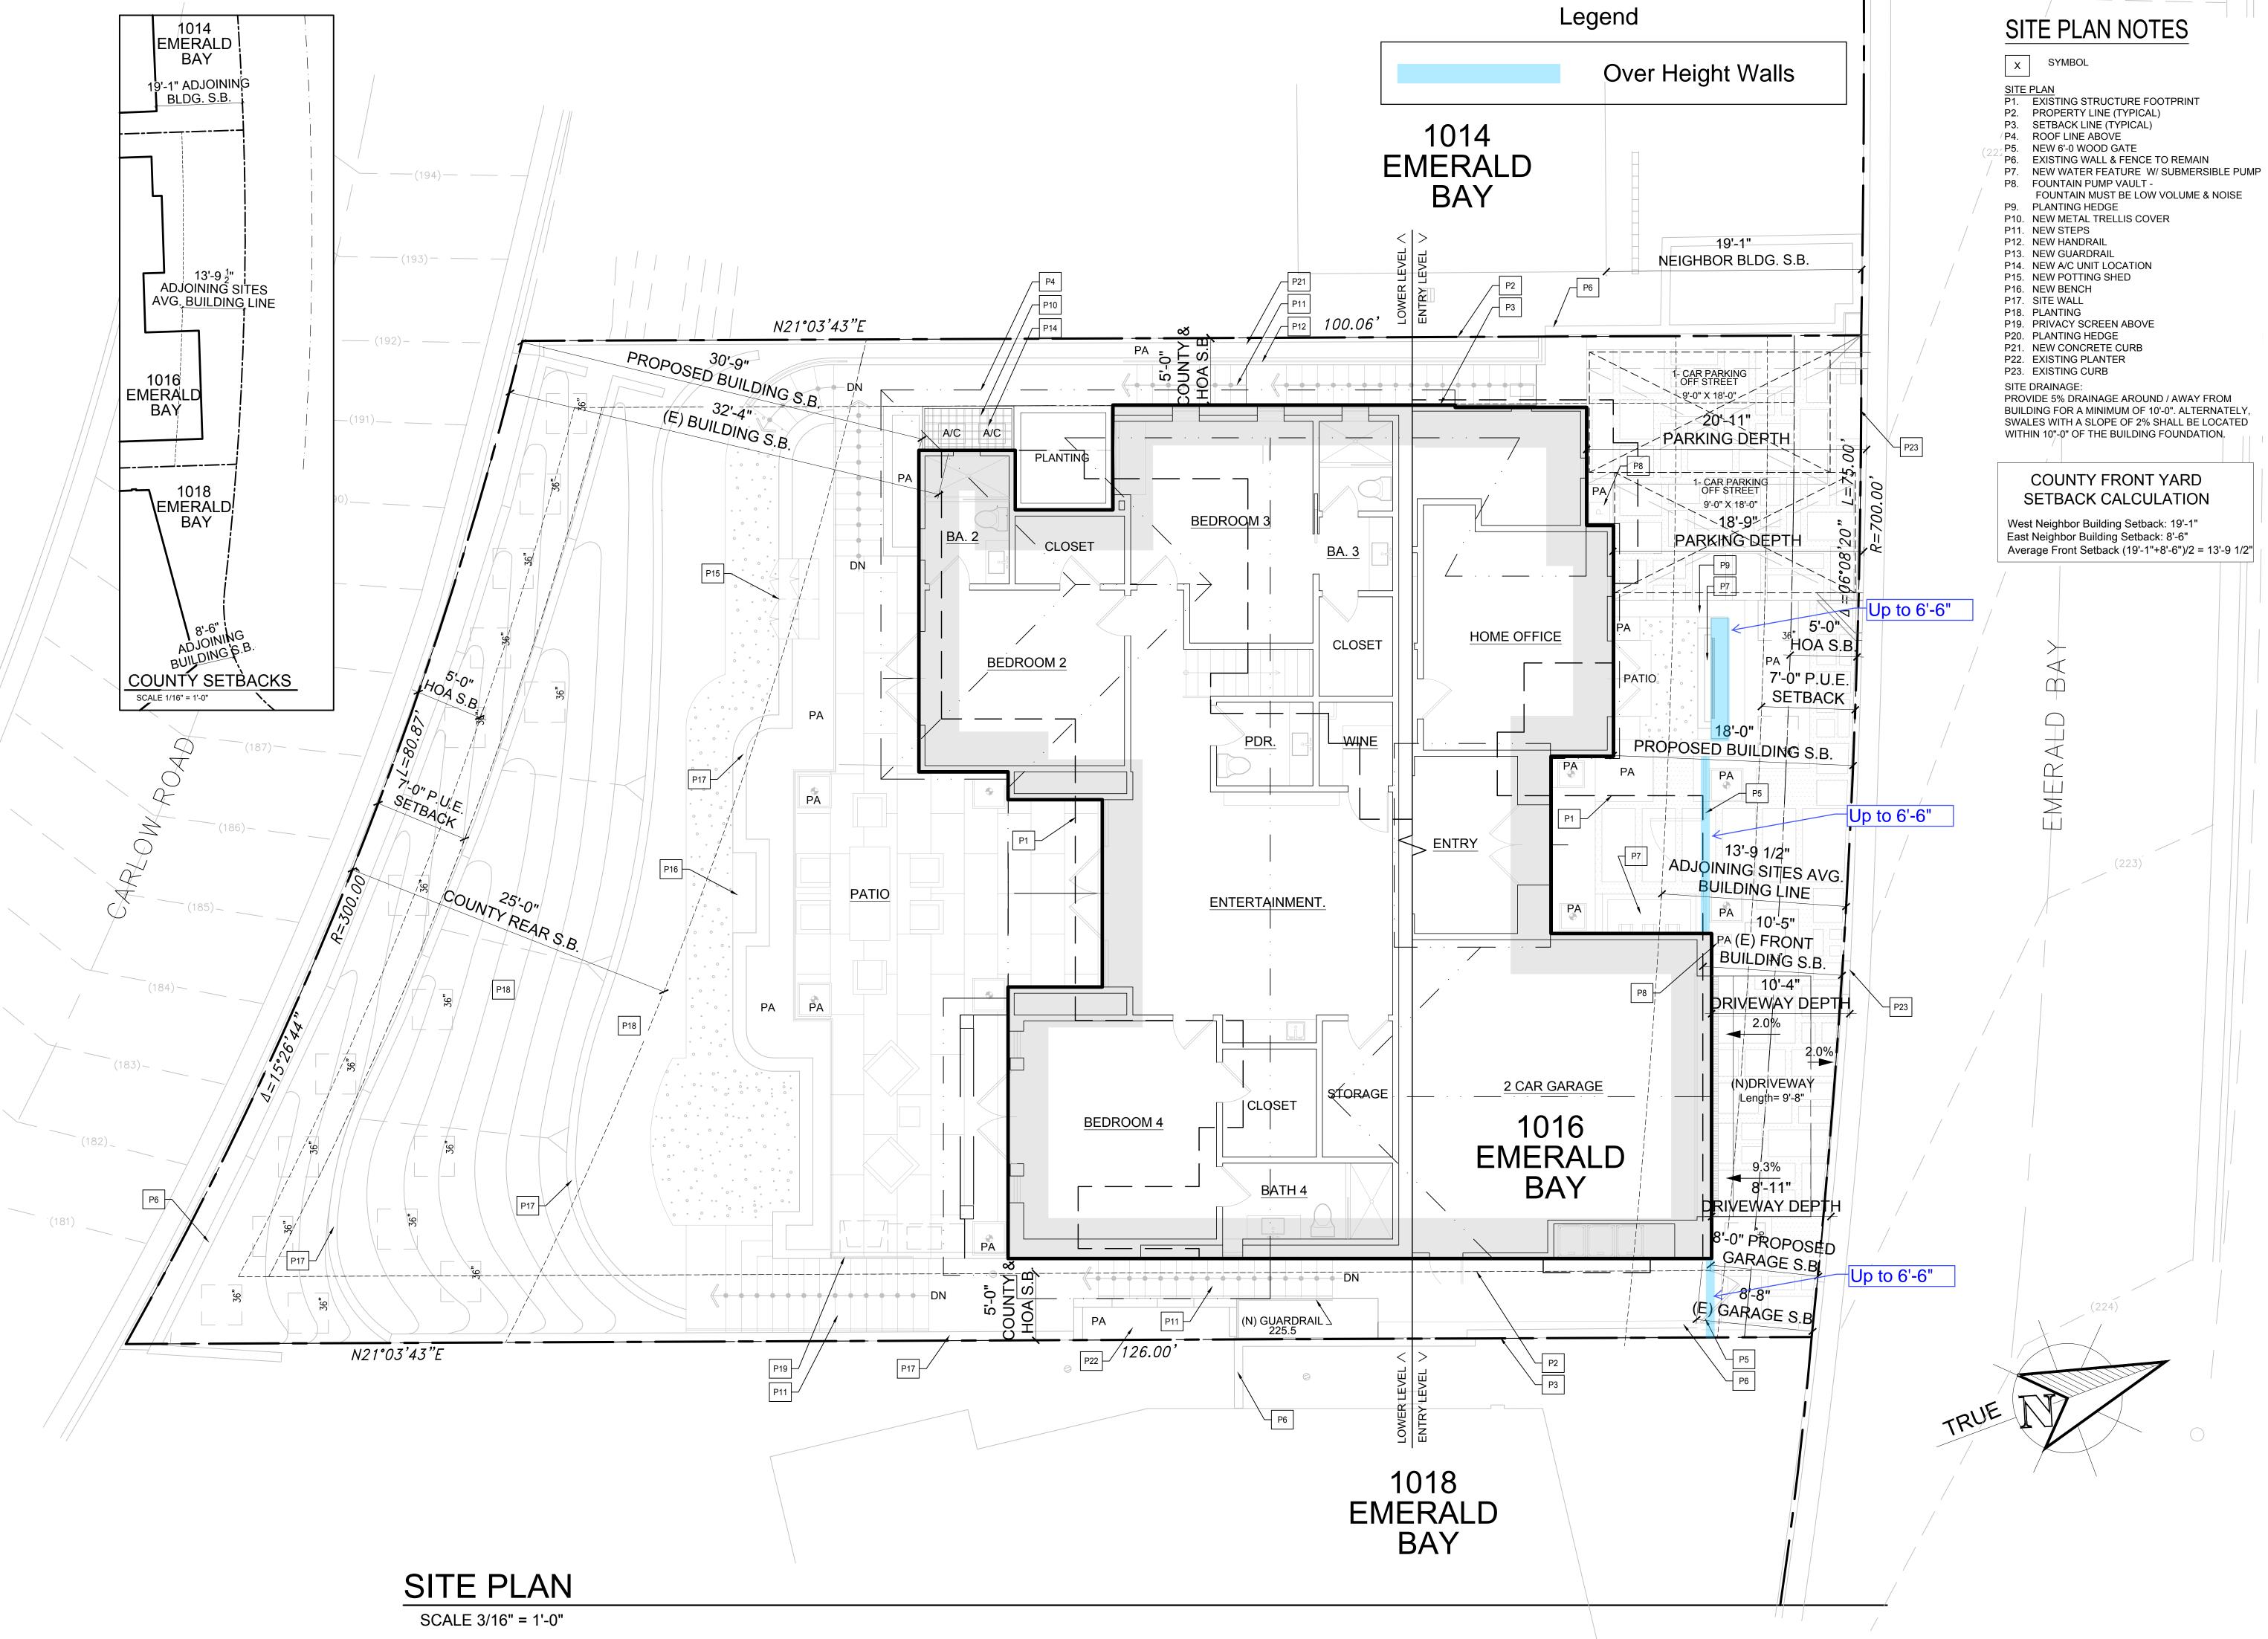Hansen Residence
1016 Emerald Bay

C.J. LIGHT

ASSOCIATES

CHRISTIAN R. LIGHT, ARCHITECT

1401 Quail Street, Suite 120

Newport Beach, CA 92660

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Fax (949) 851-1116

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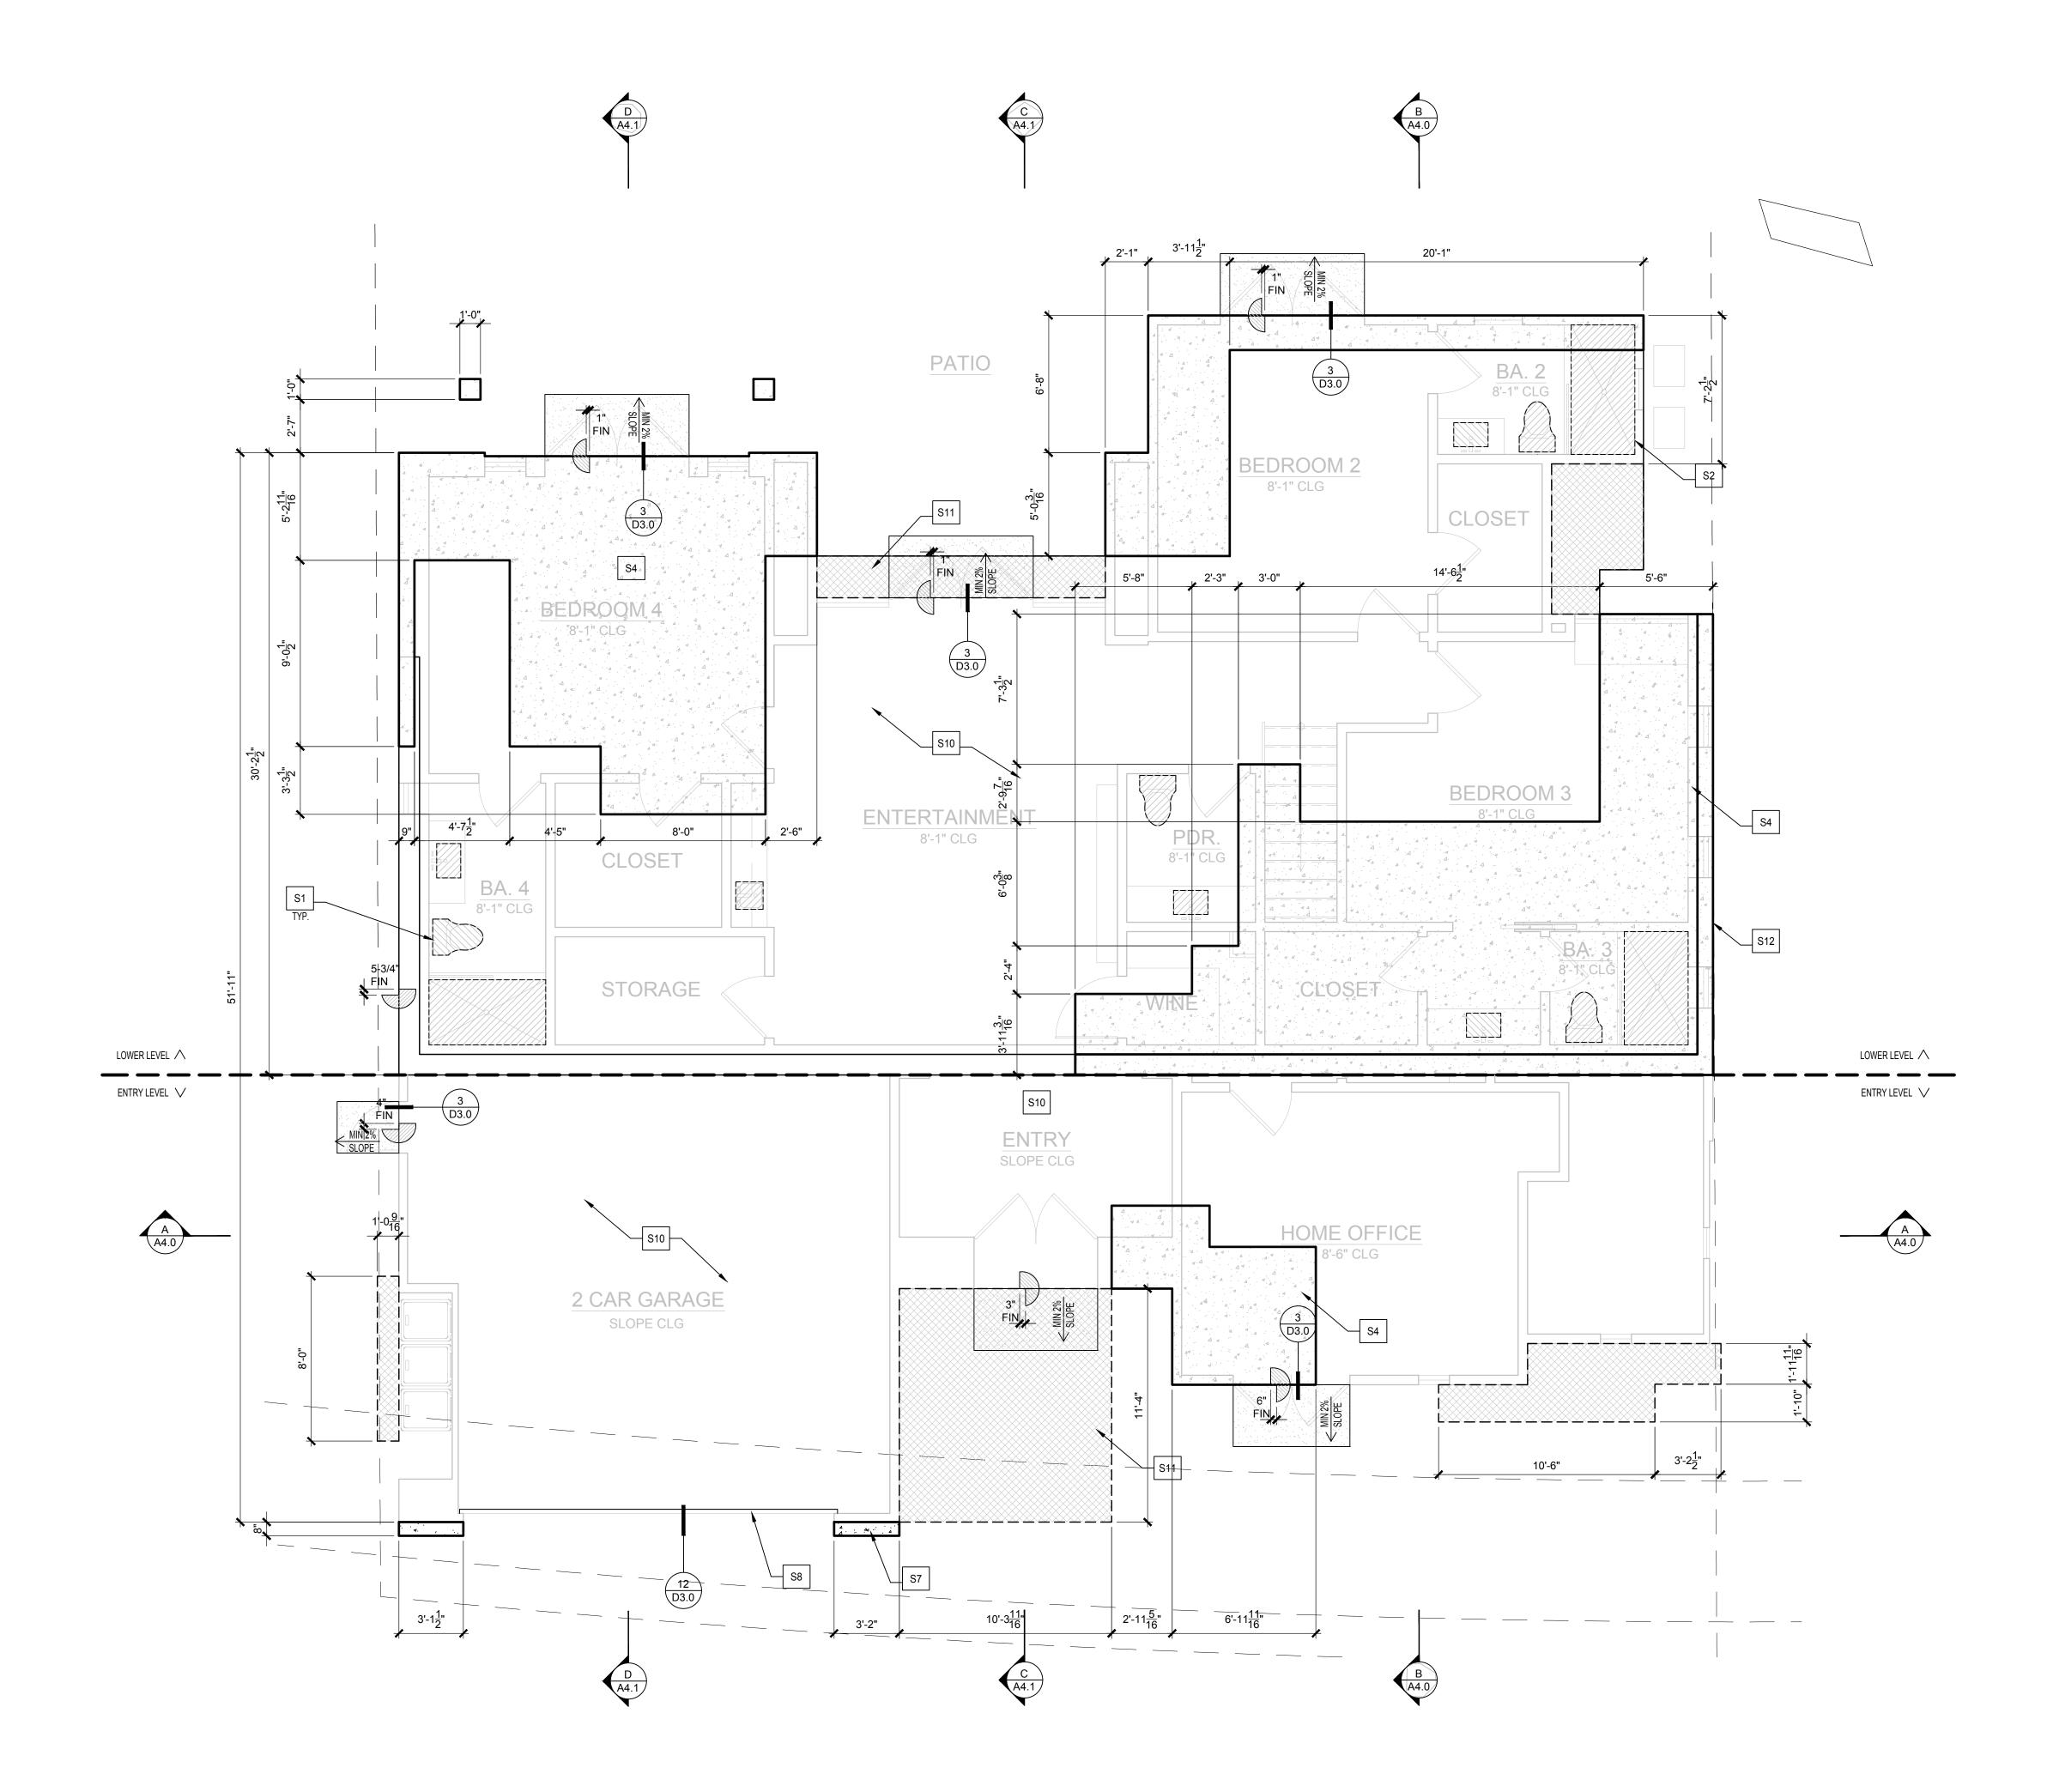
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SITE PLAN

CJLA No. 2120 Scale: 3/16"=1'-0" Date: 7-26-22



SP1



SLAB INTERFACE PLAN

GENERAL NOTES

THIS ARCHITECTURAL FOUNDATION PLAN IS FOR DIMENSIONAL INFORMATION ONLY. THE CONTRACTOR SHALL REFER TO THE STRUCTURAL FOUNDATION PLAN FOR ALL STRUCTURAL REQUIREMENTS. THE CONTRACTOR SHALL NOTIFY THE ARCHITECT IF THERE IS ANY DISCREPANCY BETWEEN THE ARCHITECTURAL FOUNDATION PLAN AND THE STRUCTURAL FOUNDATION PLAN.

A VAPOR RETARDER AND CAPILARY BREAK ARE REQUIRED TO BE INSTALLED AT THE SLAB ON GRADE FOUNDATIONS. REFER TO GEOTECHNICAL RECOMMENDATIONS FOR ADDITIONAL REQUIREMENTS.

SLAB EDGE NOTES

XX SYMBOL

0 SLABED

S1. HATCHING INDICATES PLUMBING FIXTURES PROVIDE GAS, PLUMBING, OR
ELECTRICAL AS REQUIRED.

S2. DEPRESSED SLAB @ SHOWER

- S3. CONCRETE ENCASED GROUNDING ELECTRODE: PROVIDE (1) 20 FOOT LONG #4 BAR IN FOOTING AND EXTEND OUT OF CURB 12 INCHES FOR GROUNDING OF ELECTRICAL SYSTEM (VERIFY EXACT LOCATION).
- S4. TYPICAL SLAB ON GRADE REFER TO STRUCTURAL DRAWINGS.
- S5. NOT USED
- S6. CONCRETE STEPS MAXIMUM RISE 7 1/2", MIN. RUN 10". FINISH TO BE VERIFIED BY CONTRACTOR.
- S7. CONCRETE CURB, STEM WALL REFER TO STRUCTURAL PLANS
- S8. GARAGE DOOR DEPRESSION REFER TO DETAIL
 S9. CONCRETE STOOP, MINIMUM 36 INCH DEEP AND
 WIDTH OF DOOR. SLOPE 1/4 INCH PER FOOTAWAY
 FROM BUILDING. COORDINATE W/ LANDSCAPE
 DESIGN AND FINISH
- S10. EXISTING CONCRETE SLAB / FOUNDATION TO
- S11. EXISTING CONCRETE SLAB / FOUNDATION TO BE REMOVED AS NECESSARY
- S12. 12" CONCRETE RETAINING WALL

C.J. LIGHT ASSOCIATES

CHRISTIAN R. LIGHT, ARCHITECT

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C.J. Light Associates

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SLAB INTERFACE PLAN

CJLA No. 2120
Scale: 1/4"=1'-0"
Date: 7-26-22


FOUNDATION LEGEND

EXISTING SLAB / CONCRETE TO REMAIN


EXISTING SLAB / CONCRETE TO BE REMOVED

NEW SLAB (PER STRUCTURAL)

NEW CONCRETE WALLS (PER STRUCTURAL)

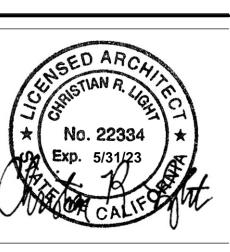

A1.0

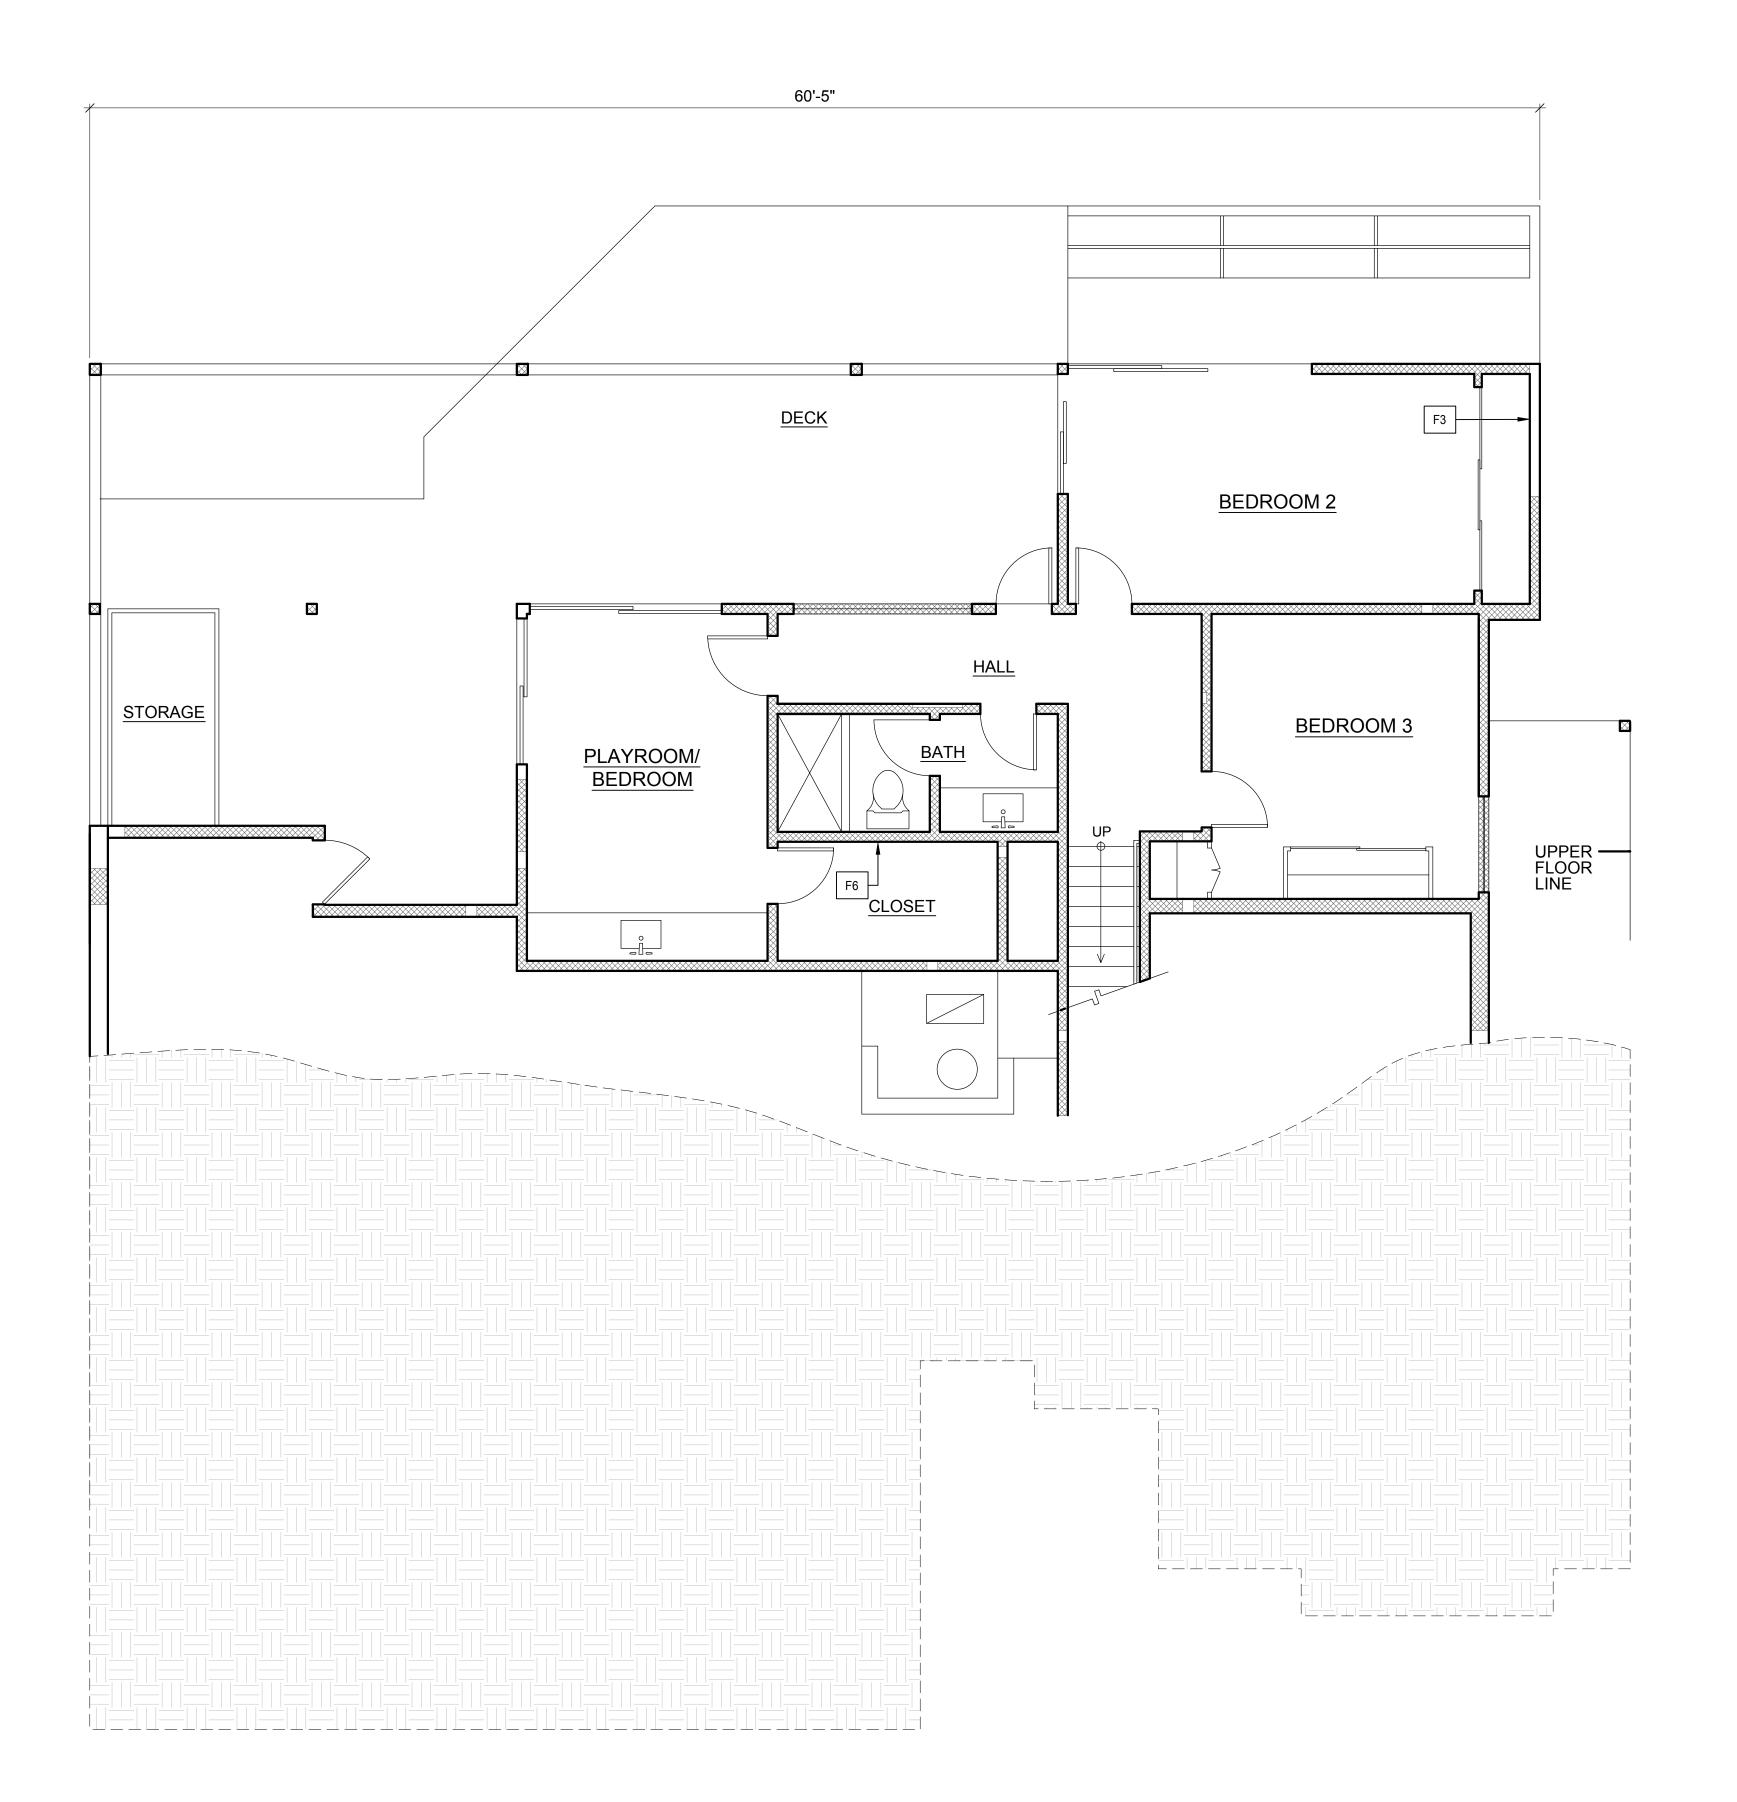

LOWER LEVEL EXISTING FLOOR / DEMOLITION PLAN

GENERAL NOTES

▲ = TEMPERED GLASS (TYP)

= EMERGENCY EGRESS WINDOW (TYP)

PROVIDE THE FOLLOWING FOR EGRESS

WINDOWS:

1. 5.7 SQ. FT. OF CLEAR OPERABLE AREA

2. NET CLEAR OPENING HEIGHT SHALL BE 24" MIN.

3. NET CLEAR OPENING WIDTH SHALL BE 20" MIN.

4. BOTTOM OF WINDOW OPENING SHALL NOT BE

MORE THAN 44" ABOVE FINISHED FLOOR.

FLOOR PLAN NOTES

XX SYMBOL

FLOOR PLAN

F1. NEW 2 x 6 STUD WALLS (SHADED) REFER
TO STRUCTURAL PLANS

F2. NEW 2 x 4 STUD WALLS (SHADED/HATCHED)

REFER TO STRUCTURAL PLANS

REFER TO STRUCTURAL PLANS
F3. EXISTING WALLS TO REMAIN (CLEAR)

F4. 30" x 30" MINIMUM ATTIC ACCESS PANEL
F5. ATTIC FAU - PROVIDE 30" WIDE CATWALK FROM
ACCESS TO UNIT - REFER TO SHEET A5.0? FOR
LOCATION.

F6. EXISTING WALLS TO BE REMOVED
F7. BASE CABINET - REFER TO INTERIOR

DRAWINGS F8. UPPER CABINET - REFER TO INTERIOR

DRAWINGS

DRAWINGS F10. CABINETRY - REFER TO INTERIOR DRAWINGS

F11. HANDRAIL - REFER TO DETAIL TBD.

F9. ISLAND CABINET - REFER TO INTERIOR

F12. 42" GUARDRAIL - REFER TO APPLICABLE DETAILS

F13. COMPACT RANGE / OVEN COMBO F14. FIREPLACE BY TBD

F15. DISHWASHER SPACE

F16. GAS RANGE W/ EXHAUST HOOD VENTED DIRECTLY TO OUTSIDE AIR.

F17. OVEN INSTALLED IN ACCORDANCE W/ MANUF SPECIFICATIONS

F18. REFRIGERATOR SPACE

F19. TANKLESS WATER HEATER LOCATION

F20. KITCHEN SINK W/ GARBAGE DISPOSAL F21. BASE CABINET W/ LAV SINK - REFER TO

CABINET DRAWINGS BY OTHERS
F22. WATER CLOSET - PROVIDE 30" MIN WIDTH, 24" MIN

CLEARANCE IN FRONT F23. CORROSIVE RESISTANT DECK DRAIN W/

OVERFLOW PIPED SEPARATELY F24. MUDSET TILE SHOWER TO MIN 84" A.F.F.

PROVIDE TEMPERED / SHATTER RESISTANT ENCLOSURE

F25. 15" WIDE BENCH SLOPED TO DRAIN. VERIFY HEIGHT W/ OWNER

F26. PROPERTY LINE FOR REFERENCE

F27. SETBACK LINE FOR REFERENCE F28. SOFFIT - SEE INTERIOR DWG'S

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F30. PROVIDE WATER SUPPLY AND DRAIN FOR PLANTING POT

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F32. LAUNDRY SINK F33. SKYLIGHT - REFER TO WINDOW SCHEDULE

F34. WASHER SPACE - PROVIDE HOT / COLD WATER AND DRAIN

F35. DRYER SPACE. PROVIDE DRYER VENT TO OUTSIDE AIR W/ BACK DRAFT DAMPER. VENT SHALL BE SMOOTH WALL METAL W/O SCREW

CONNECTIONS F36. SHOWER

F37. CLOSET POLE/SHELF - SEE INTERIOR DWG'S

F38. BUILT UP FLAT ROOF - REFER TO ROOF PLAN

F39. 5/8" TYPE 'X' GYPSUM BOARD ON WALLS SEPARATING HOUSE FROM GARAGE

F40. 5/8" TYPE 'X' GYPSUM BOARD ON CEILING

SEPARATING HOUSE FROM GARAGE

F41. WATER FEATURE F42. FOUNTAIN PUMP VAULT - FOUNTAIN MUST BE LOW

VOLUME AND NOISE F43. WATERPROOF DECK COVERING BY DEX-O-TEX ICC

ESR 1757

F44. PRIVACY WALL

F45. FLOOR AREA REMOVED F46. FLOOR AREA ADDED

F47. EXISTING HOUSE PERIMETER

ALL APPLIANCE, FIXTURE AND OTHER EQUIPMENT INSTALLATION REQUIREMENTS SHALL BE VERIFIED AND ACCORDINGLY PROVIDED BY EACH TRADE AS PART OF THEIR BASIC SCOPE OF WORK. THIS SHALL INCLUDE SPACE, UTILITIES, ETC.

FIREPLACE SYSTEMS USED IN SEISMIC DESIGN CATEGORY D & E ARE LIMITED TO THOSE INCORPORATING LISTED AND LABELED FACTORY BUILT CHIMNEYS.

ALL PLUMBING FIXTURES SHALL COMPLY WITH THE MAXIMUM FLOW RATES AS NOTED IN THE RESIDENTIAL CONSTRUCTION MINIMUM STANDARDS

ALL EXTERIOR WALLS SHALL BE 2 X 6 STUDS W/ R-19 INSULATION

PROVIDE R-30 INSULATION THROUGHOUT ATTIC AND INDIVIDUAL RAFTER BAYS AT SLOPED CEILINGS.

REFER TO INTERIOR DRAWINGS PREPARED BY OTHERS FOR ALL INTERIOR FINISHES AND CEILING TREATMENTS



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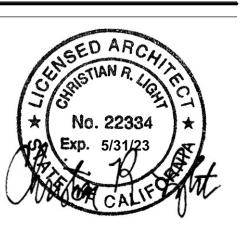
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LOWER LEVEL EXISTING FLOOR / DEMOLITION PLAN

CJLA No.	2120
Scale:	1/4"=1'-0"
Date:	7-26-22



A2 0



ENTRY LEVEL EXISTING FLOOR / DEMOLITION PLAN

GENERAL NOTES

▲ = TEMPERED GLASS (TYP)

= EMERGENCY EGRESS WINDOW (TYP)

PROVIDE THE FOLLOWING FOR EGRESS

1. 5.7 SQ. FT. OF CLEAR OPERABLE AREA 2. NET CLEAR OPENING HEIGHT SHALL BE 24" MIN. 3. NET CLEAR OPENING WIDTH SHALL BE 20" MIN.

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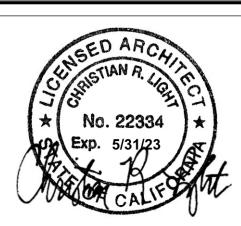
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C.J. Light Associates

SO

ENTRY LEVEL EXISTING FLOOR / DEMOLITION PLAN

2120 CJLA No. 1/4"=1'-0" Scale: 7-26-22



LOWER LEVEL FLOOR PLAN

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CLEARANCE IN FRONT

F23. CORROSIVE RESISTANT DECK DRAIN W/ OVERFLOW PIPED SEPARATELY

F24. MUDSET TILE SHOWER TO MIN 84" A.F.F. PROVIDE TEMPERED / SHATTER RESISTANT ENCLOSURE

F25. 15" WIDE BENCH SLOPED TO DRAIN. VERIFY HEIGHT W/ OWNER

F26. PROPERTY LINE FOR REFERENCE

F27. SETBACK LINE FOR REFERENCE F28. SOFFIT - SEE INTERIOR DWG'S

F29. A/C CONDENSER

F30. ELECTRICAL PANEL F31. JETTED BATHTUB

F31. JETTED BATHTUB F32. LAUNDRY SINK

F33. SKYLIGHT - REFER TO WINDOW SCHEDULE F34. WASHER SPACE - PROVIDE HOT / COLD WATER

AND DRAIN

F35. DRYER SPACE. PROVIDE DRYER VENT TO OUTSIDE AIR W/ BACK DRAFT DAMPER. VENT SHALL BE SMOOTH WALL METAL W/O SCREW CONNECTIONS

F36. SHOWER

F37. CLOSET POLE/SHELF - SEE INTERIOR DWG'S F38. BUILT UP FLAT ROOF - REFER TO ROOF PLAN

F39. 5/8" TYPE 'X' GYPSUM BOARD ON WALLS

SEPARATING HOUSE FROM GARAGE

F40. 5/8" TYPE 'X' GYPSUM BOARD ON CEILING

SEPARATING HOUSE FROM GARAGE

F41. WATER FEATURE

F42. FOUNTAIN PUMP VAULT - FOUNTAIN MUST BE LOW VOLUME AND NOISE

F43. WATERPROOF DECK COVERING BY DEX-O-TEX ICC

ESR 1757

F44. PRIVACY WALL F45. FLOOR AREA REMOVED

F46. FLOOR AREA ADDED F47. EXISTING HOUSE PERIMETER

F48. WINE FRIDGE

F49. ICE MAKER F50. BAR SINK

ALL APPLIANCE, FIXTURE AND OTHER EQUIPMENT INSTALLATION REQUIREMENTS SHALL BE VERIFIED AND ACCORDINGLY PROVIDED BY EACH TRADE AS PART OF THEIR BASIC SCOPE OF WORK. THIS SHALL INCLUDE SPACE, UTILITIES, ETC.

FIREPLACE SYSTEMS USED IN SEISMIC DESIGN CATEGORY D & E ARE LIMITED TO THOSE INCORPORATING LISTED AND LABELED FACTORY BUILT CHIMNEYS.

ALL PLUMBING FIXTURES SHALL COMPLY WITH THE MAXIMUM FLOW RATES AS NOTED IN THE RESIDENTIAL CONSTRUCTION MINIMUM STANDARDS

ALL EXTERIOR WALLS SHALL BE 2 X 6 STUDS W/ R-19 INSULATION

PROVIDE R-30 INSULATION THROUGHOUT ATTIC AND INDIVIDUAL RAFTER BAYS AT SLOPED CEILINGS.

REFER TO INTERIOR DRAWINGS PREPARED BY OTHERS FOR ALL INTERIOR FINISHES AND CEILING TREATMENTS



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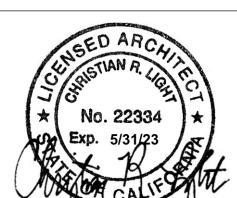
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Hansen Residence 1016 Emerald Bay Laguna Beach • CA • 92651

LOWER LEVEL FLOOR PLAN

CJLA No. 2120 Scale: 1/4"=1'-0" Date: 7-26-22



ENTRY LEVEL FLOOR PLAN

GENERAL NOTES

- ▲ = TEMPERED GLASS (TYP)
- = EMERGENCY EGRESS WINDOW (TYP)

PROVIDE THE FOLLOWING FOR EGRESS

- 1. 5.7 SQ. FT. OF CLEAR OPERABLE AREA 2. NET CLEAR OPENING HEIGHT SHALL BE 24" MIN. 3. NET CLEAR OPENING WIDTH SHALL BE 20" MIN.
- 4. BOTTOM OF WINDOW OPENING SHALL NOT BE MORE THAN 44" ABOVE FINISHED FLOOR.

FLOOR PLAN NOTES

XX SYMBOL

FLOOR PLAN

F1. NEW 2 x 6 STUD WALLS (SHADED) REFER TO STRUCTURAL PLANS

F2. NEW 2 x 4 STUD WALLS (SHADED/HATCHED)

REFER TO STRUCTURAL PLANS F3. EXISTING WALLS TO REMAIN (CLEAR)

F4. 30" x 30" MINIMUM ATTIC ACCESS PANEL F5. ATTIC FAU - PROVIDE 30" WIDE CATWALK FROM ACCESS TO UNIT - REFER TO SHEET A6.1 FOR

F6. EXISTING WALLS TO BE REMOVED F7. BASE CABINET - REFER TO INTERIOR

DRAWINGS F8. UPPER CABINET - REFER TO INTERIOR

DRAWINGS F9. ISLAND CABINET - REFER TO INTERIOR

F10. CABINETRY - REFER TO INTERIOR DRAWINGS

F11. HANDRAIL - REFER TO DETAIL TBD. F12. 42" GUARDRAIL - REFER TO APPLICABLE

DETAILS F13. COMPACT RANGE / OVEN COMBO

F14. FIREPLACE BY?

F15. DISHWASHER SPACE

F16. GAS RANGE W/ EXHAUST HOOD VENTED DIRECTLY TO OUTSIDE AIR.

F17. OVEN INSTALLED IN ACCORDANCE W/ MANUF

SPECIFICATIONS F18. REFRIGERATOR SPACE

F19. TANKLESS WATER HEATER LOCATION

F20. KITCHEN SINK W/ GARBAGE DISPOSAL

F21. BASE CABINET W/ LAV SINK - REFER TO CABINET DRAWINGS BY OTHERS

F22. WATER CLOSET - PROVIDE 30" MIN WIDTH, 24" MIN CLEARANCE IN FRONT

F23. CORROSIVE RESISTANT DECK DRAIN W/ OVERFLOW PIPED SEPARATELY

F24. MUDSET TILE SHOWER TO MIN 84" A.F.F. PROVIDE TEMPERED / SHATTER RESISTANT **ENCLOSURE**

F25. 15" WIDE BENCH SLOPED TO DRAIN. VERIFY HEIGHT W/ OWNER

F26. PROPERTY LINE FOR REFERENCE

F27. SETBACK LINE FOR REFERENCE

F28. SOFFIT - SEE INTERIOR DWG'S

F29. A/C CONDENSER F30. ELECTRICAL PANEL

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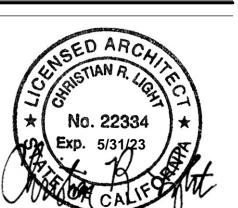
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ENTRY LEVEL FLOOR PLAN

2120 CJLA No. 1/4"=1'-0" Scale: 7-26-22



ROOF PLAN

ROOF PLAN NOTES

XX SYMBOL

PROVIDE ATTIC VENTILATION PER CRC 806

- 0. ROOFR1. TYPICAL SLOPED ROOF ASSEMBLY:A. ROOFING MATERIAL
- **CLAY TILE** MINIMUM CLASS 'A' RATING.
- B. UNDERLAYMENT PER

PITCH SEE ROOF PLAN

- MANUFACTURER.
- C. ROOF SHEATHING PER STRUCTURAL
- DRAWINGS. D. ROOF FRAMING PER STRUCTURAL DRAWINGS.
- R2. FLAT ROOF / DECK ELASTATEX 500 UREHTENE MEMBRANE, MINIMUM CLASS 'A' RATING (OR EQUAL). ICC ES REPORT ESR-1757. SLOPE 1/4" PER FOOT MIN. TO DRAINS
- R3. FLASHING @ BUILT UP ROOF
- R4. COPPER GUTTER SYSTEM
- R5. BALCONY BELOW
- R6. NEW LOW-SLOPE BUILT-UP ROOF AREA LIQUID COATS B/W ROOF SHEETS O/ PLYWOOD DECK 1/2-12" MIN
- R7. INTERNAL ROOF DRAIN -6" CAST IRON DRAIN W/ 3" PIPE
- R8. BUILT UP CRICKET
- R9. LINE OF STRUCTURE BELOW
- R10. SLOPED METAL ROOF
- R11. NON-REFLECTIVE GLAZING WITHOUT **UP-LIGHTING**
- R.12 CHIMNEY W/ METAL CAP
- R.13 STANDING SEAM ZINC ROOF



CHRISTIAN R. LIGHT, ARCHITECT


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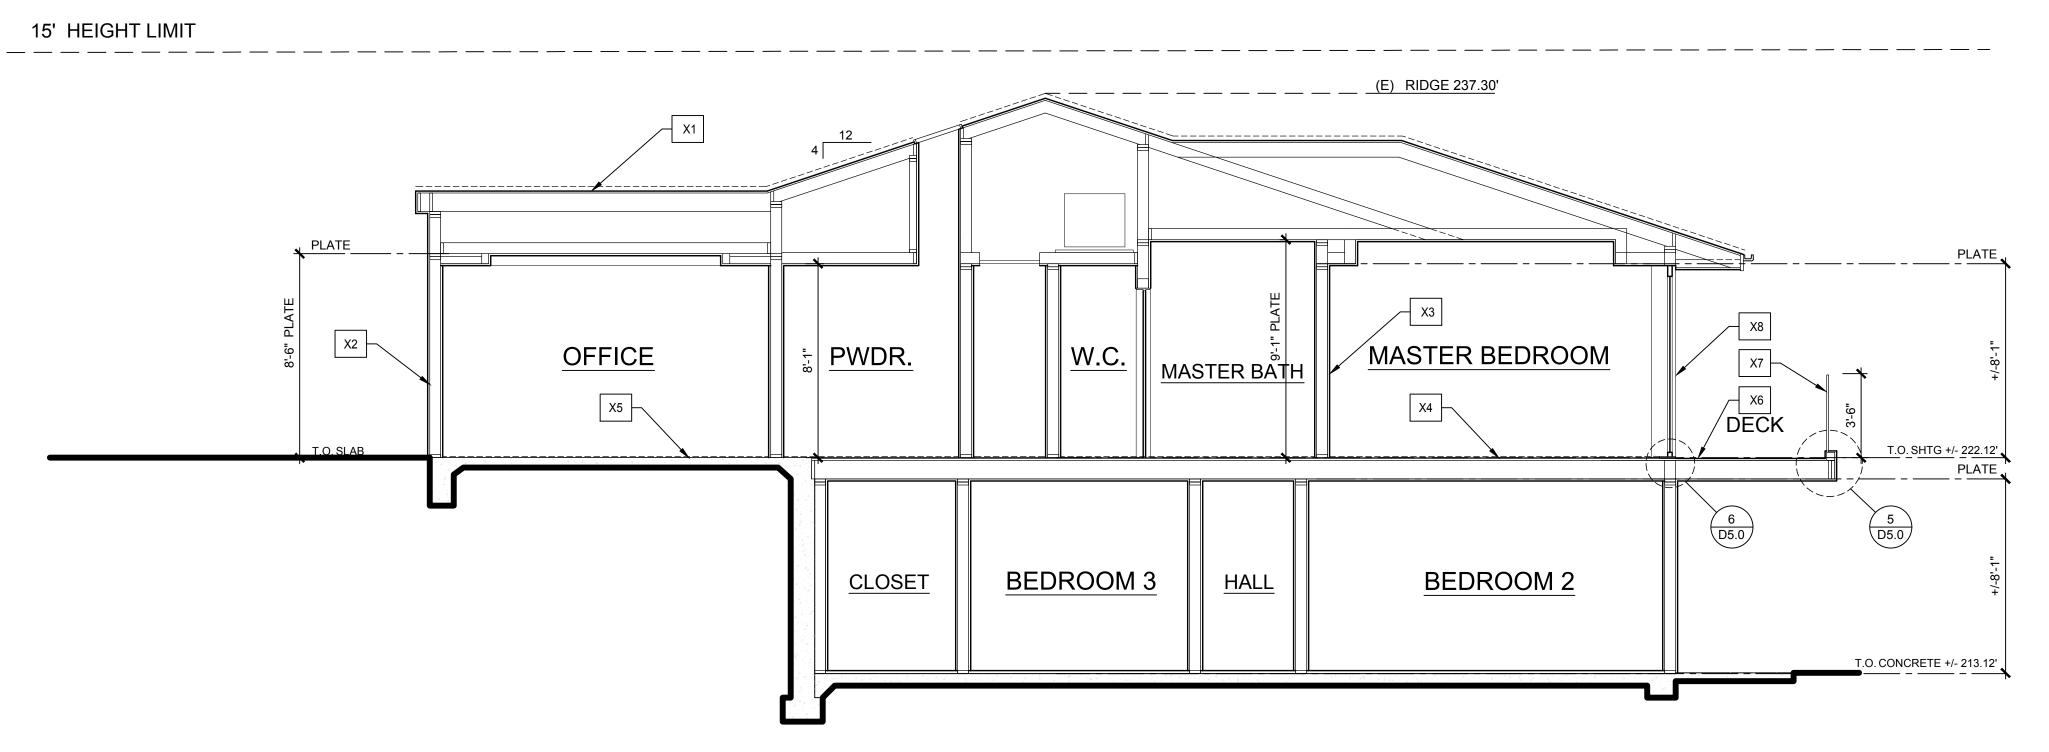
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ROOF PLAN

CJLA No. 2120 1/4"=1'-0" 7-26-22 Scale: Date:





BUILDING SECTION B

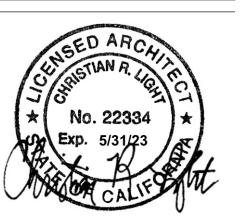GENERAL NOTES

- A. TYPICAL CONSTRUCTION ASSEMBLIES: CROSS SECTIONS OF TYPICAL CONSTRUCTION ASSEMBLIES ARE DESCRIBED BY A CONSECUTIVE LISTING OF MATERIAL. EXTERIOR ASSEMBLIES SUCH AS ROOFS AND EXTERIOR WALLS LIST MATERIALS IN ORDER FROM EXTERIOR SURFACES TO INTERIOR SURFACES. HORIZONTAL ASSEMBLIES SUCH AS FLOORS AND SLABS LIST MATERIAL FORM TOP TO BOTTOM. INTERIOR ASSEMBLIES LIST MATERIALS FROM ONE SIDE TO OTHER. REFER TO DETAILS AND SPECIFICATIONS FOR INSTALLATION AND ADDITIONAL INFORMATION. B. STRUCTURAL FRAMING:
 - REFER TO STRUCTURAL DRAWINGS FOR FRAMING MEMBER SPECIES, GRADES, SIZES, SPACING, CONNECTIONS, ROOF AND FLOOR SHEATHING, PLYWOOD SHEAR WALLS AND ADDITIONAL INFORMATION

C.J. LIGHT **ASSOCIATES**

CHRISTIAN R. LIGHT, ARCHITECT

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SECTION NOTES

XX SYMBOL

- 0. SECTIONS1. TYPICAL SLOPED ROOF ASSEMBLY: A. ROOFING MATERIAL - PER ROOF PLAN.
- B. UNDERLAYMENT PER MANUFACTURER'S RECOMMENDATIONS.
- C. PLYWOOD SHEATHING PER STRUCTURAL ENGINEER.
- D. CALIFORNIA FRAMING (WHERE OCCURS).
- E. WOOD RAFTERS PER STRUCT DWGS F. INSULATION PER T-24 CALCS.
- G. 2x CEILING JOISTS (WHERE OCCURS). H. %" GYPSUM WALLBOARD

ALL WOOD BASED SHEATHING)

- 2. TYPICAL EXTERIOR WALL ASSEMBLY: A. EXTERIOR CLADDING MATERIAL (PROVIDE 2 LAYERS GRADE 'D' BUILDING PAPER MIN O/
- B. PLYWOOD SHEAR PANELS PER STRUCT
- C. 2 x 6 WALL FRAMING WITH R-19 INSULATION PER T-24.
- D. 5/8" GYPSUM WALLBOARD
- 3. TYPICAL INTERIOR WALL ASSEMBLY: A. 5/8" GYPSUM WALLBOARD (TYPE "X" WHERE
- REQUIRED). B. 2 x 4 or 2 x 6 WALL FRAMING.
- C. PLYWOOD SHEAR PANELS (WHERE
- D. 5/8" GYPSUM WALLBOARD (TYPE "X" WHERE
- REQUIRED). 4. TYPICAL FLOOR/CEILING ASSEMBLY
- A. FLOOR FINISH
- B. SUBFLOOR SHEATHING MATERIAL THICKNESS PER STRUCT. ENGINEER.
- C. FLOOR JOISTS PER STRUCT. ENGINEER. D. 2x WOOD FURRING (WHERE OCCURS).
- E. 5/8" GYPSUM WALLBOARD (TYPE "X" WHERE
- OCCURS) OR OTHER CEILING FINISH CONCRETE SLAB - REFER TO STRUCTURAL
- DECK ASSEMBLY: A. WATERPROOF DECK COATING PER
- MANUFACTURER'S REQUIREMENTS
- B. EXTERIOR GRADE PLYWOOD SUBFLOOR, REFER TO STRUCTURAL DWGS.
 C. FLOOR JOISTS PER STRUCTURAL ENGINEER
 D. 2x FURRING WHERE OCCURS
 E. GYP. BD. (TYPE "X" WHERE OCCURS) OR STUCCO OVER HIGH RIBBED LATH AT SOFFITS

- 42" GUARD RAIL DOOR PER PLAN
- 9. 12" RETAINING WALL


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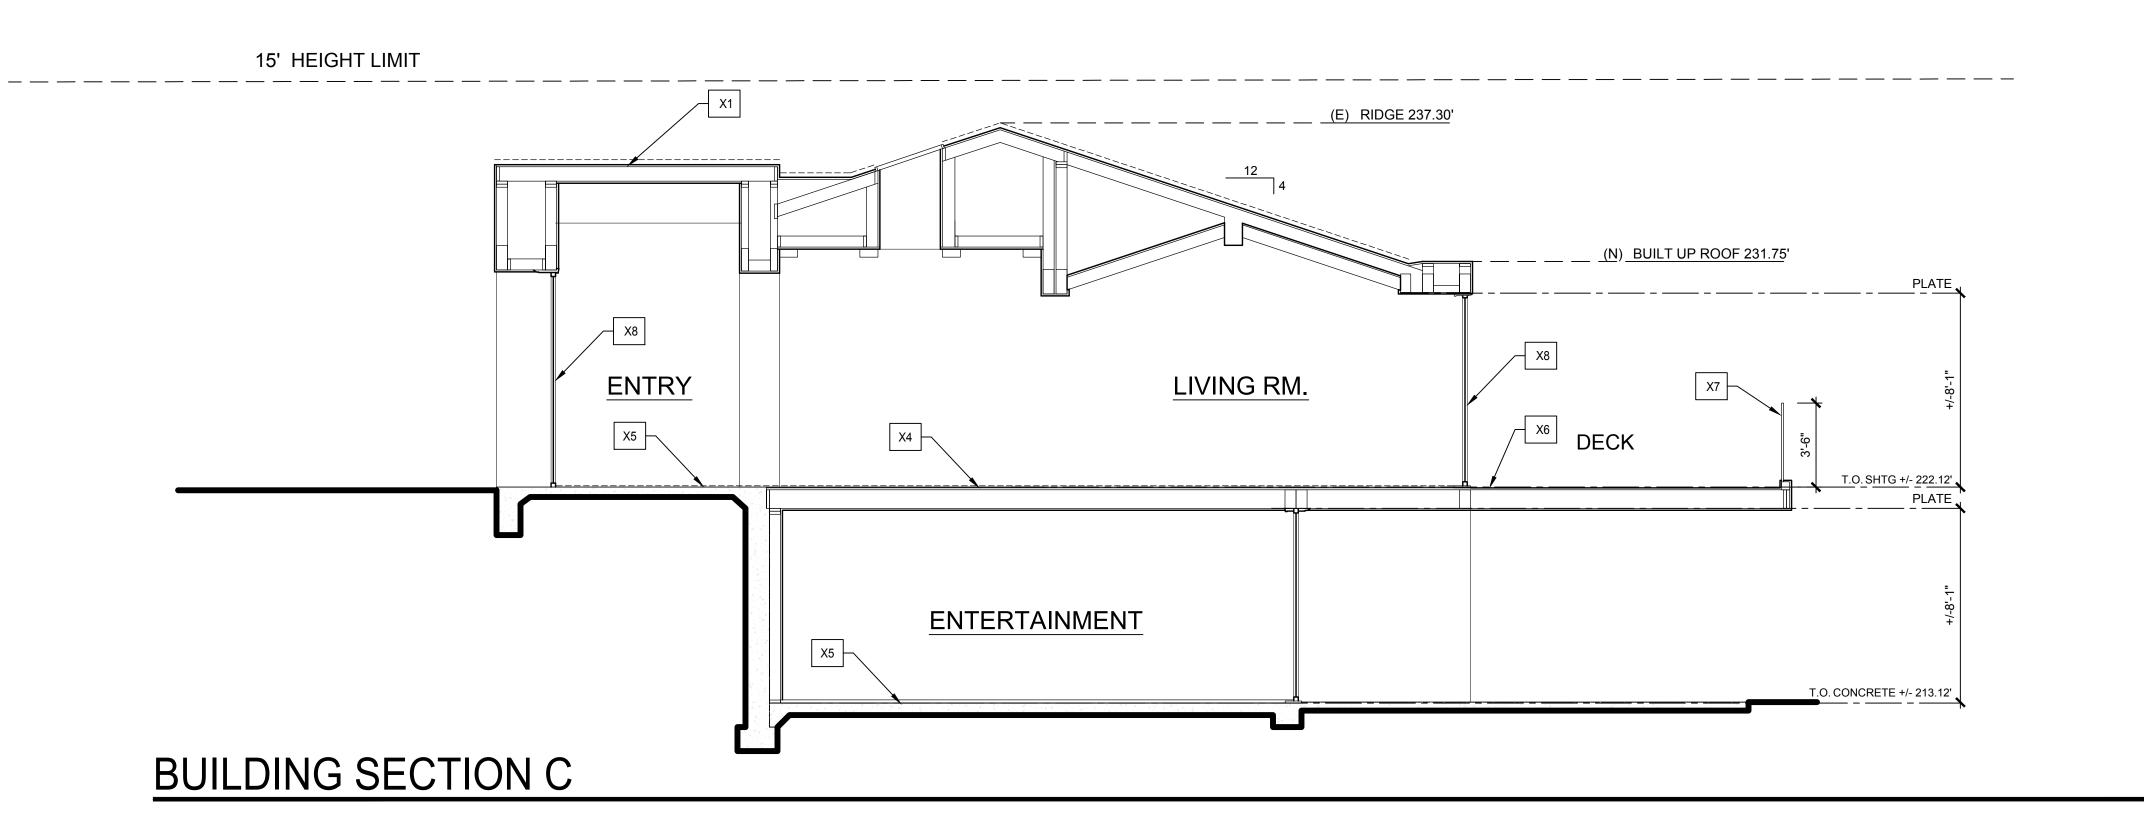
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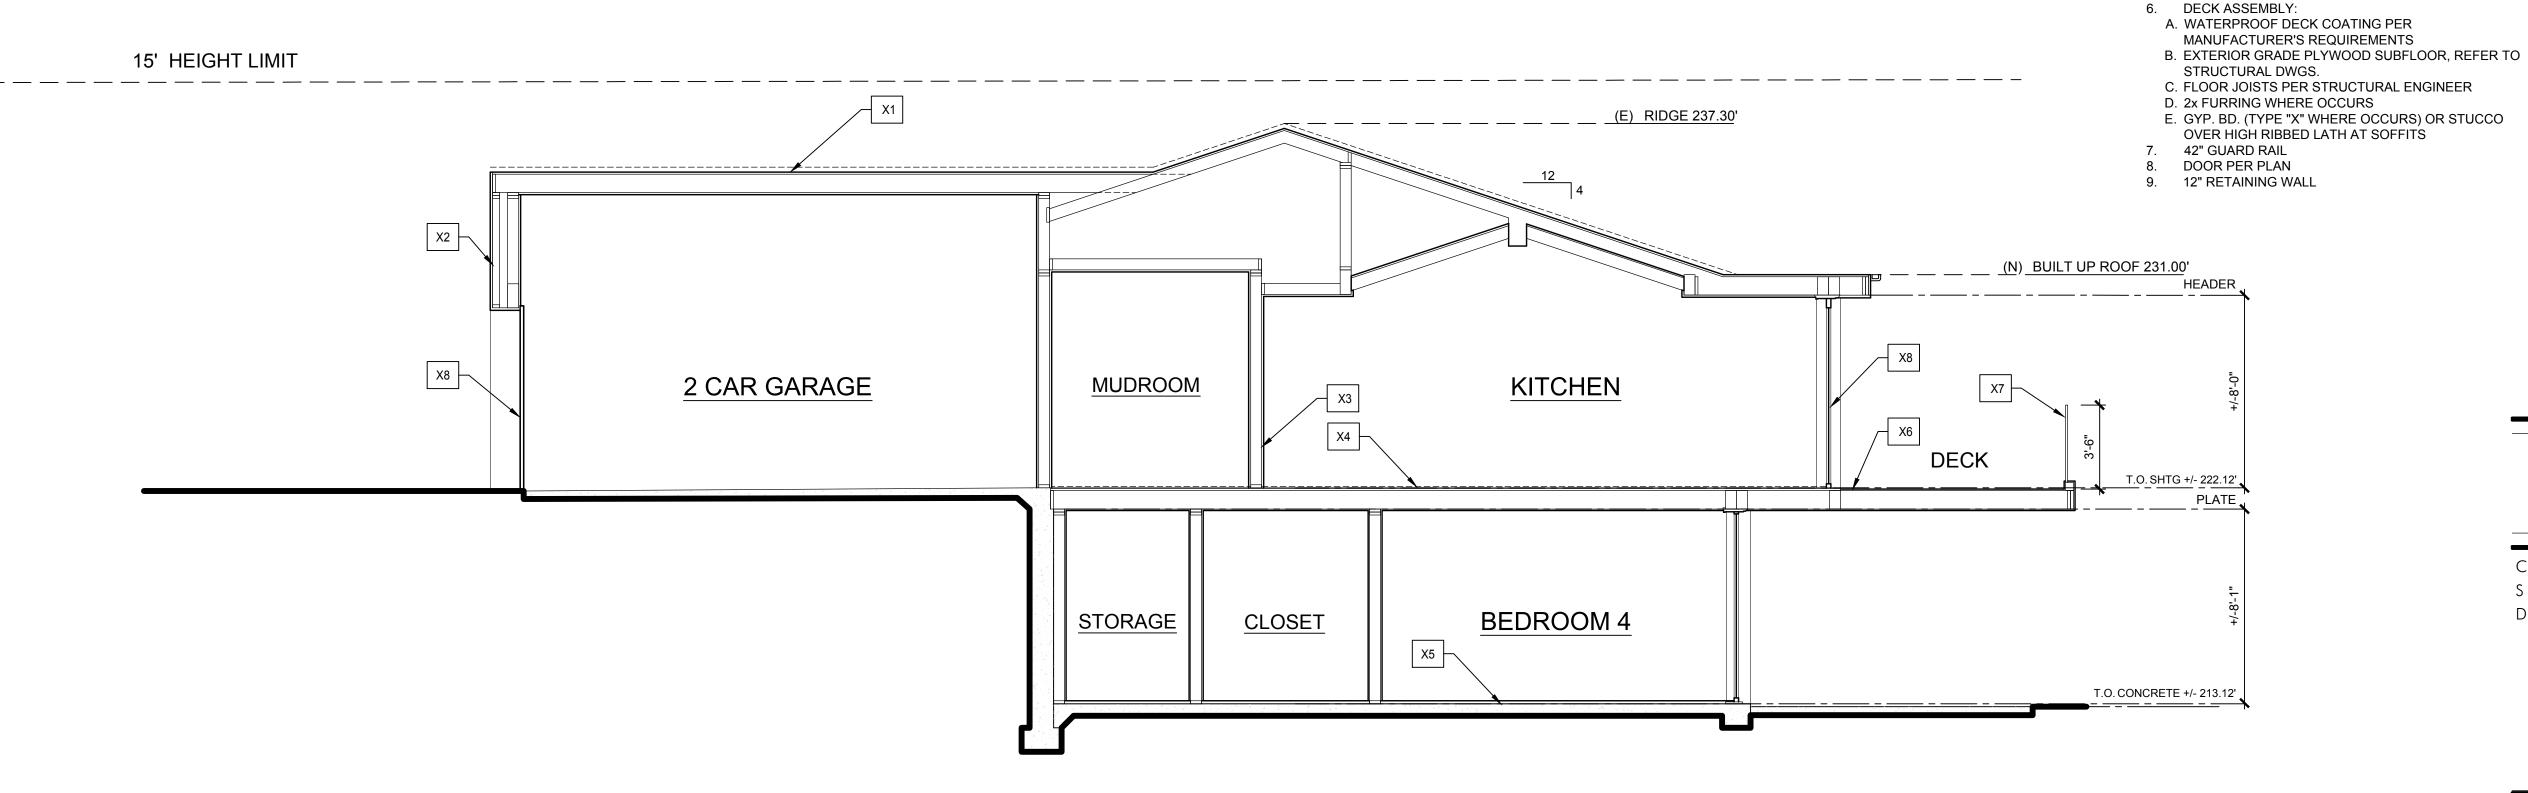
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BUILDING SECTION D



GENERAL NOTES

- A. TYPICAL CONSTRUCTION ASSEMBLIES: CROSS SECTIONS OF TYPICAL CONSTRUCTION ASSEMBLIES ARE DESCRIBED BY A CONSECUTIVE LISTING OF MATERIAL. EXTERIOR ASSEMBLIES SUCH AS ROOFS AND EXTERIOR WALLS LIST MATERIALS IN ORDER FROM EXTERIOR SURFACES TO INTERIOR SURFACES. HORIZONTAL ASSEMBLIES SUCH AS FLOORS AND SLABS LIST MATERIAL FORM TOP TO BOTTOM. INTERIOR ASSEMBLIES LIST MATERIALS FROM ONE SIDE TO OTHER. REFER TO DETAILS AND SPECIFICATIONS FOR INSTALLATION AND ADDITIONAL INFORMATION.
- B. STRUCTURAL FRAMING: REFER TO STRUCTURAL DRAWINGS FOR FRAMING MEMBER SPECIES, GRADES, SIZES, SPACING, CONNECTIONS, ROOF AND FLOOR SHEATHING, PLYWOOD SHEAR WALLS AND ADDITIONAL INFORMATION

SECTION NOTES

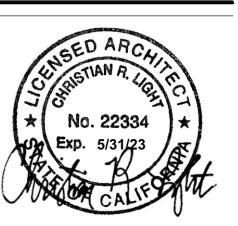0. SECTIONS1. TYPICAL SLOPED ROOF ASSEMBLY:

RECOMMENDATIONS.

F. INSULATION PER T-24 CALCS.

H. 5/8" GYPSUM WALLBOARD 2. TYPICAL EXTERIOR WALL ASSEMBLY:

D. 5/8" GYPSUM WALLBOARD

B. 2 x 4 or 2 x 6 WALL FRAMING.

4. TYPICAL FLOOR/CEILING ASSEMBLY

PER STRUCT. ENGINEER.

C. PLYWOOD SHEAR PANELS (WHERE

ENGINEER.

PER T-24.

REQUIRED).

INDICATED).

REQUIRED).

A. FLOOR FINISH

A. ROOFING MATERIAL - PER ROOF PLAN.

B. UNDERLAYMENT - PER MANUFACTURER'S

C. PLYWOOD SHEATHING - PER STRUCTURAL

D. CALIFORNIA FRAMING (WHERE OCCURS). E. WOOD RAFTERS PER STRUCT DWGS

A. EXTERIOR CLADDING MATERIAL (PROVIDE 2 LAYERS GRADE 'D' BUILDING PAPER MIN O/

C. 2 x 6 WALL FRAMING WITH R-19 INSULATION

TYPICAL INTERIOR WALL ASSEMBLY:
 A. 5/8" GYPSUM WALLBOARD (TYPE "X" WHERE

D. 5/8" GYPSUM WALLBOARD (TYPE "X" WHERE

B. SUBFLOOR SHEATHING MATERIAL THICKNESS

C. FLOOR JOISTS - PER STRUCT. ENGINEER. D. 2x WOOD FURRING (WHERE OCCURS). E. 5/8" GYPSUM WALLBOARD (TYPE "X" WHERE OCCURS) OR OTHER CEILING FINISH CONCRETE SLAB - REFER TO STRUCTURAL

G. 2x CEILING JOISTS (WHERE OCCURS).

ALL WOOD BASED SHEATHING) B. PLYWOOD SHEAR PANELS PER STRUCT

XX SYMBOL

C.J. LIGHT **ASSOCIATES**

CHRISTIAN R. LIGHT, ARCHITECT

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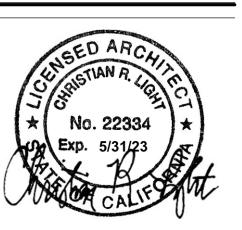
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SECTIONS

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SIZING & APPLICATION

- E1. CLAY ROOF REFER TO ROOF PLAN
- E4. SMOOTH STUCCO
- E7. STEEL / METAL WINDOWS PER PLAN
- E9. 42" IRON/ GLASS RAILING
- E12. STAINED WOOD GARAGE DOOR
- E15. WOOD LINTEL & SILL

SYMBOL

REFER TO APPLICABLE DETAILS FOR SPECIFIC

- E2. METAL ROOF REFER TO ROOF PLAN
- E3. COPPER GUTTER SYSTEM
- E5. WOOD SIDING E6. STONE
- E8. STEEL / METAL DOORS PER PLAN
- E10. WOOD SHUTTERS
- E11. 6'-0" WOOD GATE
- E13. WALL SCONCE
- E14. ENCLOSED A/C UNITS
- E16. STONE LINTEL & SILL

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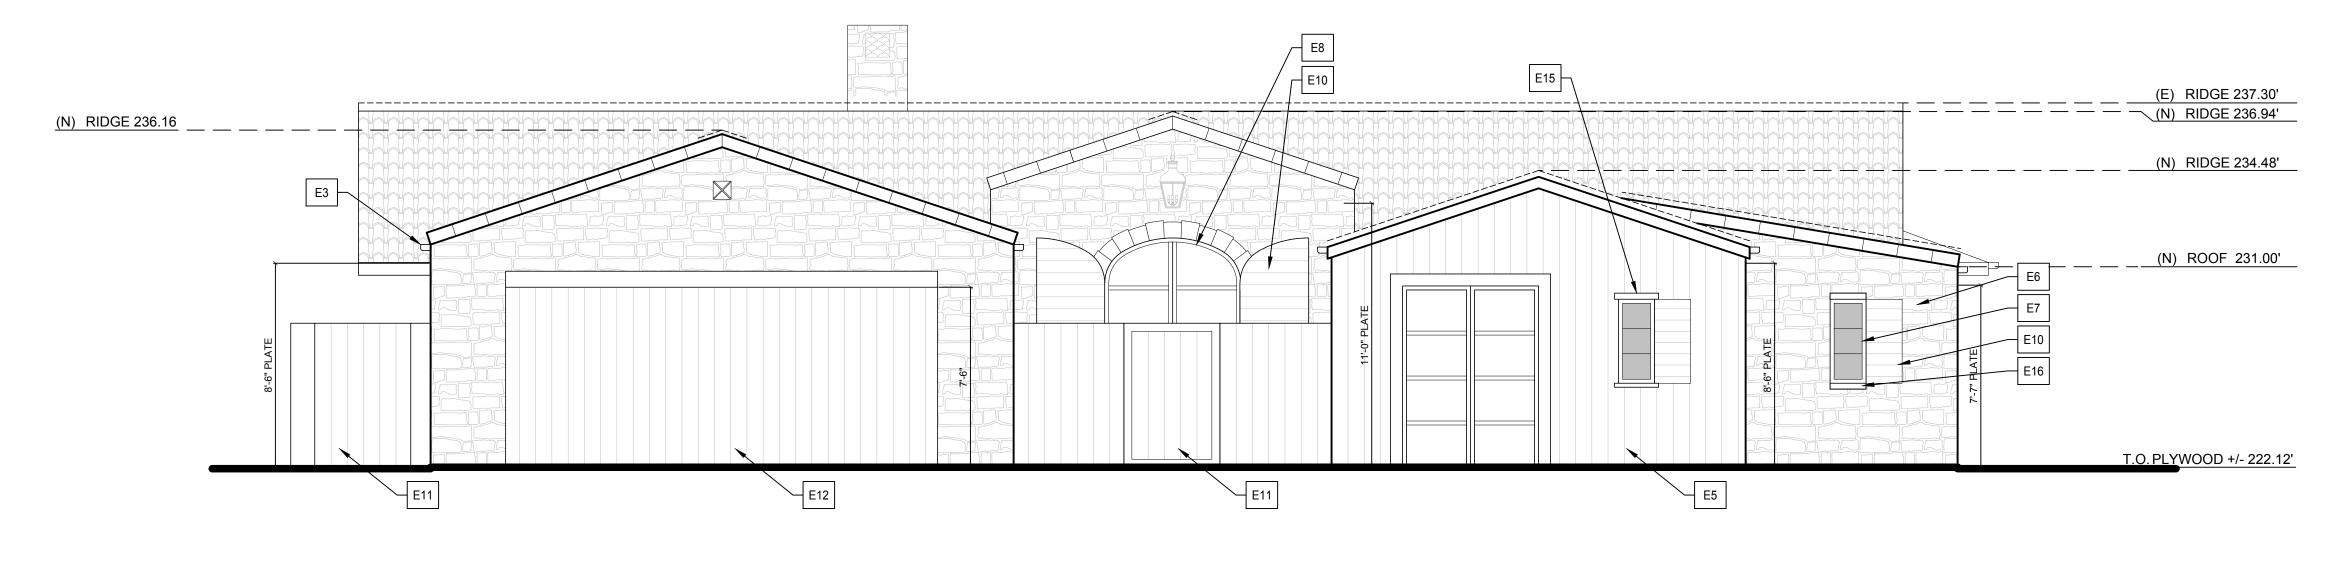
June 20, 2022

EXTERIOR ELEVATIONS


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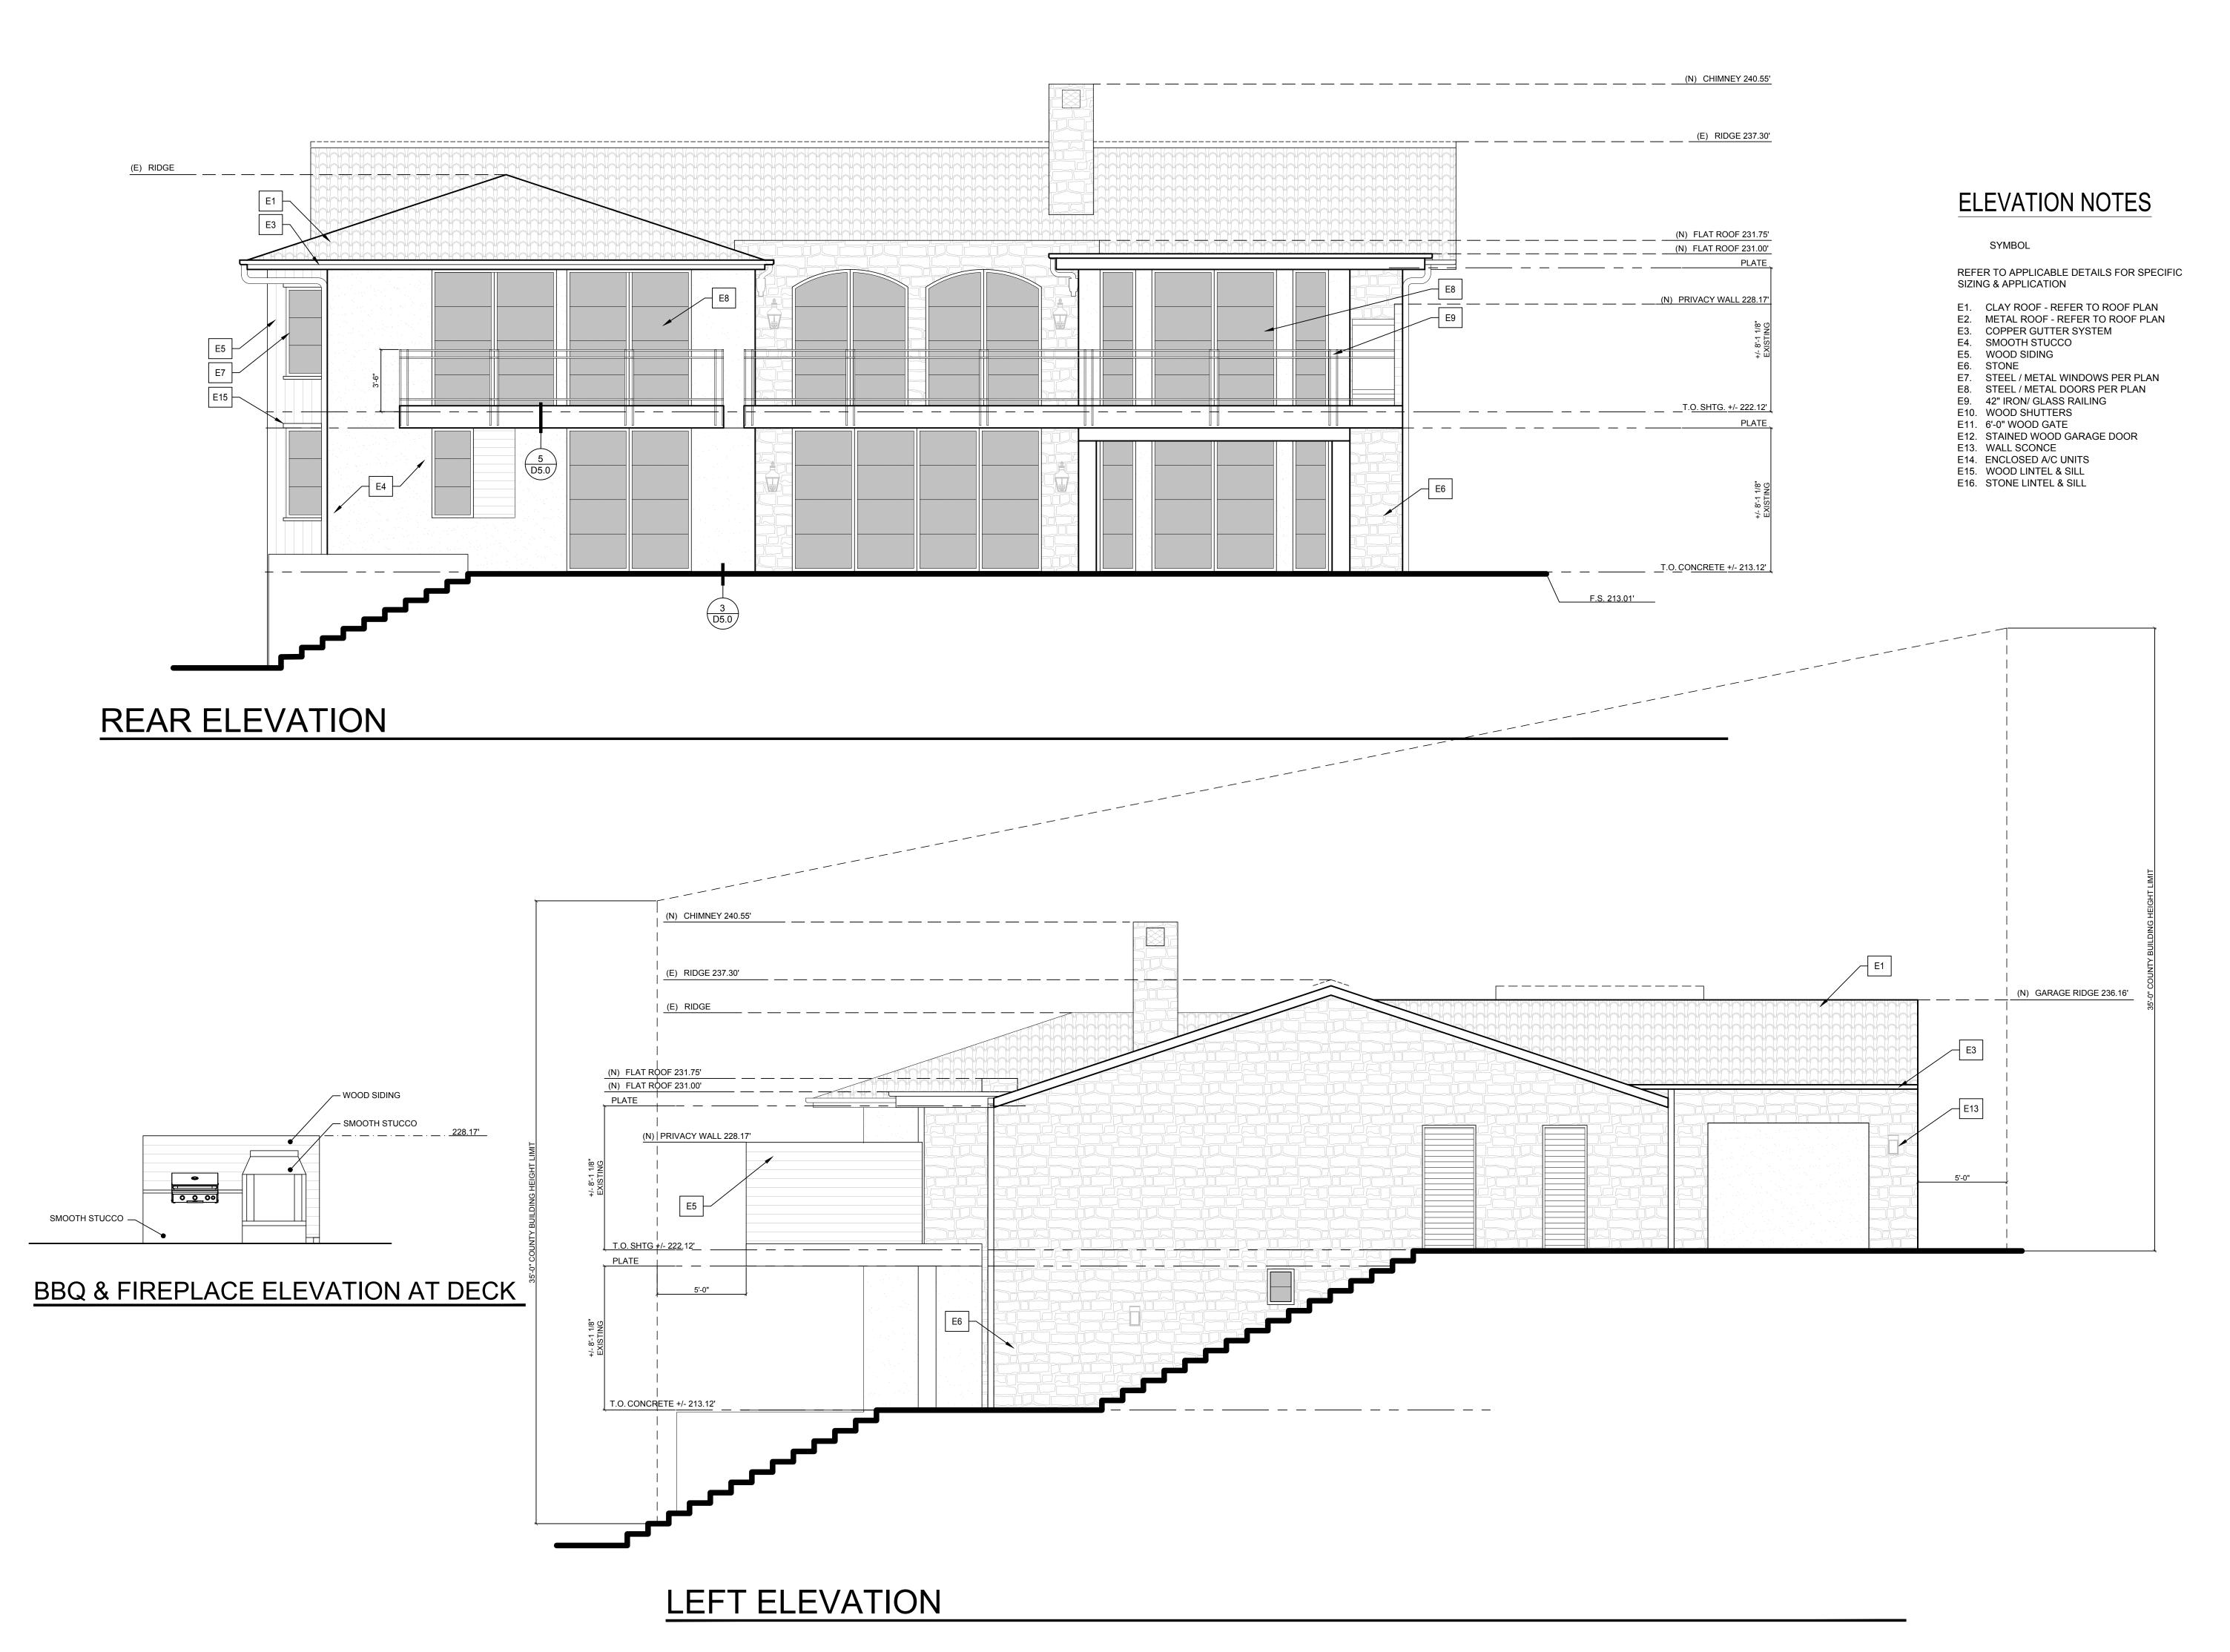
County Submittal #1

County Submittal #2



FRONT ELEVATION



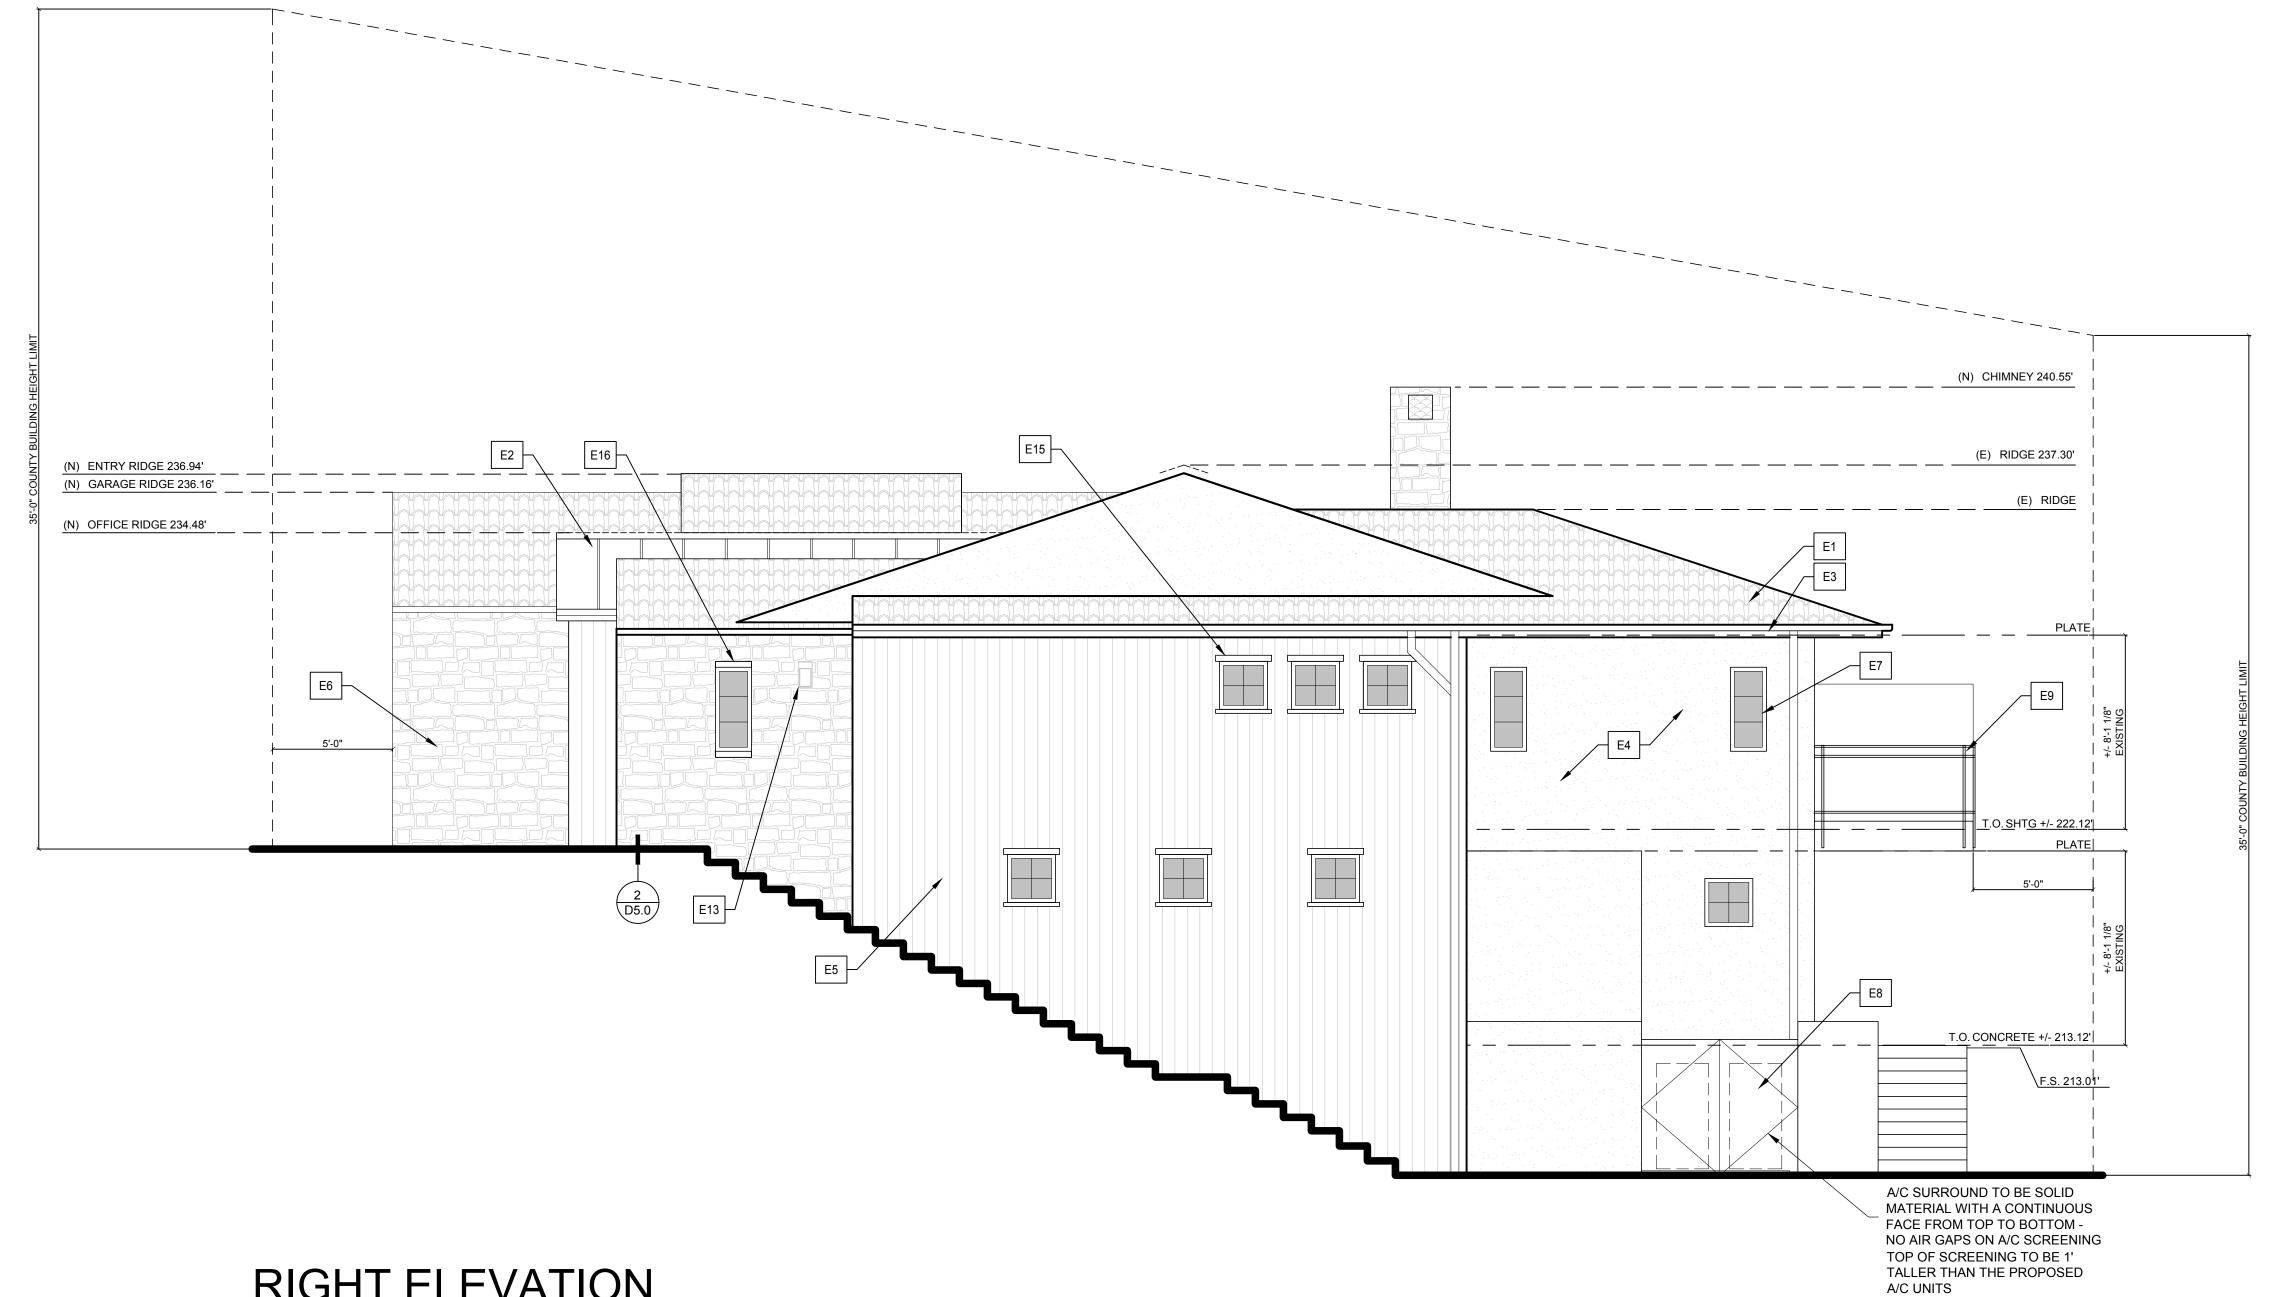



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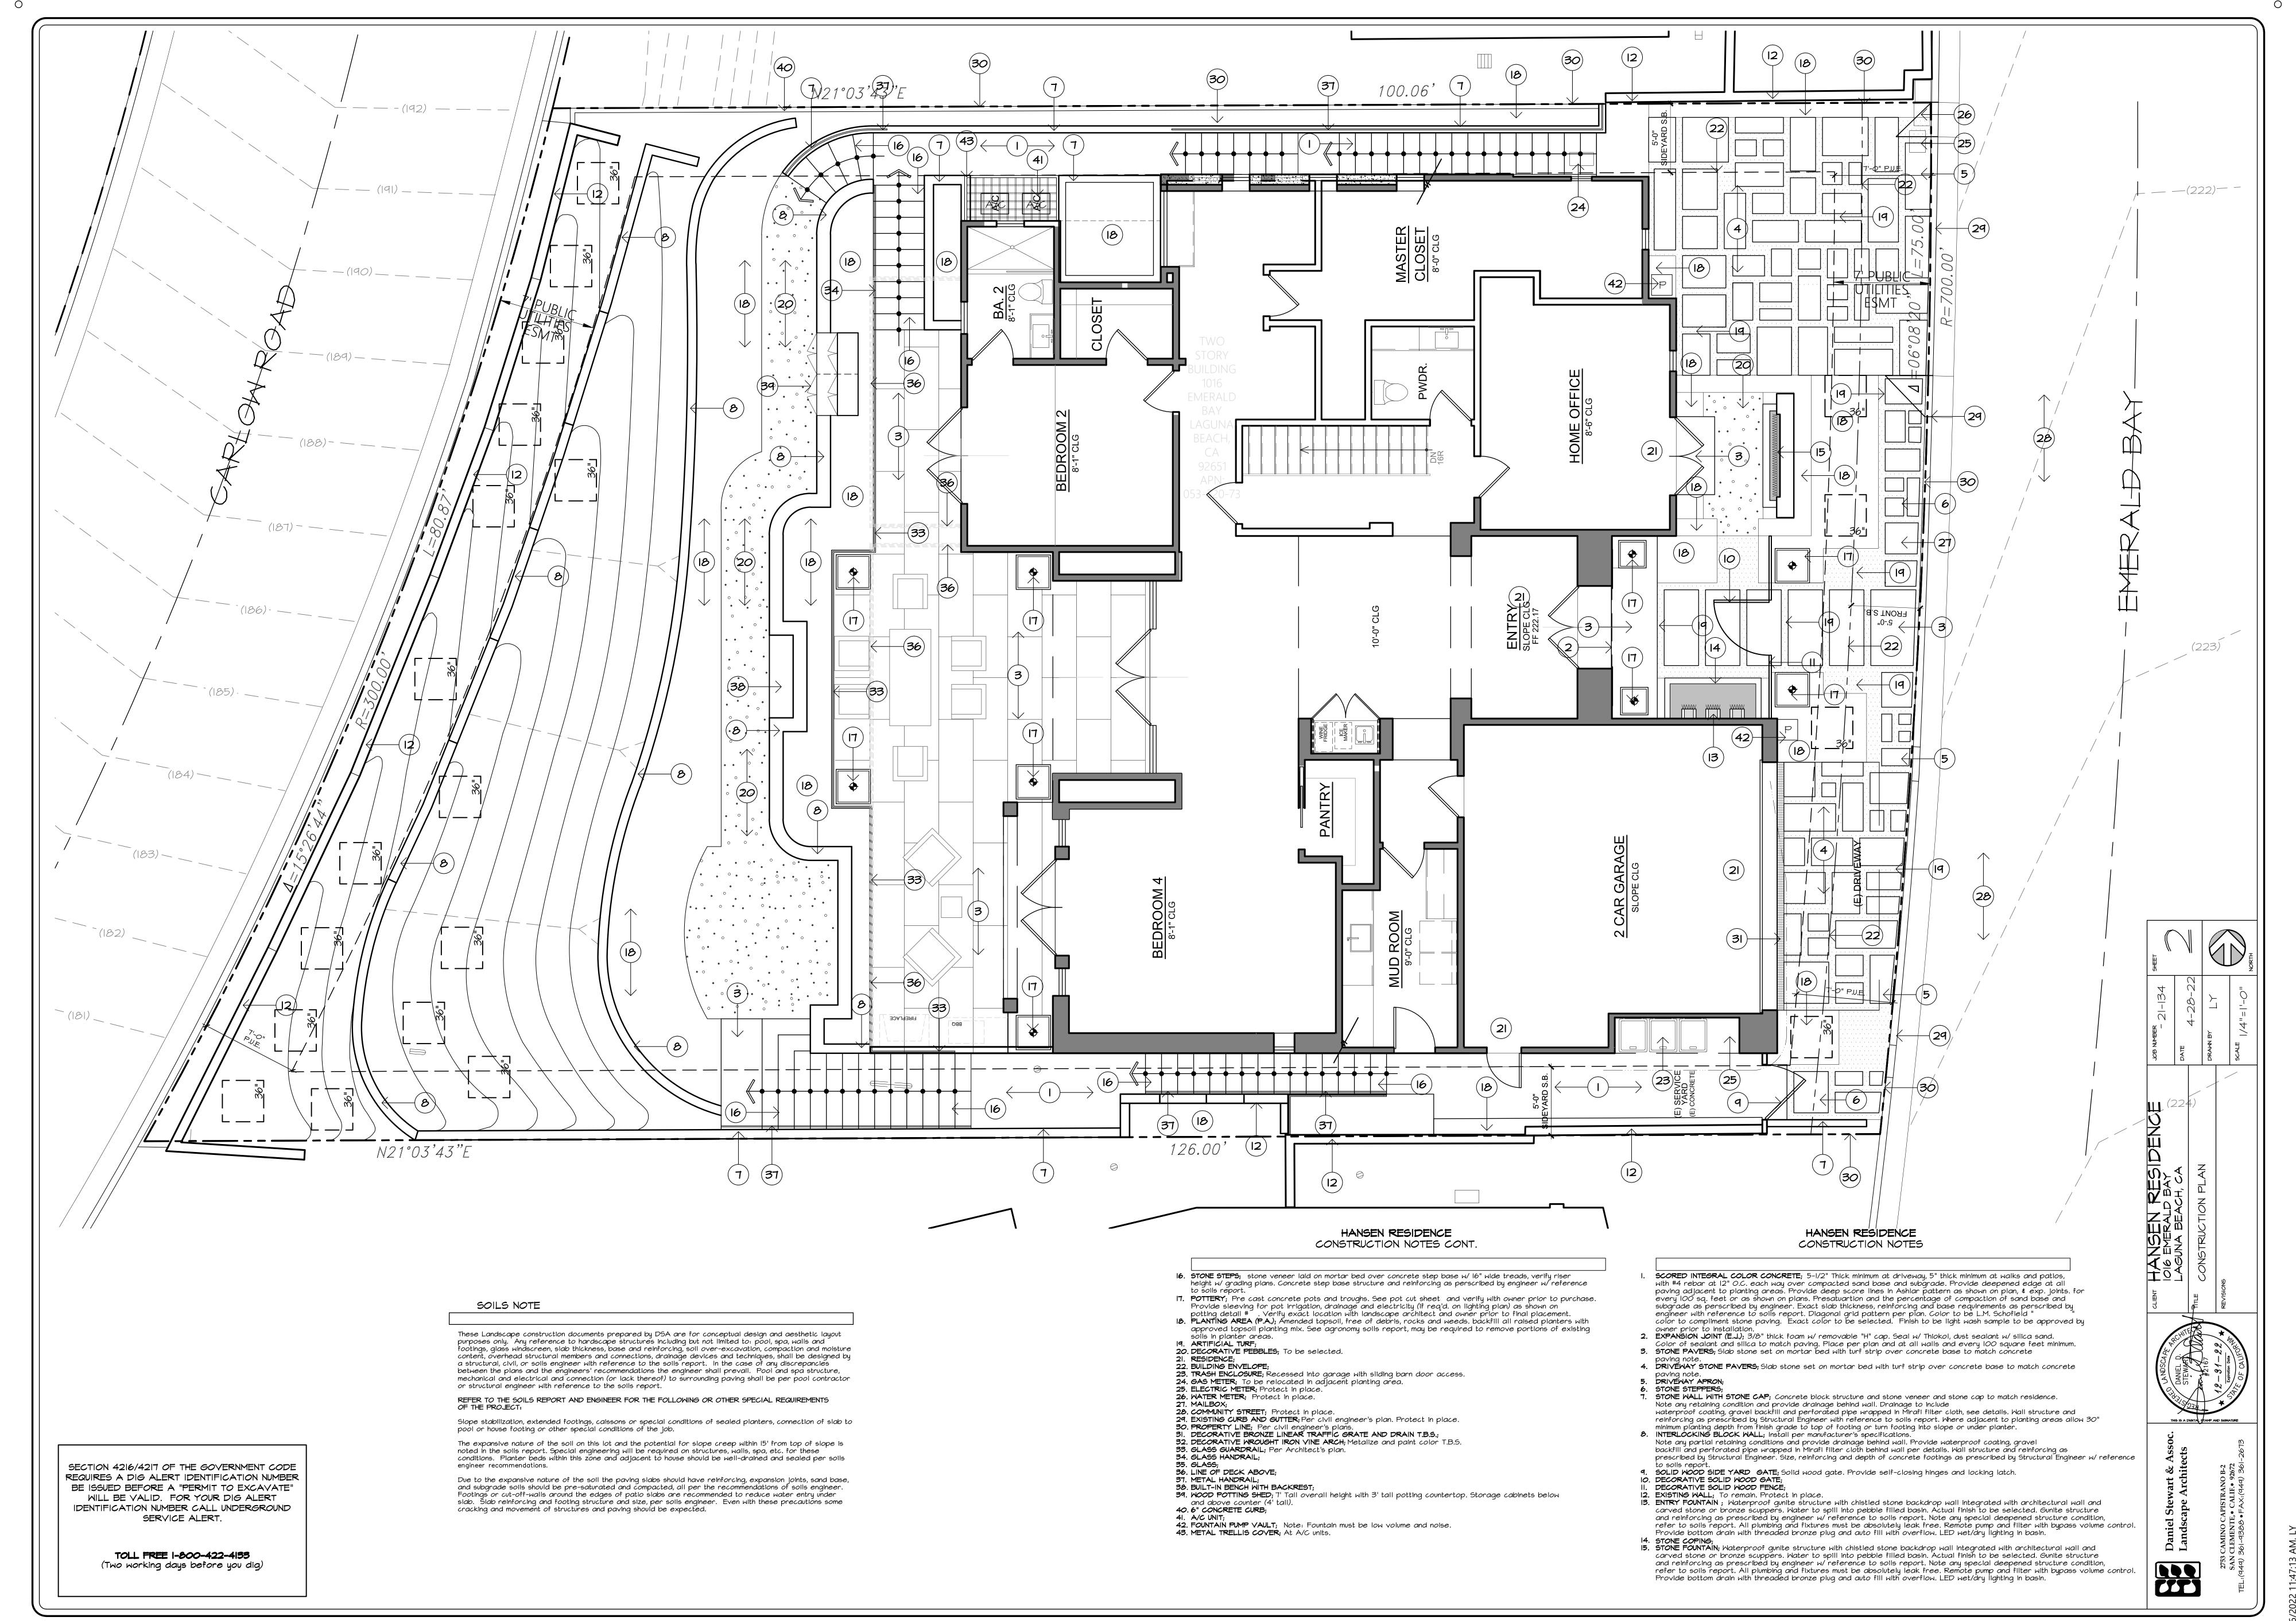
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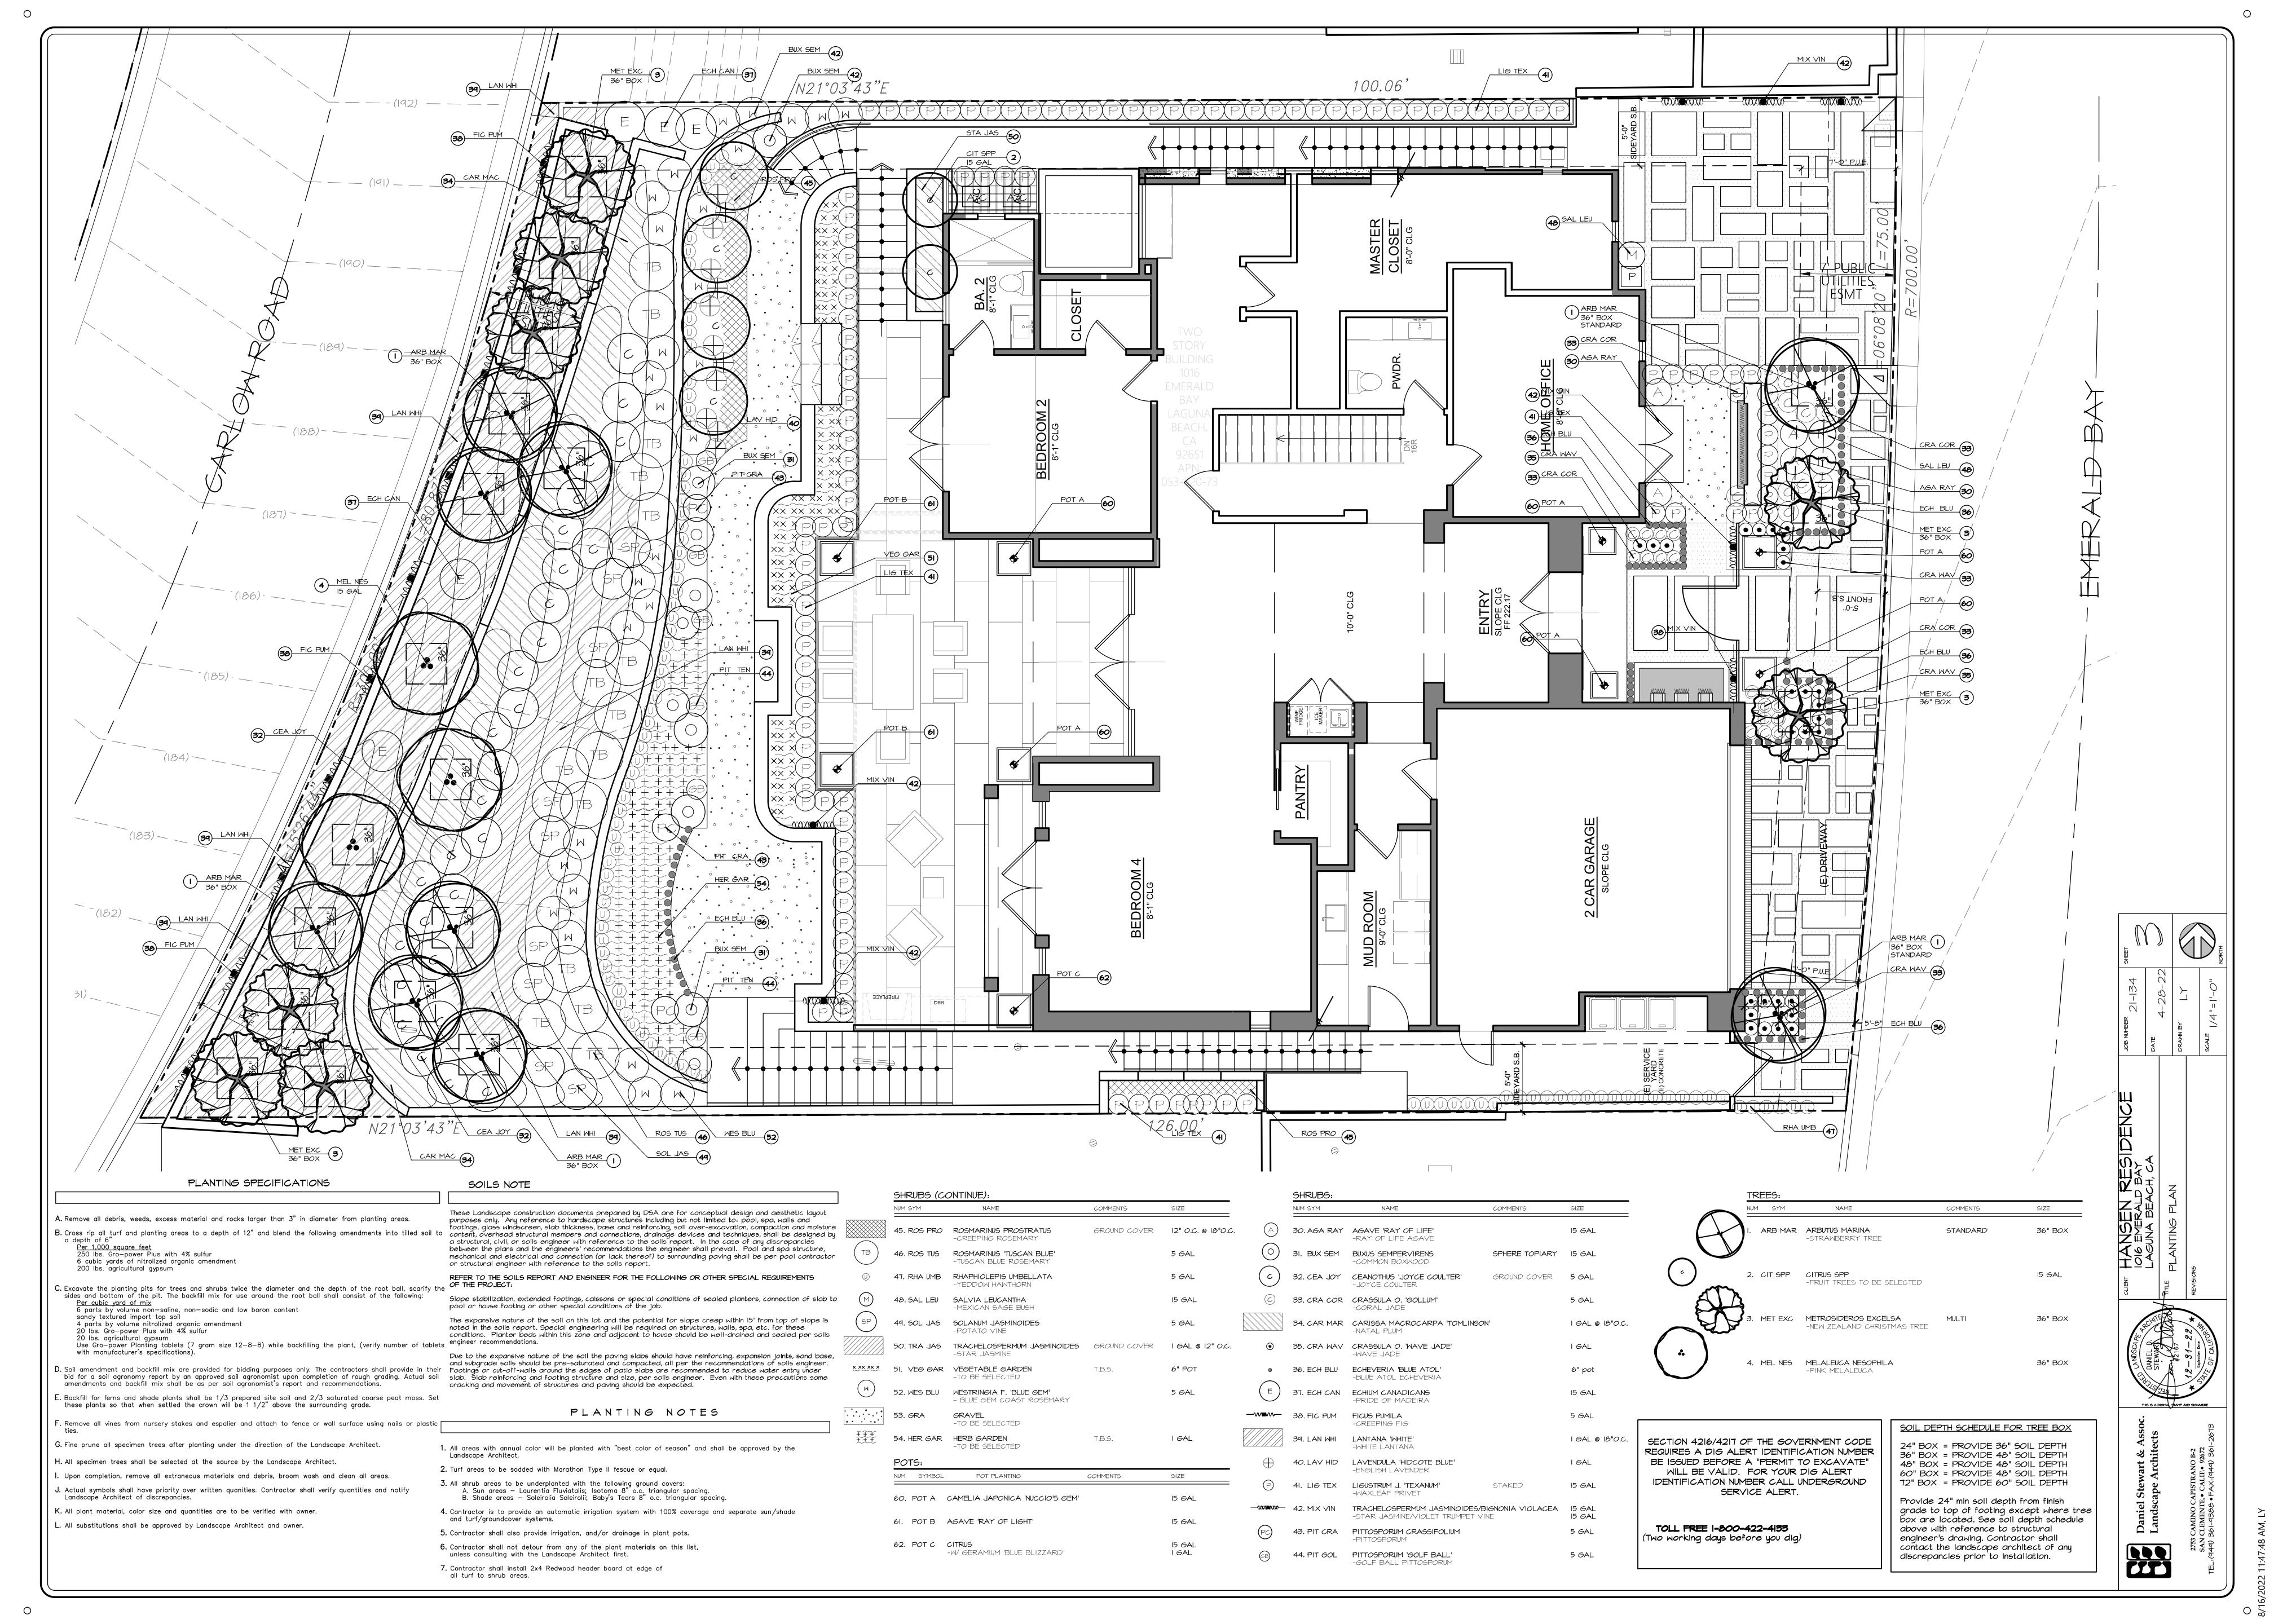
EXTERIOR ELEVATIONS


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County Submittal #1 County Submittal #2

45.1





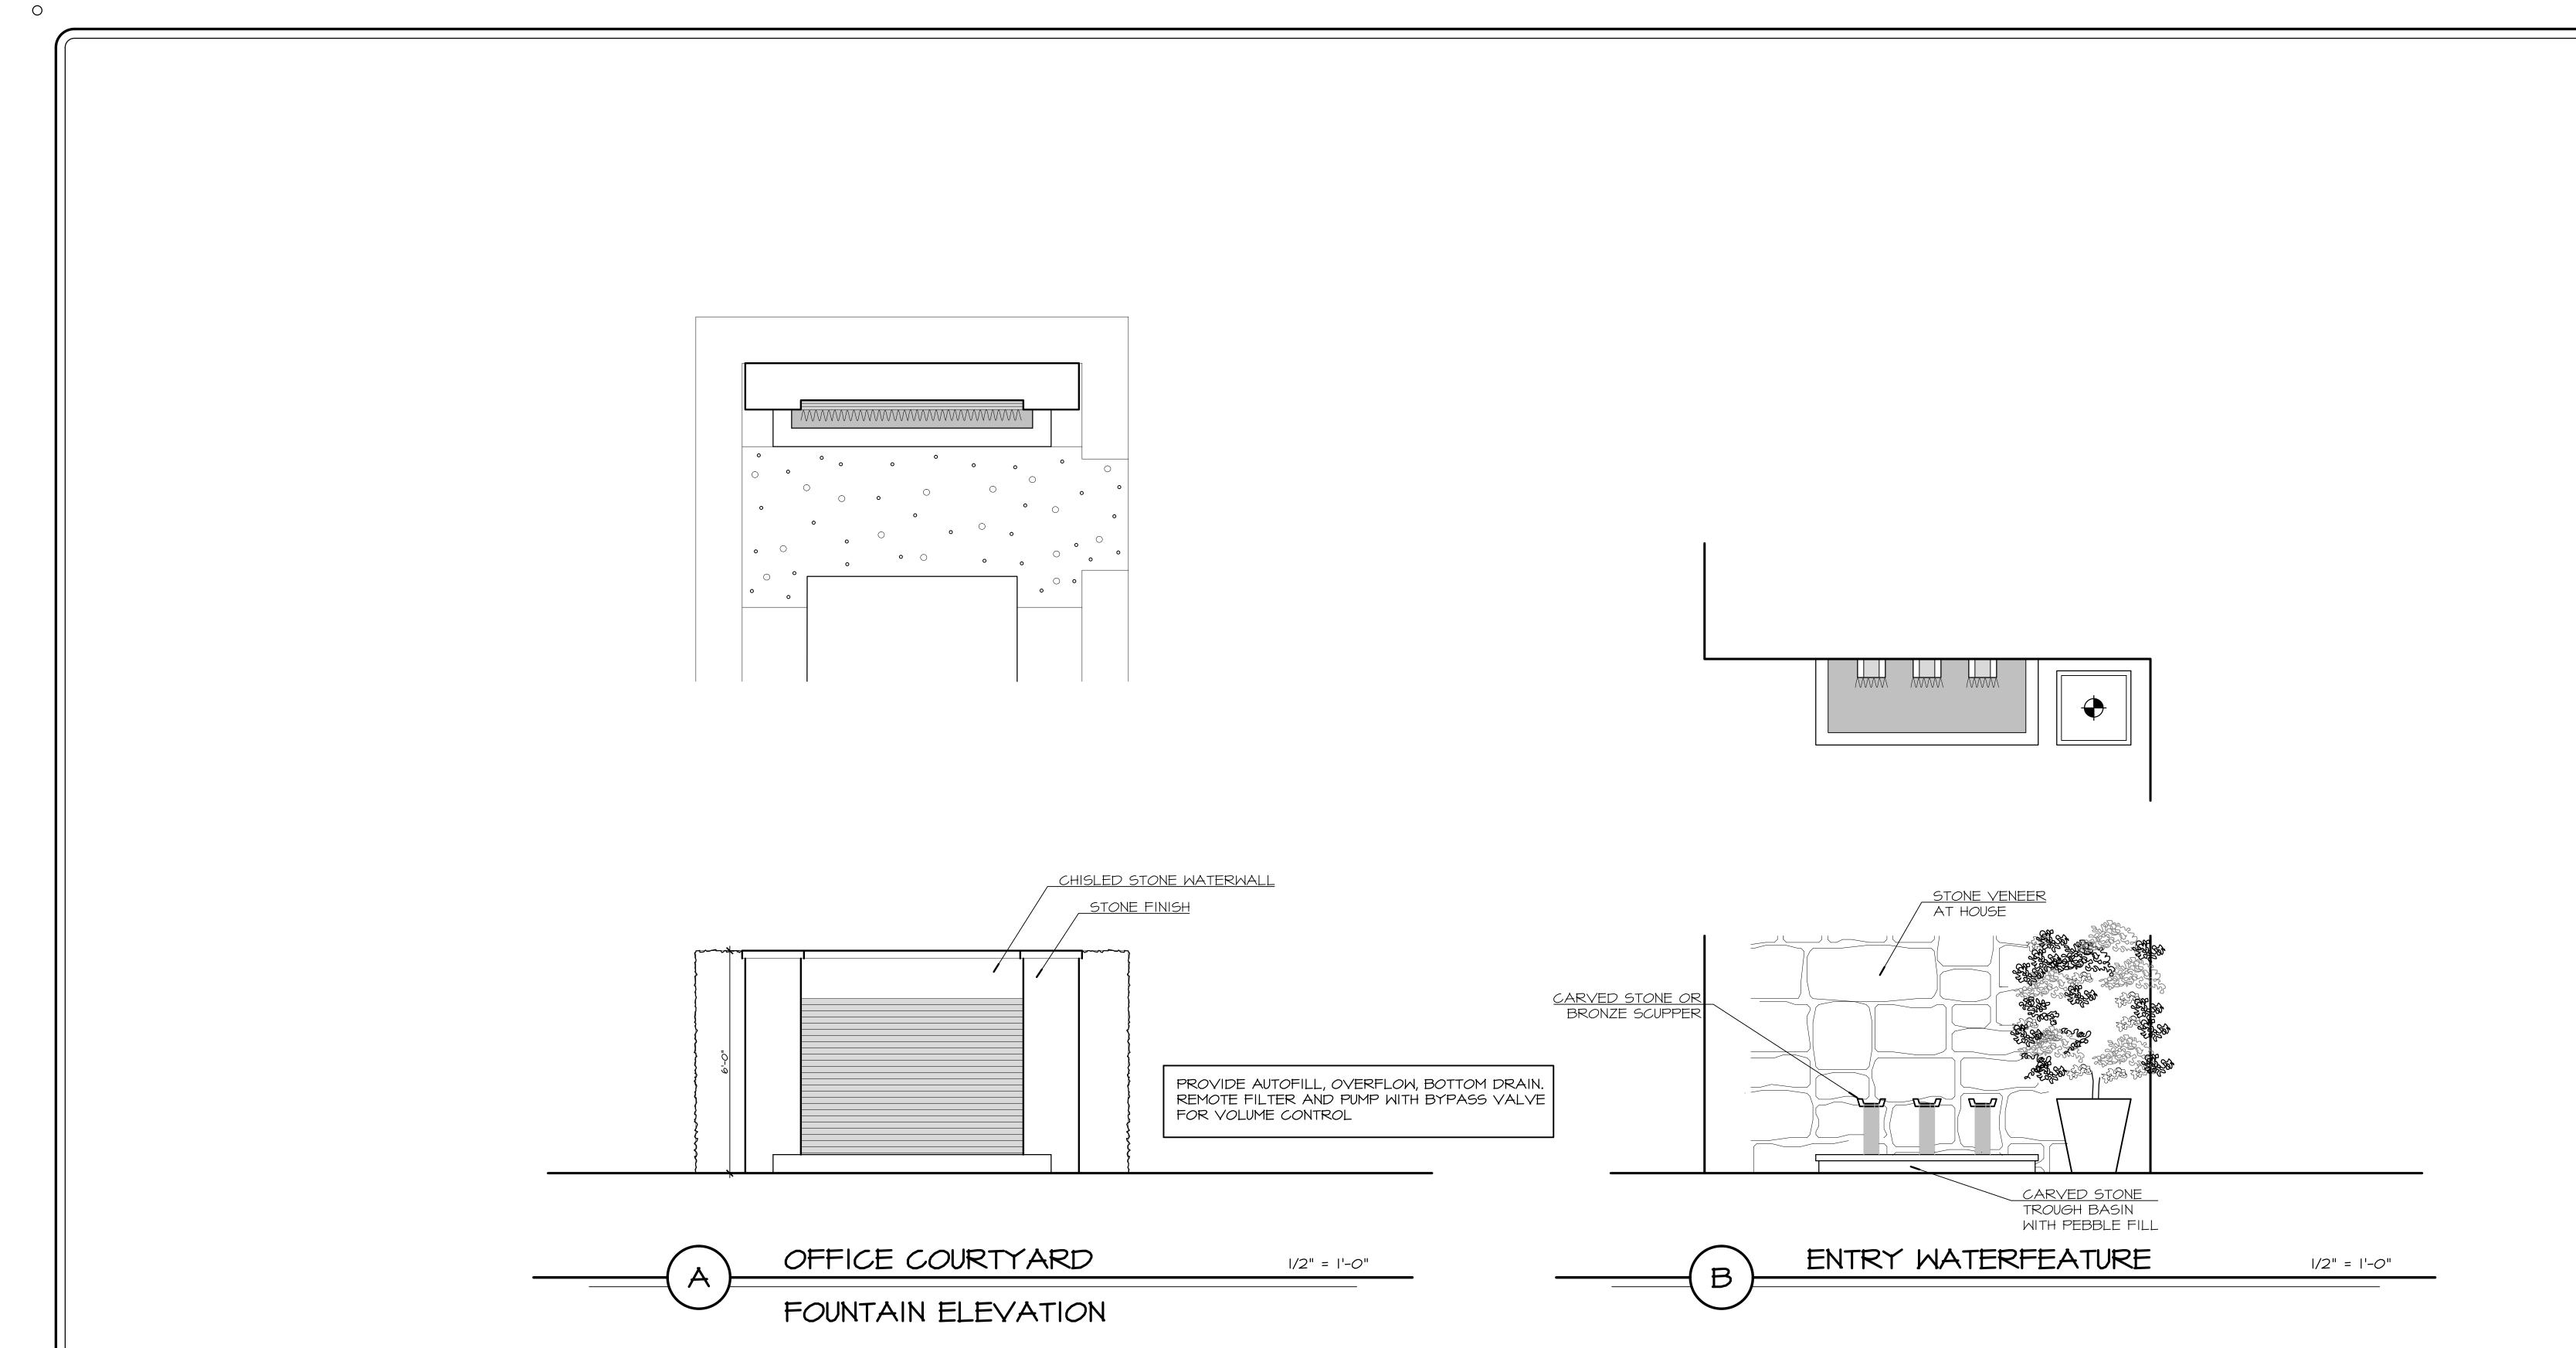

CLIENT HANSEN RESIDENCE

CLIENT HANSEN RESIDENCE

CLIENT HANSEN RESIDENCE

CLIENT HANSEN REPLICATION

LAGUNA BEACH, CA

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REVISIONS

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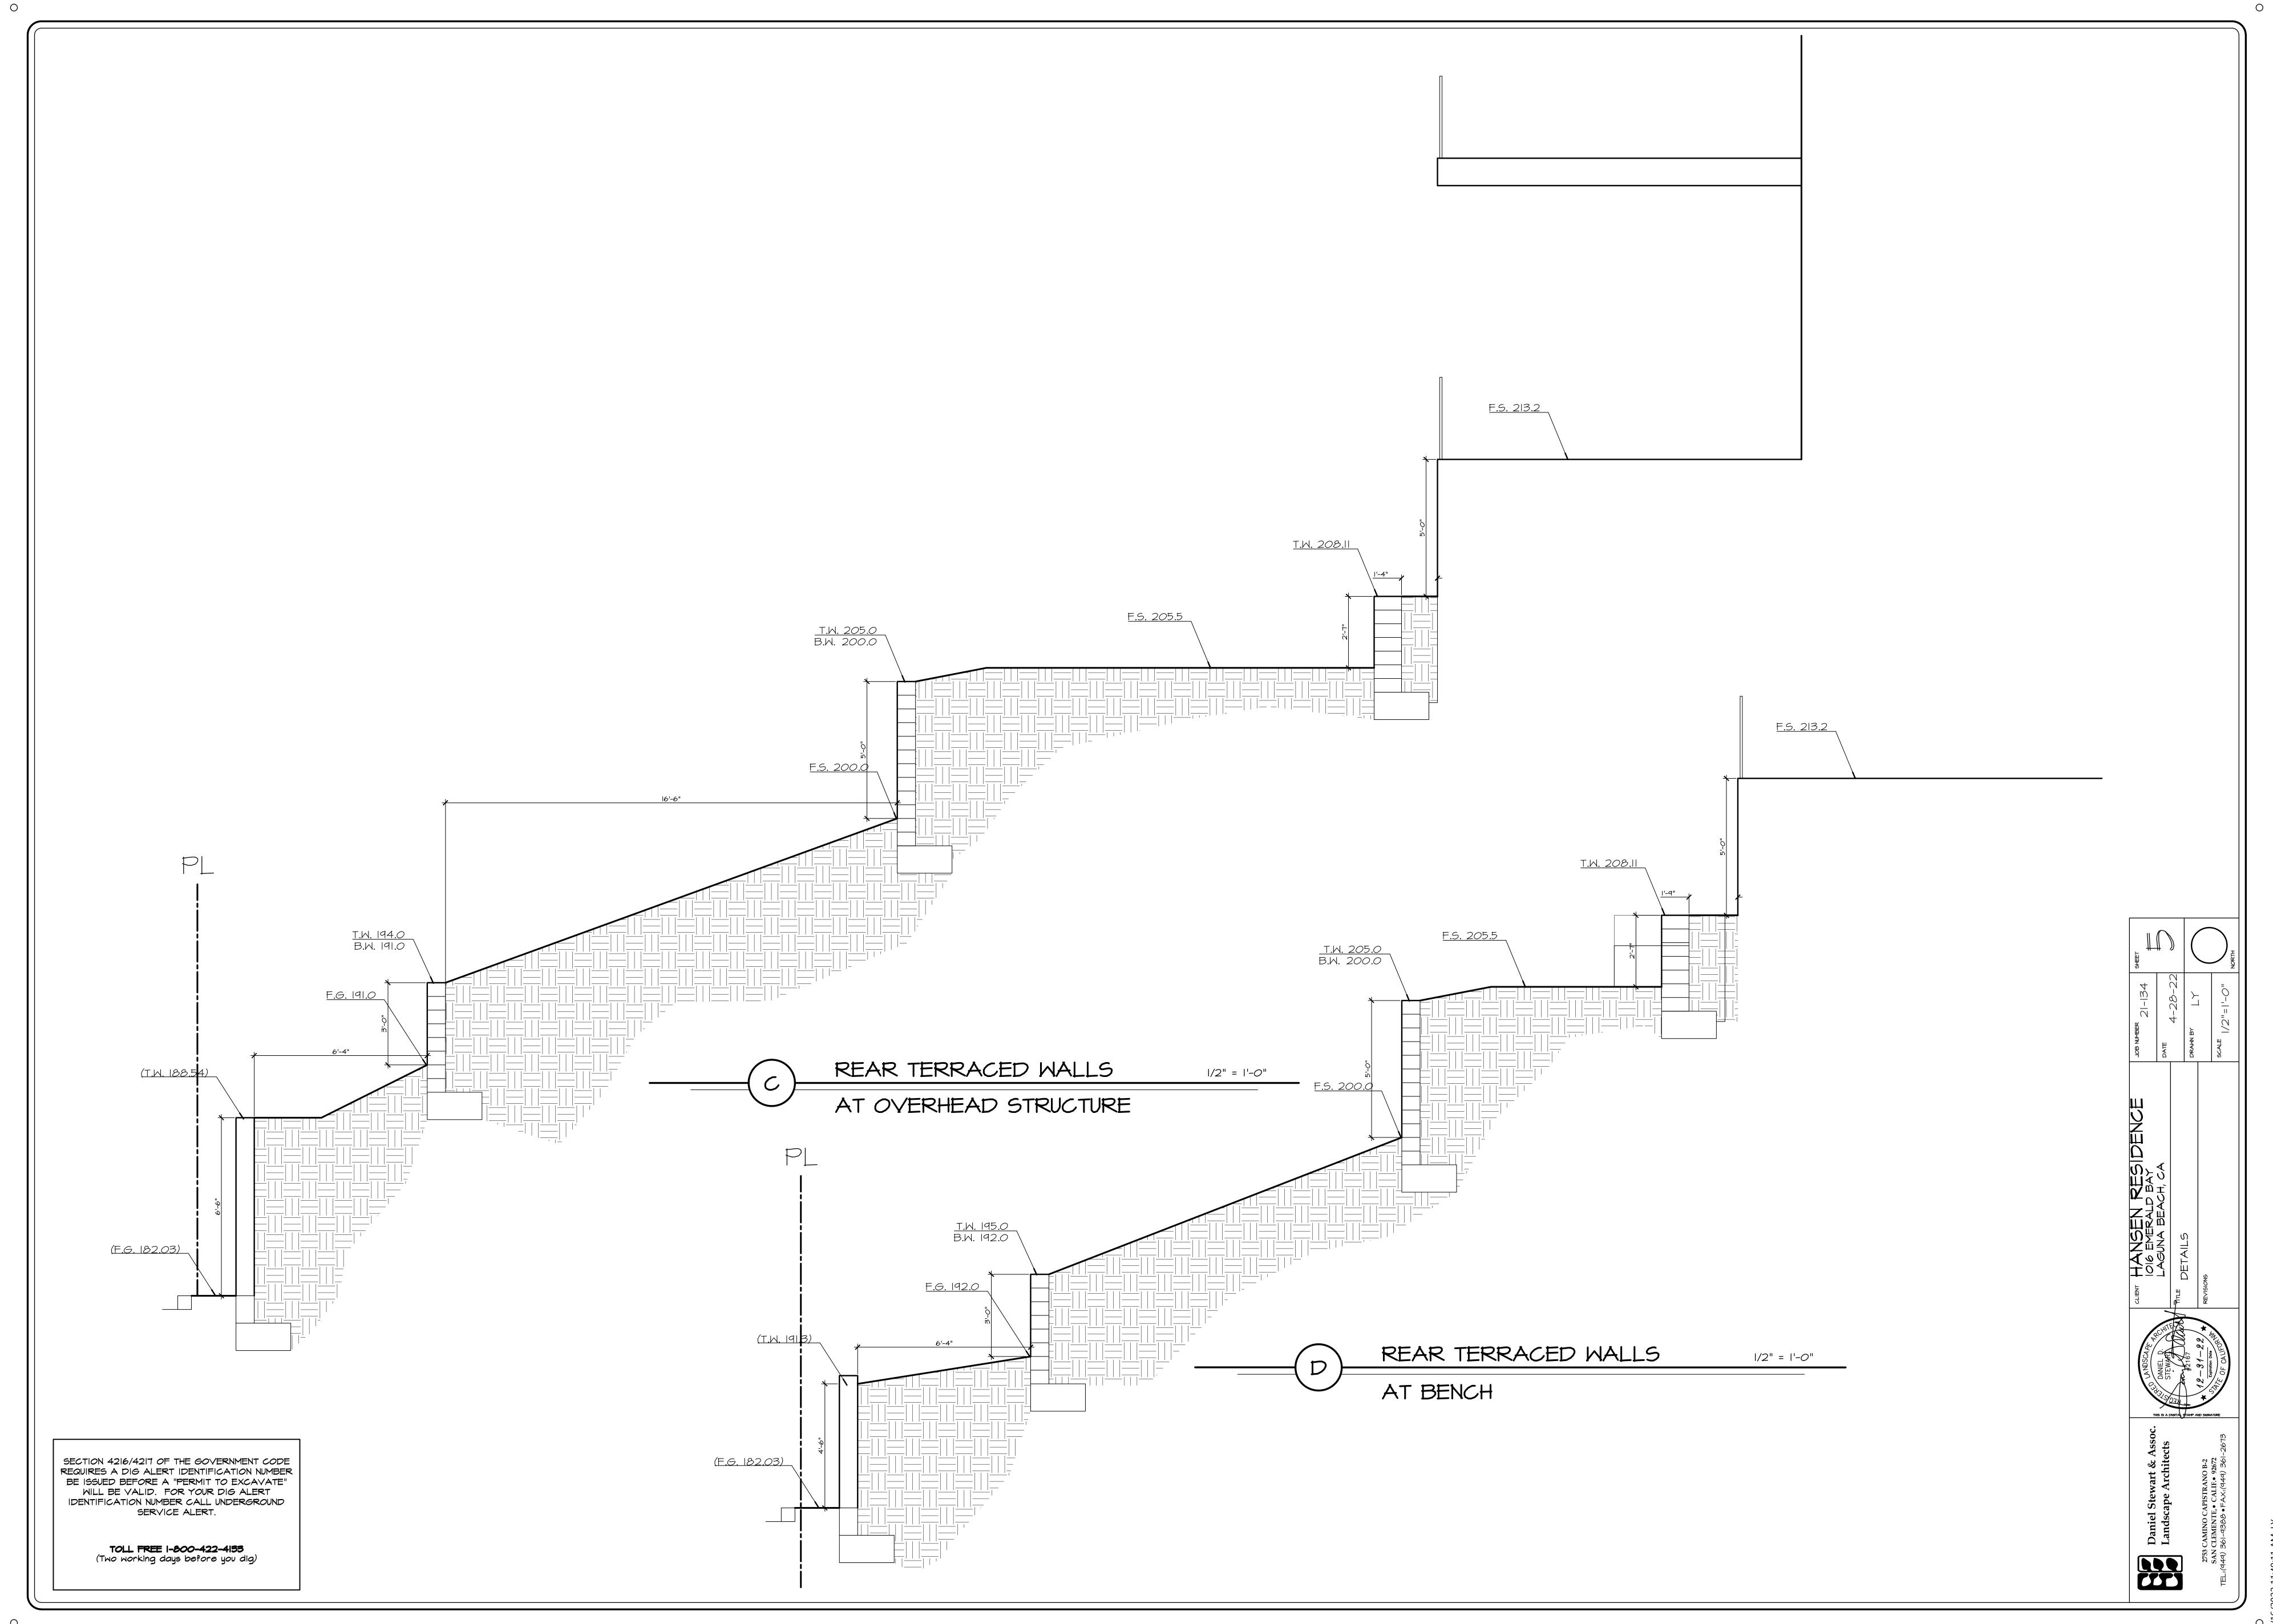
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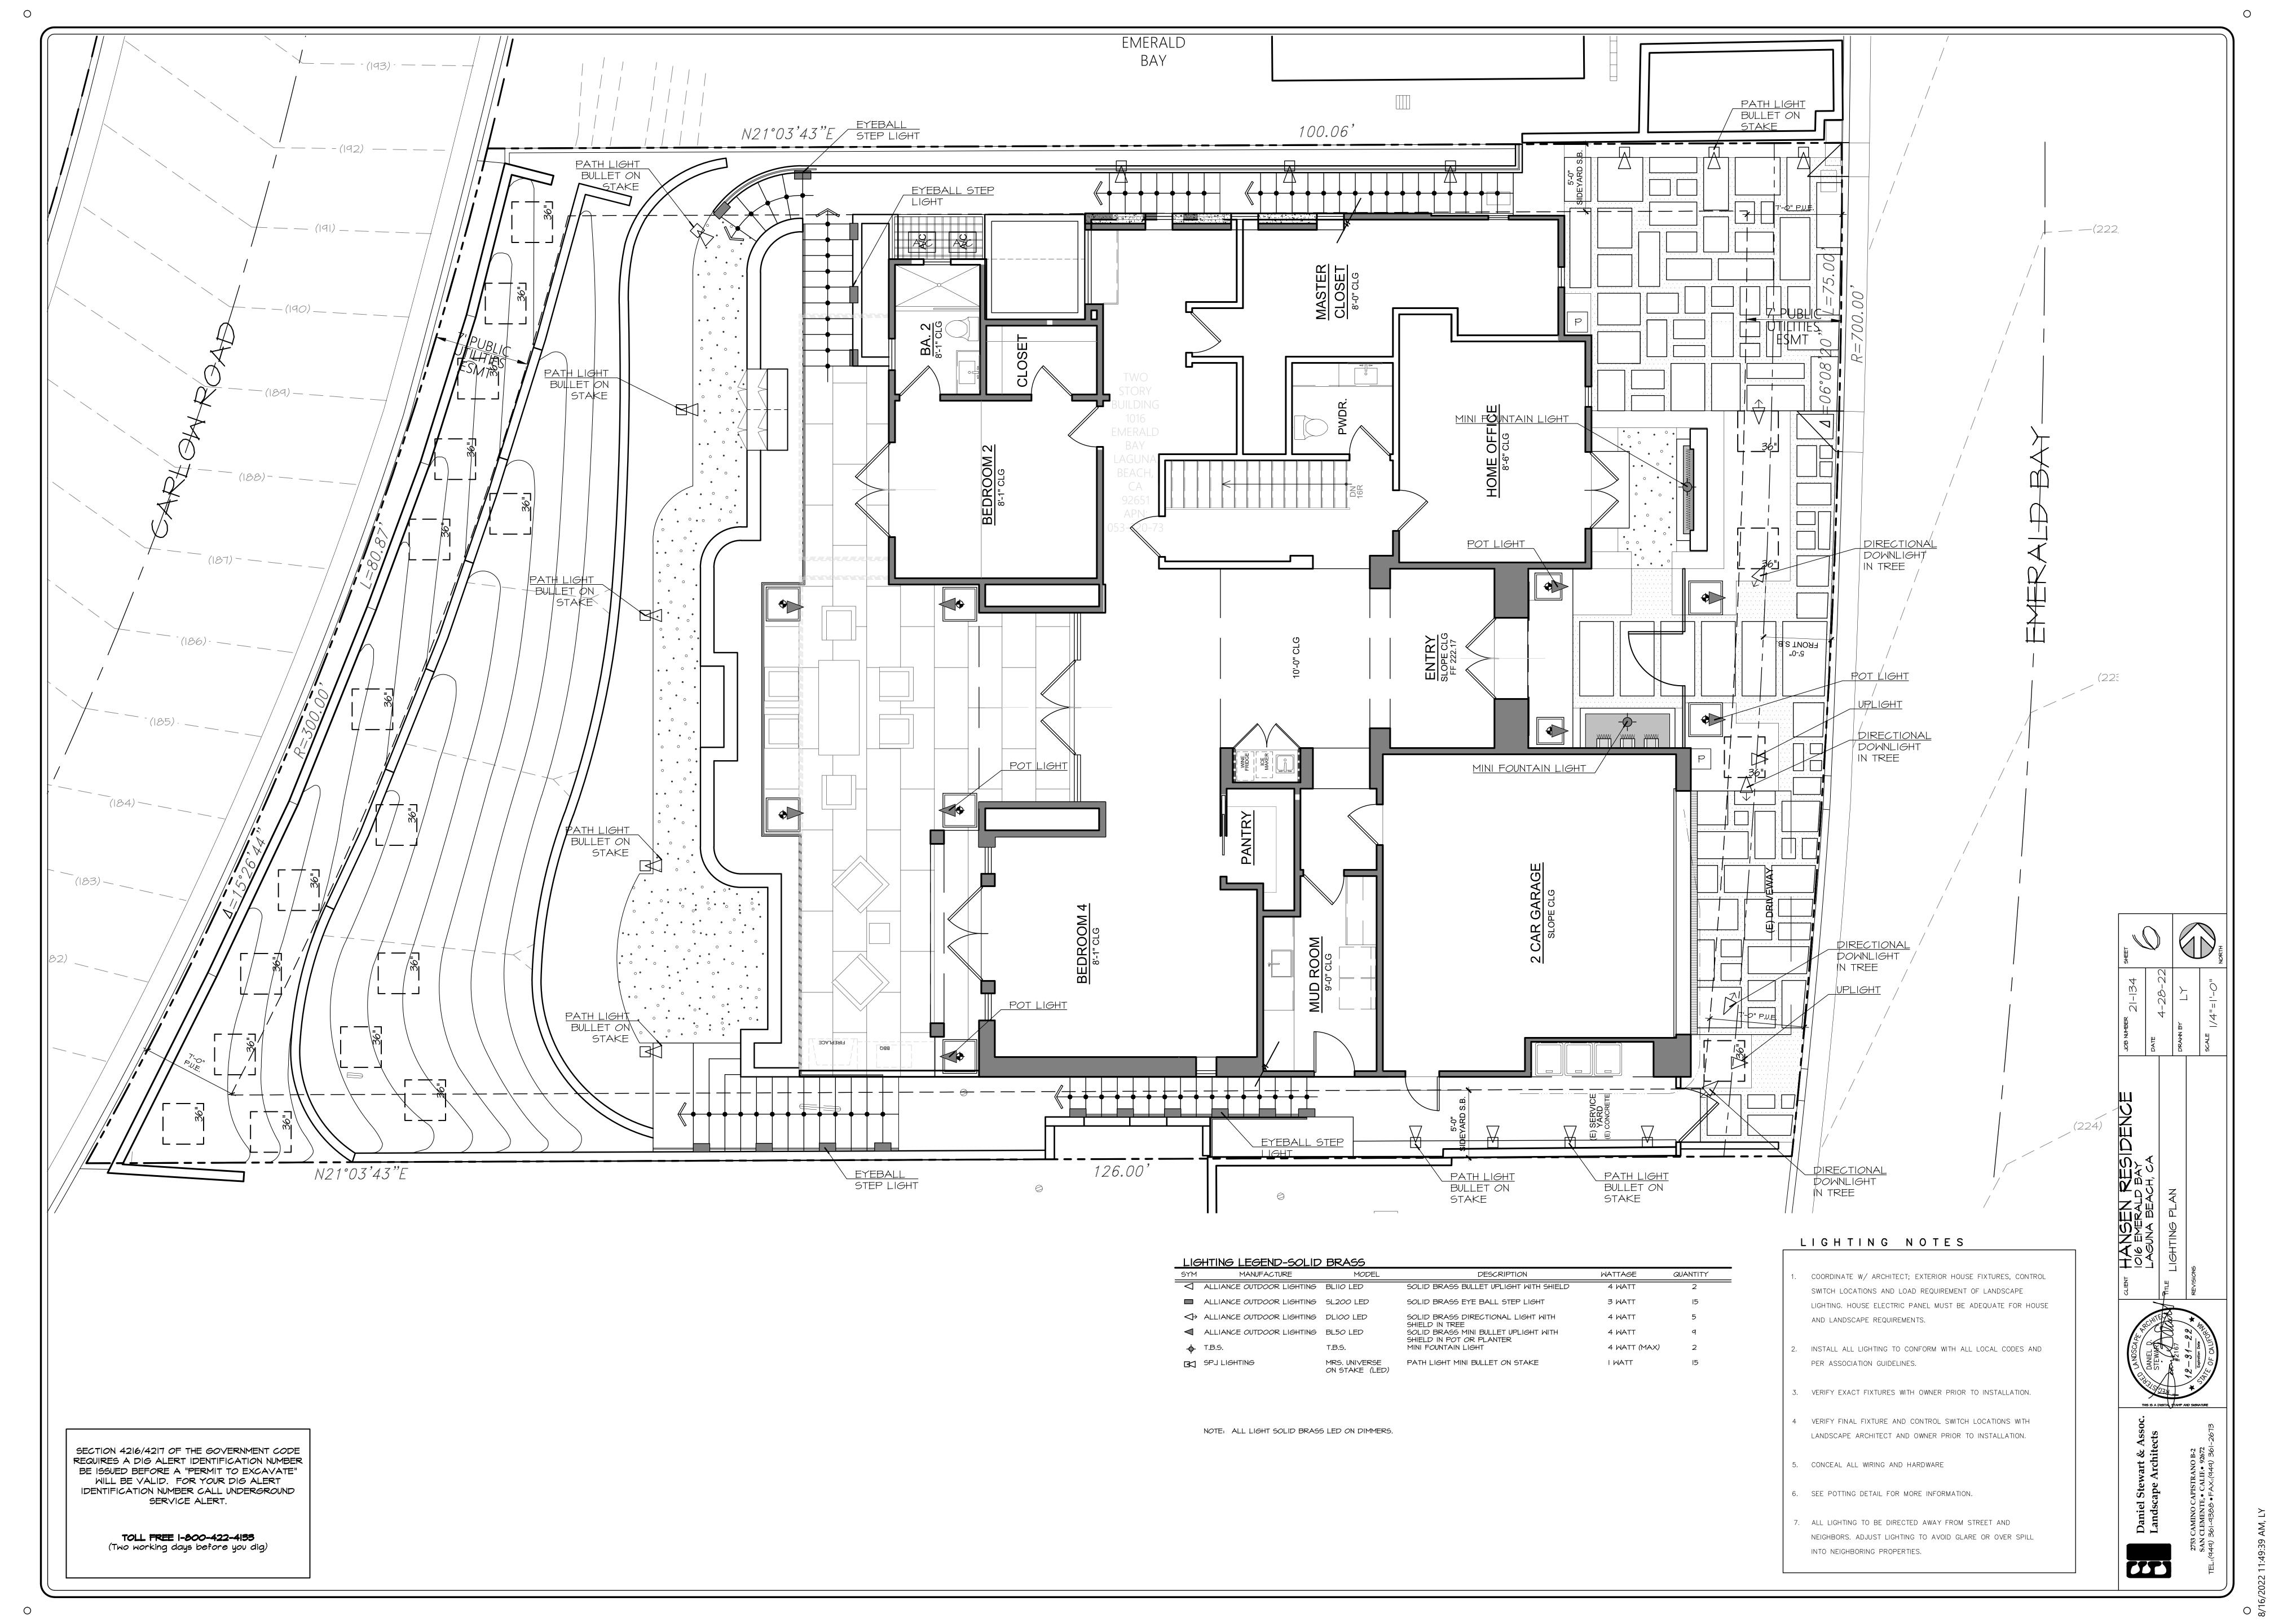
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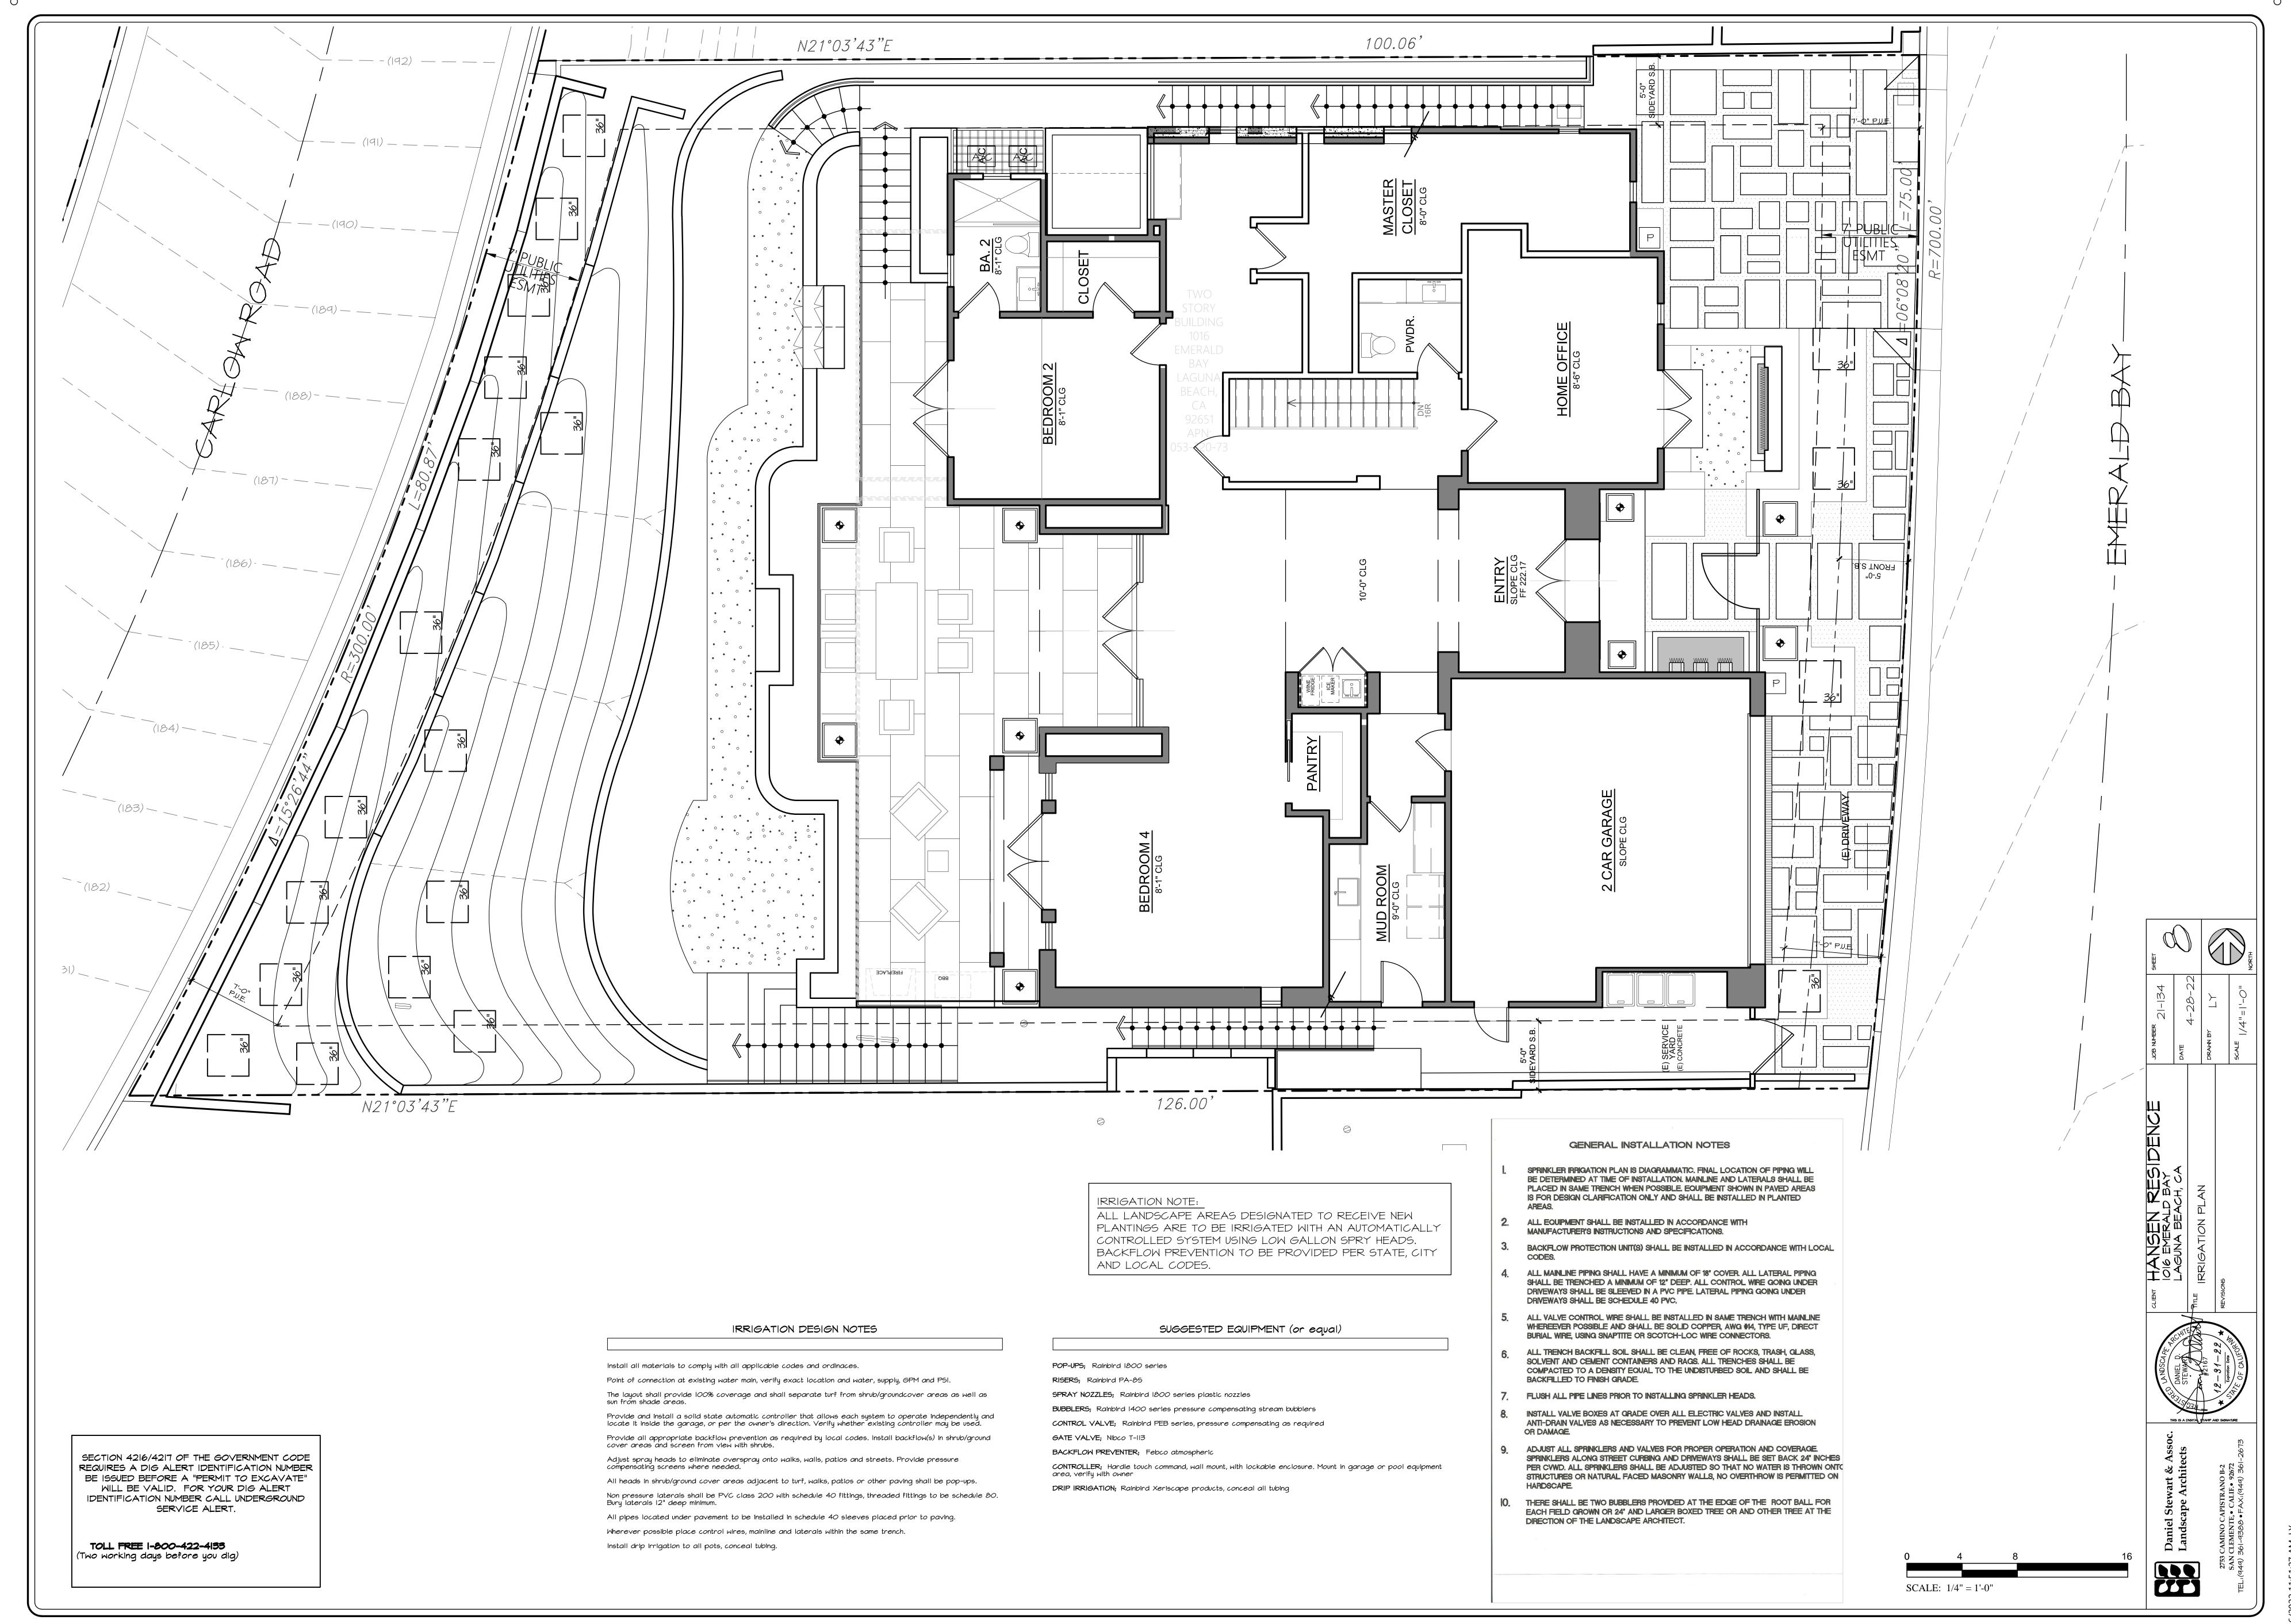
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WILL BE VALID. FOR YOUR DIG ALERT IDENTIFICATION NUMBER CALL UNDERGROUND SERVICE ALERT.

TOLL FREE 1-800-422-4133
(Two working days before you dig)








CITY OF LAGUNA BEACH, CALIFORNIA COUNTY OF ORANGE


TOPOGRAPHIC MAP

1016 EMERALD BAY

APN: 053-320-73



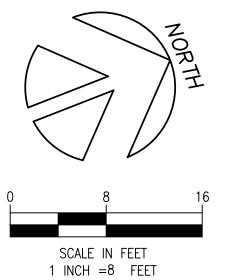

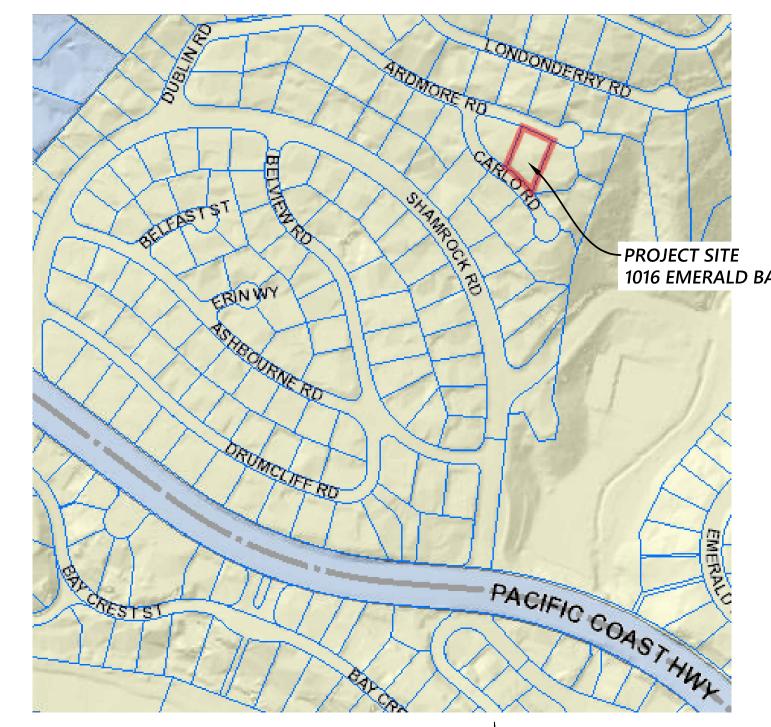




.EGEND)
BERM	BERM
BRICK	EDGE OF BRICK
CONC	EDGE OF CONCRETE
DECK	EDGE OF DECK ABOVE
EAVE	EAVE OF ROOF
EM	ELECTRICAL METER
FF	FINISHED FLOOR
FG	FINISHED GRADE
FS	FINISHED SURFACE
FL	FLOWLINE
GM	GAS METER
GFF	GARAGE FINISHED FLOOR
INV	INVERT
NG	NATURAL GRADE
RIDGE	RIDGE OF ROOF
RW	ROCK WALL
STEP	EDGE OF STEP
SMH	SEWER MANHOLE
THRESH	EDGE OF THRESHOLD
TILE	EDGE OF TILE
TOP	TOP OF SLOPE
TOE	TOE OF SLOPE
TC	TOP OF CURB
TW	TOP OF WALL
WM	WATER METER

WATER VALVE

HARDSCAPE **BUILDING WALL** _____ - _ ___ LOT LINE BOUNDARY LINE — — RIGHT-OF-WAY

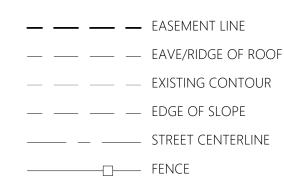

— — EDGE OF BUILDING ABOVE

SITE DATA:

SITE ADDRESS: 1016 EMERALD BAY, LAGUNA BEACH ZONING: R1(CD)(SR)

BENCHMARK

BENCHMARK: E-783

DESCRIBED BY OCS 2003 - FOUND 3 3/4" USCGS BRONZED DISK STAMPED "E 783 1946", SET IN THE TOP OF A CONCRETE POST. MONUMENT IS LOCATED ALONG THE SOUTHWESTERLY SIDE OF PACIFIC COAST HIGHWAY, 36 FT. SOUTHERLY OF THE SOUTHBOUND LANES ALONG PCH, IN THE WESTERLY CORNER OF THE JUNCTION OF PCH AND THE ENTRANCE TO EMERALD BAY HOMES NUMBERED (105-113), 1.3 FT. NORTHERLY OF THE NORTHERLY MOST 1 OF 2 STONE GATE POSTS AND 1.7 MILES NORTHWESTERLY ALONG PCH FROM THE CENTERLINE OF BROADWAY. MONUMENT IS SET 0.1 FT. BELOW THE

NAVD29 ELEV = 97.396 FEET (LEVELED 2004)

LEGAL DESCRIPTION

LOT 62 OF TRACT 3125, BOOK 98, PAGES 8-10, M.M. APN: 053-320-73

SURVEY NOTES

- 1. THIS MAP IS FOR PRELIMINARY PURPOSES ONLY. THIS MAP IS NOT A BOUNDARY SURVEY. BOUNDARY LINES AND PROPERTY LINES SHALL NOT BE RELIED UPON FOR CONSTRUCTION, ENCROACHMENTS, OR SETBACKS.
- 2. NO SEARCH OF THE PUBLIC RECORDS HAS BEEN MADE BY THIS
- 3. PRELIMINARY TITLE REPORT IS NOT AVAILABLE AT THIS TIME. THERE MAY BE EASEMENTS PRESENT ON THE SUBJECT PROPERTY.


NO. REVISION DATE

10/5/2021

SHEET NO.

TOPO

SHEET NO. 1 OF 1

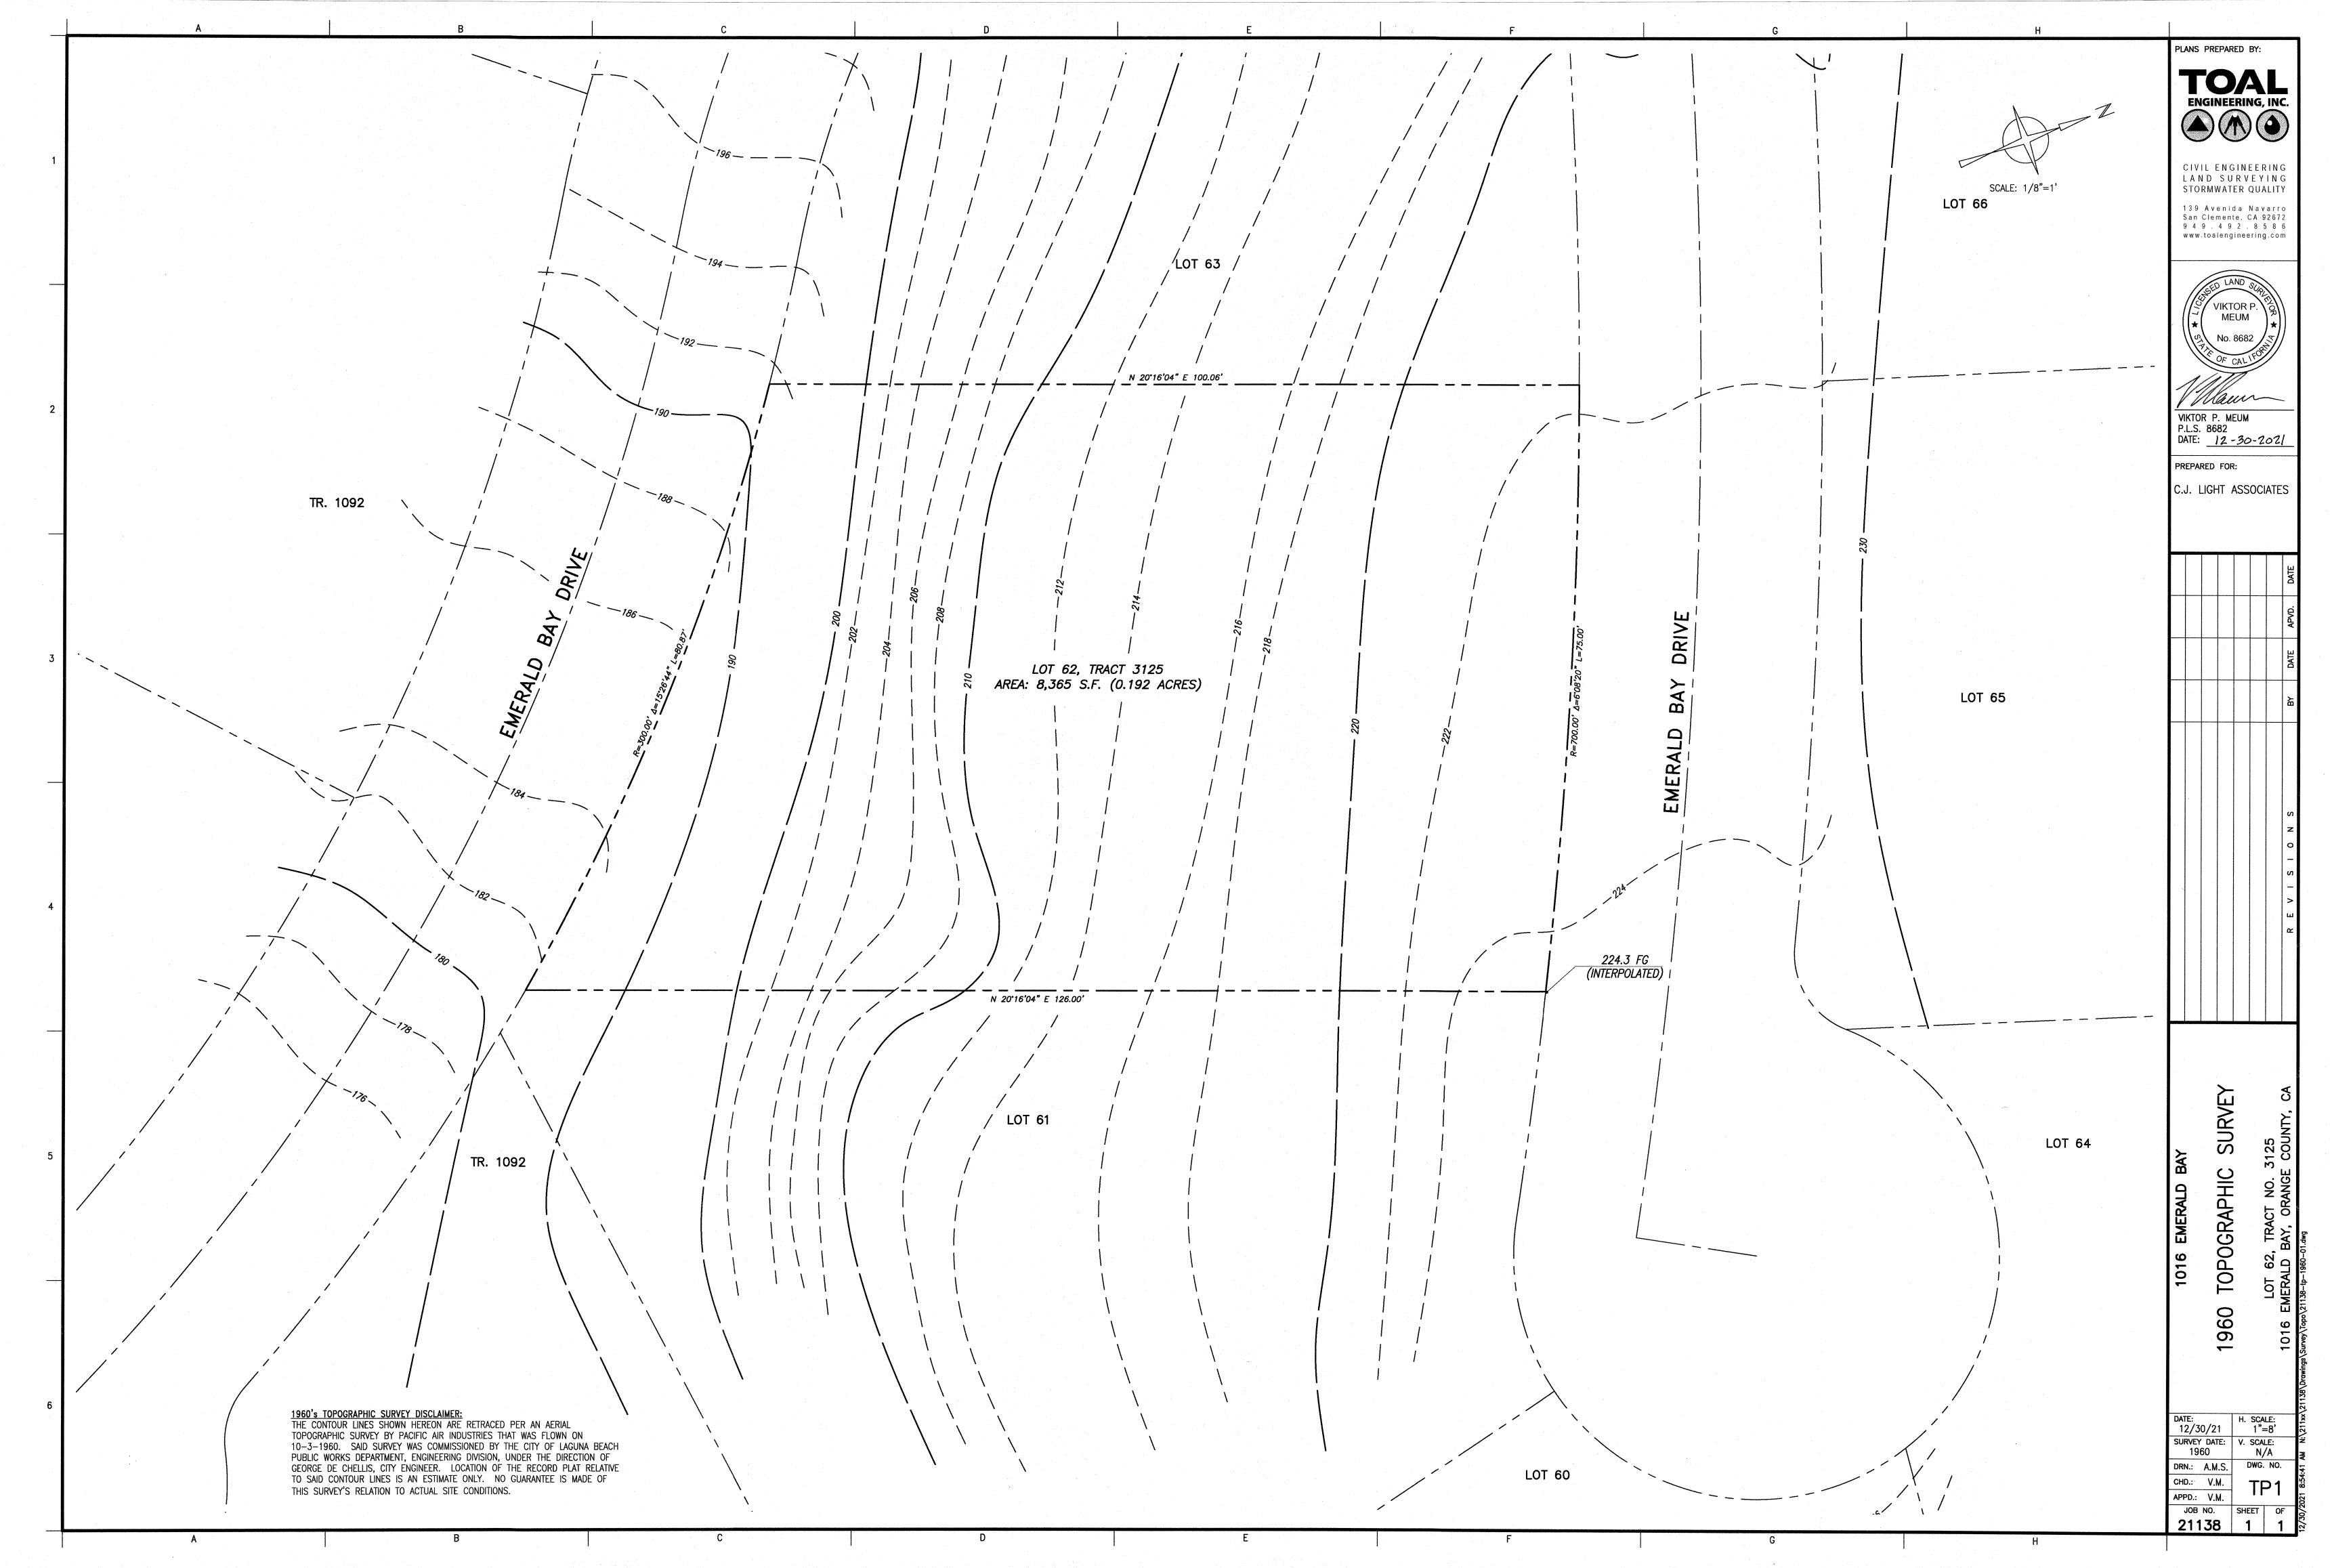

CITY OF LAGUNA BEACH GRADING PLAN

CUSTOM RESIDENCE

1016 EMERALD BAY LAGUNA BEACH, CA 92651

NPDES NOTES

- 1. IN THE CASE OF EMERGENCY, CALL: WILL ROLPH AT WORK PHONE # 949.464.8115
- 2. SEDIMENT FROM AREAS DISTURBED BY CONSTRUCTION SHALL BE RETAINED ON SITE USING STRUCTURAL CONTROLS TO THE MAXIMUM EXTENT PRACTICABLE.
- 3. STOCKPILES OF SOIL SHALL BE PROPERLY CONTAINED TO MINIMIZE SEDIMENT TRANSPORT FROM THE SITE TO STREETS, DRAINAGE FACILITIES OR ADJACENT PROPERTIES VIA RUNOFF, VEHICLE TACKING, OR WIND.
- 4. APPROPRIATE BMP'S FOR CONSTRUCTION-RELATED MATERIALS, WASTES, SPILLS SHALL BE IMPLEMENTED TO MINIMIZE TRANSPORT FROM THE SITE TO STREETS, DRAINAGE FACILITIES, OR ADJOINING PROPERTIES
- 5. RUNOFF FROM EQUIPMENT AND VEHICLE WASHING SHALL BE CONTAINED AT CONSTRUCTION SITES UNLESS TREATED TO REDUCE OR REMOVE SEDIMENT AND OTHER POLLUTANTS.
- 6. ALL CONSTRUCTION CONTRACTOR AND SUBCONTRACTOR PERSONNEL ARE TO BE MADE AWARE OR THE REQUIRED BEST MANAGEMENT PRACTICES AND GOOD HOUSEKEEPING MEASURES FOR THE PROJECT SITE AND ANY ASSOCIATED CONSTRUCTION STAGING AREAS.
- 7. AT THE END OF EACH DAY OF CONSTRUCTION ACTIVITY ALL CONSTRUCTION DEBRIS AND WASTE MATERIALS SHALL BE COLLECTED AND PROPERLY DISPOSED IN TRASH OR RECYCLE BINS.
- 8. CONSTRUCTION SITES SHALL BE MAINTAINED IN SUCH A CONDITION THAT AN ANTICIPATED STORM DOES NOT CARRY WASTES OR POLLUTANTS OFF THE SITE. DISCHARGES OF MATERIAL OTHER THAN STORM WATER ONLY WHEN NECESSARY FOR PERFORMANCE AND COMPLETION OF CONSTRUCTION PRACTICES AND WHERE THEY DO NOT: CAUSE OR CONTRIBUTE TO A VIOLATION OF ANY WATER QUALITY STANDARD; CAUSE OR THREATEN TO CAUSE POLLUTION, CONTAMINATION, OR NUISANCE; OR CONTAIN A HAZARDOUS SUBSTANCE IN A QUANTITY REPORTABLE UNDER FEDERAL REGULATIONS 40 CFR PARTS 117
- 9. POTENTIAL POLLUTANTS INCLUDE BUT ARE NOT LIMITED TO: SOLID OR LIQUID CHEMICAL SPILLS; WASTES FROM PAINTS, STAINS, SEALANTS, GLUES, LIMES, PESTICIDES, HERBICIDES, WOOD PRESERVATIVES AND SOLVENTS; ASBESTOS FIBERS, PAINT FLAKES OR STUCCO FRAGMENTS; FUELS, OILS, LUBRICANTS, AND HYDRAULIC, RADIATOR OR BATTERY FLUIDS; FERTILIZERS, VEHICLE/EQUIPMENT WASH WATER AND CONCRETE WASH WATER; CONCRETE, DETERGENT OR FLOATABLE WASTES; WASTES FROM ANY ENGINE/EQUIPMENT STEAM CLEANING OR CHEMICAL DEGREASING AND SUPERCHLORINATED POTABLE WATER LINE FLUSHING.
 - COUNTY OF ORANGE | OC PUBLIC WORKS | OC PLANNING
- DURING CONSTRUCTION, PERMITTEE SHALL DISPOSE OF SUCH MATERIALS IN A SPECIFIED AND CONTROLLED TEMPORARY AREA ON-SITE, PHYSICALLY SEPARATED FROM POTENTIAL STORM WATER RUNOFF, WITH ULTIMATE DISPOSAL IN ACCORDANCE WITH LOCAL, STATE AND FEDERAL REQUIREMENTS.
- 10.DEWATERING OF CONTAMINATED GROUNDWATER OR DISCHARGING CONTAMINATED SOILS VIA SURFACE erosion is prohibited. Dewatering of Non-Contaminated groundwater requires a national POLLUTANT DISCHARGE ELIMINATION SYSTEM PERMIT FROM THE RESPECTIVE STATE REGIONAL WATER OUALITY CONTROL BOARD
- 11. GRADED AREAS ON THE PERMITTED AREA PERIMETER MUST DRAIN AWAY FROM THE FACE OF SLOPES AT THE CONCLUSION OF EACH WORKING DAY, DRAINAGE IS TO BE DIRECTED TOWARD DESILTING FACILITIES.
- 12. THE PERMITTEE AND CONTRACTOR SHALL BE RESPONSIBLE AND SHALL TAKE NECESSARY PRECAUTIONS ublic trespass onto areas where impounded water creates a hazardou! CONDITION.
- 13. THE PERMITTEE AND CONTRACTOR SHALL INSPECT THE EROSION CONTROL WORK AND INSURE THAT THE WORK IS IN ACCORDANCE WITH THE APPROVED PLANS.
- 14.THE PERMITTEE SHALL NOTIFY ALL GENERAL CONTRACTORS, SUBCONTRACTORS, MATERIAL SUPPLIERS. LESSEES, AND PROPERTY OWNERS: THAT DUMPING OF CHEMICALS INTO THE STORM DRAIN SYSTEM OR THE WATERSHED IS PROHIBITED.
- 15.EQUIPMENT AND WORKERS FOR EMERGENCY WORK SHALL BE MADE AVAILABLE AT ALL TIMES DURING THE RAINY SEASON. NECESSARY MATERIALS SHALL BE AVAILABLE ON SITE AND STOCKPILED AT CONVENIENT LOCATIONS TO FACILITATE RAPID CONSTRUCTION OF TEMPORARY DEVICES WHEN RAIN IS
- 16.ALL REMOVABLE EROSION PROTECTIVE DEVICES SHALL BE IN PLACE AT THE END OF EACH WORKING DAY WHEN THE 5-DAY RAIN PROBABILITY FORECAST EXCEEDS 40%.
- 17. SEDIMENTS FROM AREAS DISTURBED BY CONSTRUCTION SHALL BE RETAINED ON SITE USING AN EFFECTIVE COMBINATION OF EROSION AND SEDIMENT CONTROLS TO THE MAXIMUM EXTENT PRACTICABLE, AND STOCKPILES OF SOIL SHALL BE PROPERLY CONTAINED TO MINIMIZE SEDIMENT TRANSPORT FROM THE SITE TO STREETS, DRAINAGE FACILITIES OR ADJACENT PROPERTIES VIA RUNOFF, VEHICLE TRACKING, OR WIND.
- 18. APPROPRIATE BMPS FOR CONSTRUCTION-RELATED MATERIALS, WASTES, SPILLS OR RESIDUES SHALL BE IMPLEMENTED AND RETAINED ON SITE TO MINIMIZE TRANSPORT FROM THE SITE TO STREETS, DRAINAGE FACILITIES, OR ADJOINING PROPERTY BY WIND OR RUNOFF.

GRADING NOTES

- 1. ALL WORK SHALL BE IN ACCORDANCE WITH THE GRADING CODE OF THE CITY OF LAGUNA BEACH, AND ANY SPECIAL REQUIREMENTS OF THE PERMIT.
- 2. GRADING SHALL NOT BE STARTED WITHOUT FIRST NOTIFYING THE DISTRICT GRADING INSPECTOR. A PRE-GRADING MEETING ON THE SITE IS REQUIRED BEFORE START OF GRADING WITH THE FOLLOWING PEOPLE
- OWNER GRADING CONTRACTOR

PRESENT:

- DESIGN CIVIL ENGINEER
- ENGINEERING GEOLOGIST DISTRICT GRADING INSPECTOR
- WHEN REQUIRED ARCHAEOLOGIST AND PALEONTOLOGIST
- THE REQUIRED INSPECTIONS FOR GRADING WILL BE EXPLAINED AT THE MEETING.
- 3. ISSUANCE OF A GRADING PERMIT DOES NOT ELIMINATE THE NEED FOR PERMITS FROM OTHER AGENCIES WITH REGULATORY RESPONSIBILITIES FOR CONSTRUCTION ACTIVITIES ASSOCIATED WITH THE WORK AUTHORIZED ON THIS PLAN.

GRADING NOTES (CONTINUED)

- 4. THE GRADING PERMIT AND AN APPROVED COPY OF THE GRADING PLAN SHALL BE ON THE PERMITTED SITE
- 5. PRELIMINARY SOIL AND GEOLOGY REPORTS, AND ALL SUBSEQUENT REPORTS AS APPROVED BY OC PLANNING, GRADING SECTION, ARE CONSIDERED A PART OF THE APPROVED GRADING PLAN.
- 6. THE SOIL ENGINEER AND ENGINEERING GEOLOGIST SHALL PERFORM SUFFICIENT INSPECTIONS AND BE AVAILABLE DURING GRADING AND CONSTRUCTION TO VERIFY COMPLIANCE WITH THE PLANS, SPECIFICATIONS AND THE CODE WITHIN THEIR PURVIEW.
- 7. THE CIVIL ENGINEER SHALL BE AVAILABLE DURING GRADING TO VERIFY COMPLIANCE WITH THE PLANS, SPECIFICATIONS AND THE CODE WITHIN THEIR PURVIEW.
- 8. THE SOIL ENGINEER AND ENGINEERING GEOLOGIST SHALL, AFTER CLEARING AND PRIOR TO PLACEMENT OF FILL IN CANYONS, INSPECT EACH CANYON FOR AREAS OF ADVERSE STABILITY, AND TO DETERMINE THE PRESENCE OR ABSENCE OF SUBSURFACE WATER OR SPRING FLOW.
- 9. SUBDRAIN OUTLETS SHALL BE COMPLETE AT THE BEGINNING OF THE SUBDRAIN CONSTRUCTION.
- 10.THE EXACT LOCATION OF THE SUBDRAINS SHALL BE SURVEYED IN THE FIELD FOR LINE/GRADE AD SHOWN ON AS-GRADED PLANS.
- 11. AREAS TO RECEIVE FILL SHALL BE PROPERLY PREPARED AND APPROVED IN WRITING BY THE SOIL ENGINEER AND THE BUILDING OFFICIAL PRIOR TO PLACING FILL
- 12.FILLS SHALL BE BENCHED INTO COMPETENT MATERIAL PER OC PUBLIC WORKS STANDARD PLAN # 1322. 13.ALL EXISTING FILLS SHALL BE APPROVED BY THE BUILDING OFFICIAL OR REMOVED PRIOR TO PLACING

ADDITIONAL FILLS.

- 14.FILLS SHALL BE COMPACTED THROUGHOUT TO A MINIMUM OF 90% RELATIVE COMPACTION. AGGREGATE BASE FOR ASPHALTIC AREAS SHALL BE COMPACTED TO MINIMUM OF 95% RELATIVE COMPACTION. MAXIMUM DENSITY SHALL BE DETERMINED BY UNIFORM BUILDING CODE STANDARD GO 70-1 OR APPROVED EQUIVALENT AND FIELD DENSITY BY UNIFORM BUILDING CODE # 70-2 OR APPROVED
- 15.CUT AND FILL SLOPES SHALL BE NO STEEPER THAN 2-FEET HORIZONTAL TO 1-FOOL VERTICAL (2:1) EXCEPT WHERE SPECIFICALLY APPROVED OTHERWISE
- 16.ALL CUT SLOPES SHALL BE INVESTIGATED BOTH DURING AND AFTER GRADING BY THE ENGINEERING GEOLOGICAL HAZARDS OR POTENTIAL GEOLOGICAL HAZARDS, THE ENGINEERING GEOLOGIST SHALL SUBMIT RECOMMENDED TREATMENT TO THE BUILDING OFFICIAL FOR APPROVAL.
- 17. WHERE SUPPORT OR BUTTRESSING OF CUT AND NATURAL SLOPES IS DETERMINED NECESSARY BY THE ENGINEERING GEOLOGIST AND SOIL ENGINEER, THE SOIL ENGINEER SHALL SUBMIT DESIGN, LOCATIONS AND CALCULATIONS TO THE BUILDING OFFICIAL PRIOR TO CONSTRUCTION. THE ENGINEERING GEOLOGIST AND SOIL ENGINEER SHALL INSPECT AND CONTROL THE CONSTRUCTION OF THE BUTTRESSING AND CERTIFY TO THE STABILITY OF THE SLOPE AND ADJACENT STRUCTURES UPON COMPLETION.
- 18. WHEN CUT PADS ARE BROUGHT TO NEAR GRADE, THE ENGINEERING GEOLOGIST SHALL DETERMINE IF THE BEDROCK IS EXTENSIVELY FRACTURED OR FAULTED, AND WILL READILY TRANSMIT WATER. IF CONSIDERED NECESSARY BY THE ENGINEERING GEOLOGIST AND SOIL ENGINEER, A COMPACTED FILL BLANKET WILL BE
- 19.ALL TRENCH BACKFILL SHALL BE TESTED AND APPROVED BY THE SOIL ENGINEER PRE THE GRADING CODE.
- 20. ANY EXISTING IRRIGATION LINES AND CISTERNS SHALL BE REMOVED OR CRUSHED IN PLACE AND BY THE BUILDING OFFICIAL AND SOIL ENGINEER.
- 21.ANY EXISTING WATER WELLS SHALL BE ABANDONED AND COMPLIANCE WITH SPECIFICATION APPROVED BY ORANGE COUNTY HEALTH CARE AGENCY AND DIVISION OF ENVIRONMENTAL HEALTH.
- 22. ANY EXISTING CESSPOOLS OF SEPTIC TANKS SHALL BE ABANDONED IN COMPLIANCE WITH THE UNIFORM PLUMBING CODE TO THE APPROVAL OF OC PLANNING / BUILDING INSPECTIONS.
- 23. STOCKPILING OF EXCESS MATERIAL SHALL BE APPROVED BY THE BUILDING OFFICIAL PRIOR TO EXCAVATION. 24. EXPORT SOIL MUST BE TRANSPORTED TO A LEGAL DUMP OR TO A PERMITTED SITE APPROVED BY THE
- DISTRICT BUILDING INSPECTOR 25. THE PERMITTEE SHALL COMPLY WITH THE GRADING CODE REQUIREMENTS FOR HAUL ROUTES WHEN AN EXCESS OF 5,000 CUBIC YARDS OF EARTH IS TRANSPORTED TO OR FROM A PERMITTED SITE ON A PUBLIC
- 26. THE PERMITTEE IS RESPONSIBLE FOR DUST CONTROL MEASURES.
- 27. THE PERMITTEE SHALL GIVE REASONABLE NOTICE TO THE OWNER OF ADJOINING LANDS AND BUILDING PRIOR TO BEGINNING EXCAVATIONS WHICH MAY AFFECT THE LATERAL AND SUBJACENT SUPPORT OF THE ADJOINING PROPERTY. THE NOTICE SHALL STATE THE INTENDED DEPTH OF EXCAVATION AND WHEN THE excavation will commence. The adjoining owner shall be allowed at least 30 days and REASONABLE ACCESS ON THE PERMITTED PROPERTY TO PROTECT HIS STRUCTURE, IF HE SO DESIRES, UNLESS OTHER WISE PROTECTED BY LAW.
- 28. ALL CONCRETE STRUCTURES THAT COME IN CONTACT WITH THE ON-SITE SOILS SHALL BE CONSTRUCTED WITH TYPE V CEMENT, UNLESS DEEMED UNNECESSARY BY SOLUBLE SULFATE-CONTENT TESTS CONDUCTED BY THE SOIL ENGINEER.
- 29. SLOPES EXCEEDING 5 FEET IN HEIGHT SHALL BE PLANTED WITH AN APPROVED PLANT MATERIAL. IN ADDITION, SLOPES EXCEEDING 15 FEET IN HEIGHT SHALL BE PROVIDED WITH AN APPROVED IRRIGATION SYSTEM, UNLESS OTHERWISE APPROVED BY THE BUILDING OFFICIAL.
- 30. ALL EXISTING DRAINAGE COURSES THROUGH THIS SITE SHALL REMAIN OPEN UNTIL FACILITIES TO HANDLE STORM WATER ARE APPROVED AND FUNCTIONAL, HOWEVER, IN ANY CASE, THE PERMITTEE SHALL BE HELD LIABLE FOR ANY DAMAGE DUE TO OBSTRUCTING NATURAL DRAINAGE PATTERNS.
- 31. SANITARY FACILITIES SHALL BE MAINTAINED ON SITE.
- 32. THE LOCATION AND PROTECTION OF ALL UTILITIES IS THE RESPONSIBILITY OF THE PERMITTEE.
- 33. APPROVED PROTECTIVE MEASURES AND TEMPORARY DRAINAGE PROVISIONS SHALL BE USED TO PROTECT ADJOINING PROPERTIES DURING GRADING.
- 34. GRADING OPERATIONS INCLUDING MAINTENANCE OF FOUIPMENT WITHIN ONE-MILE OF A HUMAN OCCUPANCY SHALL NOT BE CONDUCTED BETWEEN THE HOURS OF 8:00 PM AND 7:00 AM DAILY, ON SUNDAY OR ON A FEDERAL HOLIDAY

GRADING NOTES (CONTINUED)


- a. ALL CONSTRUCTION VEHICLES OR EQUIPMENT, FIXED OR MOBILE, OPERATED WITHIN 1000 FEE OF A DWELLING SHALL BE EQUIPPED WITH PROPERLY OPERATION AND MAINTAINED MUFFLERS.
- b. ALL OPERATIONS SHALL COMPLY WITH ORANGE COUNTY CODIFIED ORDINANCE DIVISION 6 (NOISE
- c. STOCKPILING AND/OR VEHICLE STAGING AREAS SHALL BE LOCATED AS FAR AS PRACTICAL FROM DWELLINGS AND WITHIN THE LIMITS OF THE GRADING PERMIT
- 35. GRADING AND EXCAVATION SHALL BE HALTED DURING PERIODS OF HIGH WINDS. ACCORDING TO AQMD MEASURE F-4, HIGH WINDS ARE DEFINED AS 30 MPH OR GREATER. THIS LEVEL OCCURS ONLY UNDER EXTREME CONDITION SUCH AS SANTA ANA WIND CONDITIONS.
- 36. ASPHALT SECTIONS MUST BE PER CODE: PARKING STALL 3" A/C OVER 6" A/B, DRIVES 3" A/C OVER 10" (COMMERCIAL) 12" (INDUSTRIAL). OR: PRIOR TO ROUGH GRADE RELEASE FOR BUILDING PERMITS BY THE DISTRICT GRADING INSPECTOR, THE SOIL ENGINEER SHALL SUBMIT FOR APPROVAL PAVEMENT SECTION RECOMMENDATIONS BASE ON "R" VALUE ANALYSIS OF THE SUB-GRADE SOILS, AND EXPECTED TRAFFIC
- 37. ASPHALT CONCRETE SHALL BE CONSTRUCTED PER THE REQUIREMENTS OF OC PUBLIC WORKS STANDARD
- 38. AGGREGATE BASE SECTION SHALL BE CONSTRUCTED PER OC PUBLIC WORKS STANDARD PLAN # 1804.
- 39. ROOF GUTTERS SHALL BE INSTALLED TO PREVENT ROOF DRAINAGE FROM FALLING ON MANUFACTURED
- 40. THE CIVIL ENGINEER, AS A CONDITION OF ROUGH GRADE APPROVAL, SHALL PROVIDE A BLUE TOP WITH ACCOMPANYING WITNESS STAKE, SET AT THE CENTER OF EACH PAD REFLECTING THE PAD ELEVATION FOR PRECISE PERMITS, AND BLUE TOP WITH WITNESS STAKE SET AT THE DRAINAGE SWALE HIGH-POINT REFLECTING THE HIGH POINT ELEVATION OF PRELIMINARY PERMITS.
- 41.PRIOR TO FINAL APPROVAL, THE CIVIL ENGINEER SHALL CERTIFY TO THE BUILDING OFFICIAL THE AMOUNT OF EARTH MOVED DURING THE GRADING OPERATION.
- 42. THE ENGINEERING GEOLOGIST SHALL PERFORM PERIODIC INSPECTIONS AND SUBMIT A COMPLETE REPORT AND MOP UPON COMPLETION OF THE ROUGH GRADING.
- 43. THE GRADING CONTRACTOR SHALL SUBMIT A STATEMENT OF COMPLIANCE TO THE APPROVED GRADING
- 44. THE COMPACTION REPORT AND APPROVAL FROM SOIL ENGINEER SHALL INDICATE THE TYPE OF FIELD TESTING PERFORMED THE METHOD OF OBTAINING THE IN-PLACE DENSITY SHALL BE IDENTIFIED WHETHER SAND CONE, DRIVE RING OR NUCLEAR, AND SHALL BE NOTED FOR EACH TEST. SUFFICIENT MAXIMUM DENSITY DETERMINATIONS SHALL BE PERFORMED TO VERIFY ACCURACY OF THE MAXIMUM DENSITY CURVES USED BY THE FIELD TECHNICIAN.
- 45. IN THE EVENT THAT SOIL CONTAMINATION IS DISCOVERED DURING EXCAVATION AND REMOVAL OF AN EXISTING TANK, WORK SHALL BE STOPPED UNTIL A SITE ASSESSMENT AND MITIGATION PLAN HAS BEEN PREPARED, SUBMITTED AND APPROVED BY THE ORANGE COUNTY HEALTH CARE AGENCY/ENVIRONMENTAL HEALTH AND OC PLANNING/GRADING.

EROSION CONTROL

- 46. IN THE CASE OF EMERGENCY, CALL: WILL ROLPH AT 949-464-8115
- 47. FOUIPMENT AND WORKERS FOR EMERGENCY WORK SHALL BE MADE AVAILABLE AT ALL TIMES DURING THE RAINY SEASON. NECESSARY MATERIALS SHALL BE AVAILABLE ON SITE AND STOCKPILED AT CONVENIENT LOCATIONS TO FACILITATE RAPID CONSTRUCTION OF TEMPORARY DEVICES WHEN RAIN IS IMMINENT.
- 48. EROSION CONTROL DEVICES SHALL NOT BE MOVED OR MODIFIED WITHOUT THE APPROVAL OF THE BUILDING OFFICIAL.
- 49. ALL REMOVABLE EROSION PROTECTIVE DEVICES SHALL BE IN PLACE AT THE END OF EACH WORKING DAY WHEN THE 5-DAY RAIN PROBABILITY FORECAST EXCEEDS 40%.
- 50. AFTER A RAINSTORM, ALL SILT AND DEBRIS SHALL BE REMOVED FROM STREETS, CHECK BERMS AND BASINS. 51. GRADED AREAS OF THE PERMITTED AREA PERIMETER MUST DRAIN AWAY FROM FACE SLOPES AT THE
- CONCLUSION OF EACH WORKING DAY. DRAINAGE IS TO BE DIRECTED TOWARDS DESILTING FACILITIES. 52. THE PERMITTEE AND CONTRACTOR SHALL BE RESPONSIBLE AND SHALL TAKE NECESSARY PRECAUTIONS TO
- PREVENT PUBLIC TRESPASS ONTO AREAS WHERE IMPOUNDED WATER CREATES A HAZARDOUS CONDITION.
- 53. THE PERMITTEE AND CONTRACTOR SHALL INSPECT THE EROSION CONTROL WORK AND INSURE THAT THE WORK IS IN ACCORDANCE WITH THE APPROVED PLAN

ENVIRONMENTAL NOTES

- 54. THE PERMITTEE SHALL NOTIFY ALL GENERAL CONTRACTORS, SUBCONTRACTORS, MATERIAL SUPPLIERS, LESSEES AND PROPERTY OWNERS THAT DUMPING OF CHEMICALS INTO THE STORM DRAIN SYSTEM OR WATERSHED IS PROHIBITED.
- 55. PERMITTEE SHALL MAINTAIN CONSTRUCTION SITE IN A CONDITION THAT ANTICIPATED STORM DOES NOT CARRY WASTES OR POLLUTANTS OFF THE SITE. POTENTIAL POLLUTANTS INCLUDE BUT ARE NOT LIMITED TO: SOLID OR LIQUID CHEMICAL SPILLS, WASTES FROM PAINT, STAINS, SEALANTS, GLUES, LIMES, PESTICIDES HERBICIDES, WOOD PRESERVATIVES AND SOLVENTS; ASBESTOS FIBERS, PAINT FLAKES OR STUCCO FRAGMENTS; FUELS, OILS, LUBRICANTS, AND HYDRAULIC, RADIATOR OR BATTERY FLUIDS; FERTILIZERS, VEHICLE/EQUIPMENT WASH WATER AND CONCRETE WASH WATER; CONCRETE, DETERGENT OR FLOATABLE WASTES; WASTES FROM ANY ENGINE/EQUIPMENT STEAM CLEANING OR CHEMICAL DEGREASING AND CHLORINATED POTABLE WATER LINE FLUSHING.
- DURING CONSTRUCTION, PERMITTEE SHALL DISPOSE OF SUCH MATERIALS IN A SPECIFIED AND CONTROLLED TEMPORARY AREA ON-SITE, PHYSICALLY SEPARATED FORM POTENTIAL STORM WATER RUNOFF, WITH ULTIMATE DISPOSE IN ACCORDANCE WITH LOCAL, STATE AND FEDERAL REQUIREMENTS.
- 56. PERMITTEE MAY DISCHARGE MATERIAL OTHER THAN STORM WATER ONLY WHEN NECESSARY FOR PERFORMANCE AND COMPLETION OF CONSTRUCTION PRACTICES AND WHERE THEY DO NOT: CAUSE OR CONTRIBUTE TO A VIOLATION OF ANY WATER QUALITY STANDARD; CAUSE OR THREATEN TO CAUSE POLLUTION, CONTAMINATION OR NUISANCE; OR CONTAIN A HAZARDOUS SUBSTANCE IN A QUANTITY REPORTABLE UNDER FEDERAL REGULATION 40 CFR, PARTS 117 AND 302.
- 57. DEWATERING OF CONTAMINATED GROUNDWATER OR DISCHARGING CONTAMINATED SOILS VIA SURFACE EROSION IS PROHIBITED. DEWATERING OF NON-CONTAMINATED GROUNDWATER REQUIRES A NATIONAL POLLUTANT DISCHARGE ELIMINATION SYSTEM PERMIT FROM THE RESPECTIVE STATE REGIONAL WATER

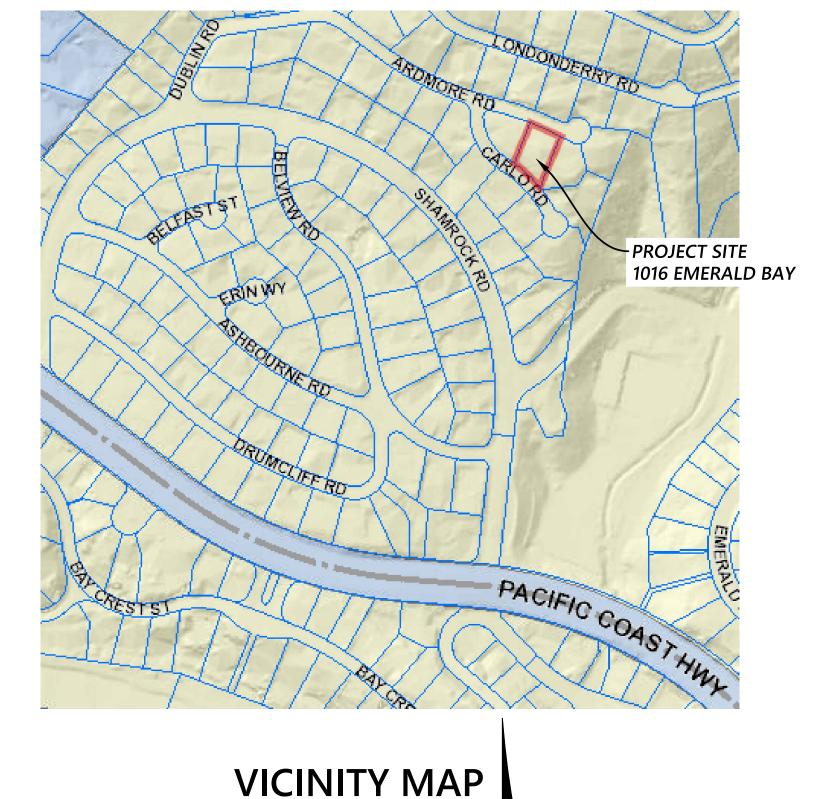

NOTES TO OWNER, CONTRACTOR, & ARCHITECT

- 1. CONSTRUCTION CONTRACTOR AGREES THAT IN ACCORDANCE WITH GENERALLY ACCEPTED. CONSTRUCTION PRACTICES, CONSTRUCTION CONTRACTOR WILL BE REQUIRED TO ASSUME SOLE AND COMPLETE RESPONSIBILITY FOR JOB SITE CONDITIONS DURING THE COURSE OF CONSTRUCTION OF THE PROJECT, INCLUDING SAFETY OF ALL PERSONS AND PROPERTY; THAT IS REQUIREMENT SHALL BE MADE TO APPLY CONTINUOUSLY AND NOT BE LIMITED TO NORMAL
- 2. ALL EXISTING TOPOGRAPHY AND PROPOSED GRADES SHALL BE FIELD VERIFIED.
- 3. NO UTILITY SEARCH WAS CONDUCTED. A UTILITY SEARCH BY THE CONTRACTOR SHALL BE CONDUCTED AND IT SHALL BE THE CONTRACTOR'S RESPONSIBILITY TO TAKE DUE PRECAUTIONARY MEASURES TO PROTECT THE UTILITIES OR STRUCTURES FOUND ON THE SITE AND TO NOTIFY THE OWNERS OF THE UTILITIES IMMEDIATELY UPON THEIR DISCOVERY.
- 4. EARTHWORK AND OTHER CONSTRUCTION ITEM QUANTITIES SHOWN ON THESE PLANS ARE ESTIMATES FOR PERMITTING PURPOSES ONLY AND SHALL NOT USED FOR CONSTRUCTION COST ESTIMATES OR FOR BIDDING PURPOSES. THE CONTRACTOR SHALL DEVELOP OWN QUANTITIES FOR
- 5. A SOILS INVESTIGATION MUST BE MADE BY A QUALIFIED SOILS ENGINEER AND/OR GEOLOGIST. SOIL AND EARTH ACCEPTABILITY ARE NOT UNDER PURVIEW OR THE RESPONSIBILITY OF THE DESIGN ENGINEER FOR THIS PLAN. CIVILSCAPES ENGINEERING DOES NOT TEST OR OBSERVE SOIL CONDITIONS PRIOR TO, DURING OR AFTER CONSTRUCTION AND HAS NO RESPONSIBILITY FOR SOILS (EARTH) STRUCTURES.
- 6. ALL STRUCTURAL DESIGNS ARE TO BE BUILT PER STRUCTURAL ENGINEER'S PLAN AND PER SEPARATE PLAN AND PERMIT.

SHEET INDEX

- C2 GRADING PLAN
- C3 STORM DRAIN PLAN C4 EROSION CONTROL PLAN

OWNER DOUG & JOAN HANSEN

1016 EMERALD BAY LAGUNA BEACH, CA 92651

ARCHITECT

C.J. LIGHT ASSOCIATES 1401 QUAIL STREET, SUITE 120 NEWPORT BEACH, CA 92660 949.851.8345

LEGAL DESCRIPTION

LOT 62 OF TRACT 3125, BOOK 98, PAGES 8-10, M.M.

APN: 053-320-73

CIVIL ENGINEER/ **SURVEYOR**

CIVILSCAPES ENGINEERING, INC CONTACT: WILL ROLPH 28052 CAMINO CAPISTRANO, STE 213 LAGUNA NIGUEL, CA 92677 949.464.8115 EMAIL: will@civilscapes.com

BENCHMARK

BENCHMARK: E-783

DESCRIBED BY OCS 2003 - FOUND 3 3/4" USCGS BRONZED DISK STAMPED "E 783 1946", SET IN THE TOP OF A CONCRETE POST. MONUMENT IS LOCATED ALONG THE SOUTHWESTERLY SIDE OF PACIFIC COAST HIGHWAY, 36 FT. SOUTHERLY OF THE SOUTHBOUND LANES ALONG PCH, IN THE WESTERLY CORNER OF THE JUNCTION OF PCH AND THE ENTRANCE TO EMERALD BAY HOMES NUMBERED (105-113), 1.3 FT. NORTHERLY OF THE NORTHERLY MOST 1 OF 2 STONE GATE POSTS AND 1.7 MILES NORTHWESTERLY ALONG PCH FROM THE CENTERLINE OF BROADWAY. MONUMENT IS SET 0.1 FT. BELOW THE HIGHWAY.

NAVD29 ELEV = 97.396 FEET (LEVELED 2004)

SPECIAL NOTE

SURVEY MONUMENTS SHALL BE PREPARED AND REFERENCED BEFORE CONSTRUCTION PURSUANT TO SECTION 8771 OF THE BUSINESS AND PROFESSIONAL CODE.

WATER SERVICE NOTE

PROVIDE SEPARATE WATER SERVICE WITH 3/4" PLUMBING LINE AND

UPGRADE TO 1" PLUMBING LINE IF FIRE SPRINKLERS ARE PROVIDED

EARTHWORK QUANTITIES

RAW CUT	76	CUBIC YARDS
RAW FILL	73	CUBIC YARDS
NET	3	CUBIC YARDS (EXPOR



SHEET NO. 1 OF 4

UNDERGROUND SERVICE ALER

LEGEND

CABLE PULLBOX CATV EDGE OF CONCRETE CONC TOP OF DECKING DECK EAVE OF ROOF EAVE

EDISON EDISON UTILITY BOX ELECTRIC METER FINISHED FLOOR FINISHED GRADE FLOWLINE

FINISHED SURFACE GRADEBREAK GARAGE FINISHED FLOOR GM **GAS METER**

INVERT NATURAL GRADE RIDGE OF ROOF RIDGE SCO SEWER CLEANOUT SEWER MANHOLE EDGE OF STEP STEP

TOP OF CURB TOP OF GRATE EDGE OF THRESHOLD TOP OF WALL WATER METER WM WATER VALVE

TILE SUPPORTED ON PEDESTAL SYSTEM OVER SLOPED CONCRETE BASE PER LS ARCH. PLAN PROPERTY LINE AND LIMIT-OF-WORK

PROPOSED WALL EXISTING WALL TO REMAIN


BUILDING STEMWALL EXISTING ELEVATION; CONTRACTOR SHALL FIELD VERIFY ELEVATIONS PRIOR TO CONSTRUCTION AND REPORT ANY DISCREPANCIES TO CIVILSCAPES ENGINEERING

SCALE IN FEET 1 INCH =8 FEET

CONSTRUCTION NOTES

- 1) HARDSCAPE PER ARCHITECT'S PLAN.
- 2) DRIVEWAY PER ARCHITECT'S PLAN.
- 3 PLANTER AREA PER ARCHITECT'S PLAN.
- (4) WALL OR FENCE PER ARCHITECT'S PLAN.
- (5) CONNECT DOWNSPOUT TO ONSITE STORM DRAIN SYSTEM PER DETAIL ON SHEET C3.
- IF EXISTING METER IS SUBSTANDARD, REMOVE AND REINSTALL 1-INCH. WATER METER. PROTECT SERVICE LINE FROM METER TO WATER MAIN. METER AND SERVICE SIZE SHALL BE CONFIRMED BY MEP CONSULTANT.
- (11) EXISTING GAS METER TO REMAIN; PROTECT IN PLACE.
- REMOVE AND REINSTALL ELECTRIC SERVICE AND METER PER ELECTRIC COMPANY'S STANDARDS AND SPECIFICATIONS.
- (13) CONSTRUCT FLOWLINE PER DETAIL HEREON.
- PERMEABLE FLAT DECKING SUPPORTED ON PEDESTAL SYSTEM OVER SLOPED CONCRETE SUBGRADE PER LANDSCAPE ARCHITECT'S PLANS.

PER PLAN

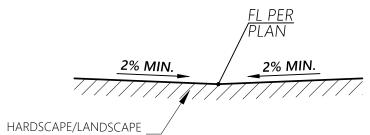

FLOWLINE DETAIL


28052 CAMINO CAPISTRAN LAGUNA NIGUEL, CA 92677 949.464.8115 info@civilscap


REVISIONS NO. REVISION DATE

21028

4/29/2022 SHEET NO.

SHEET NO. 2 OF 4

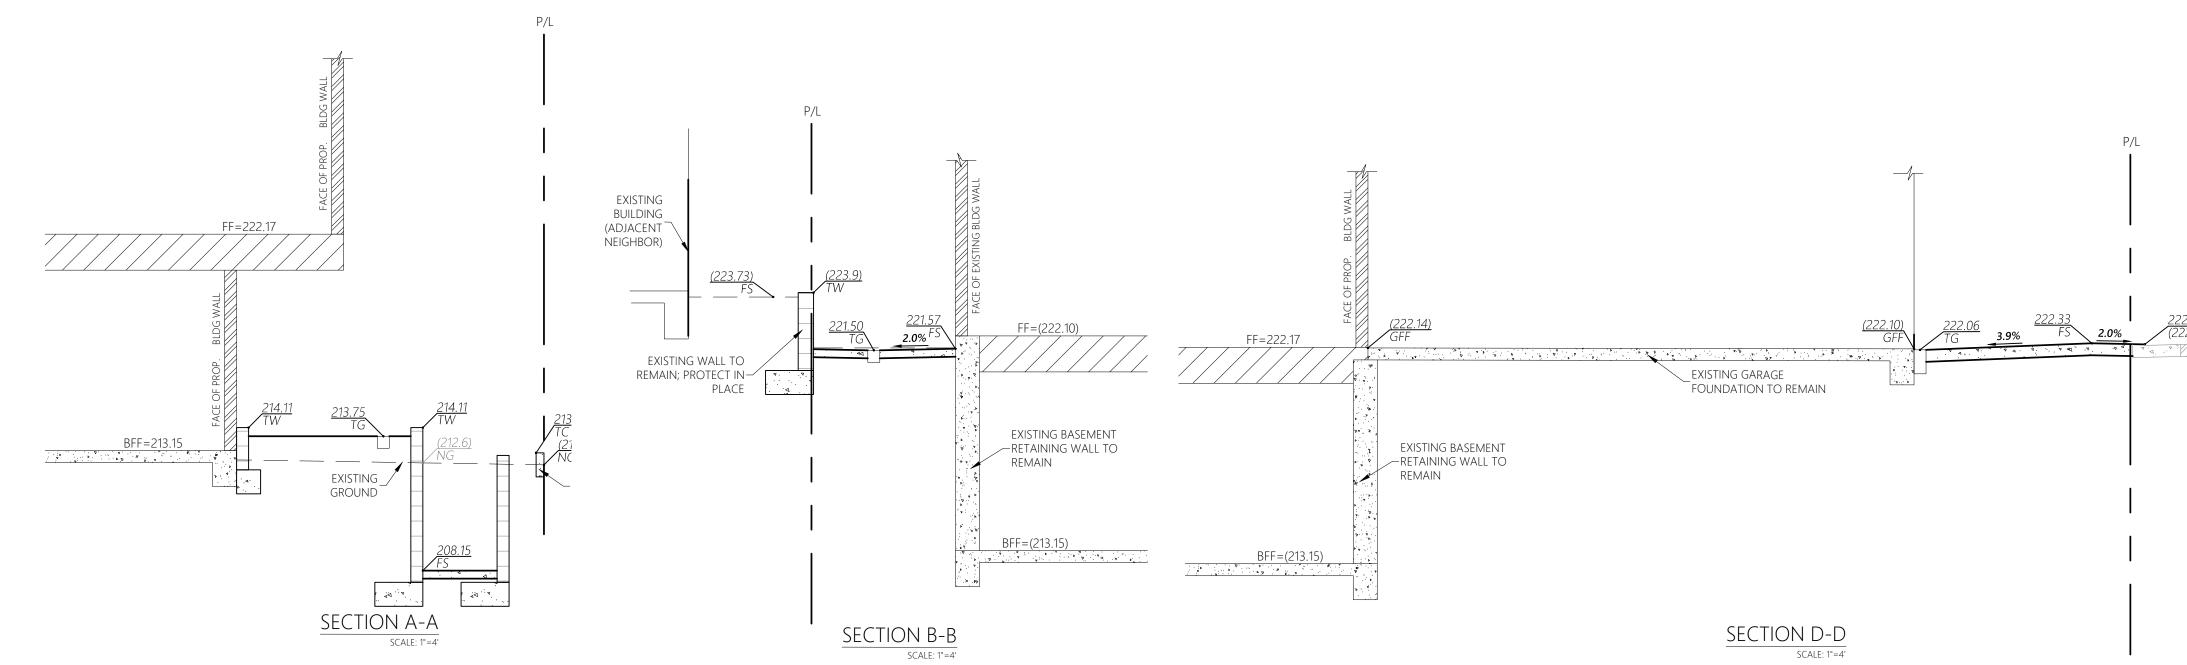

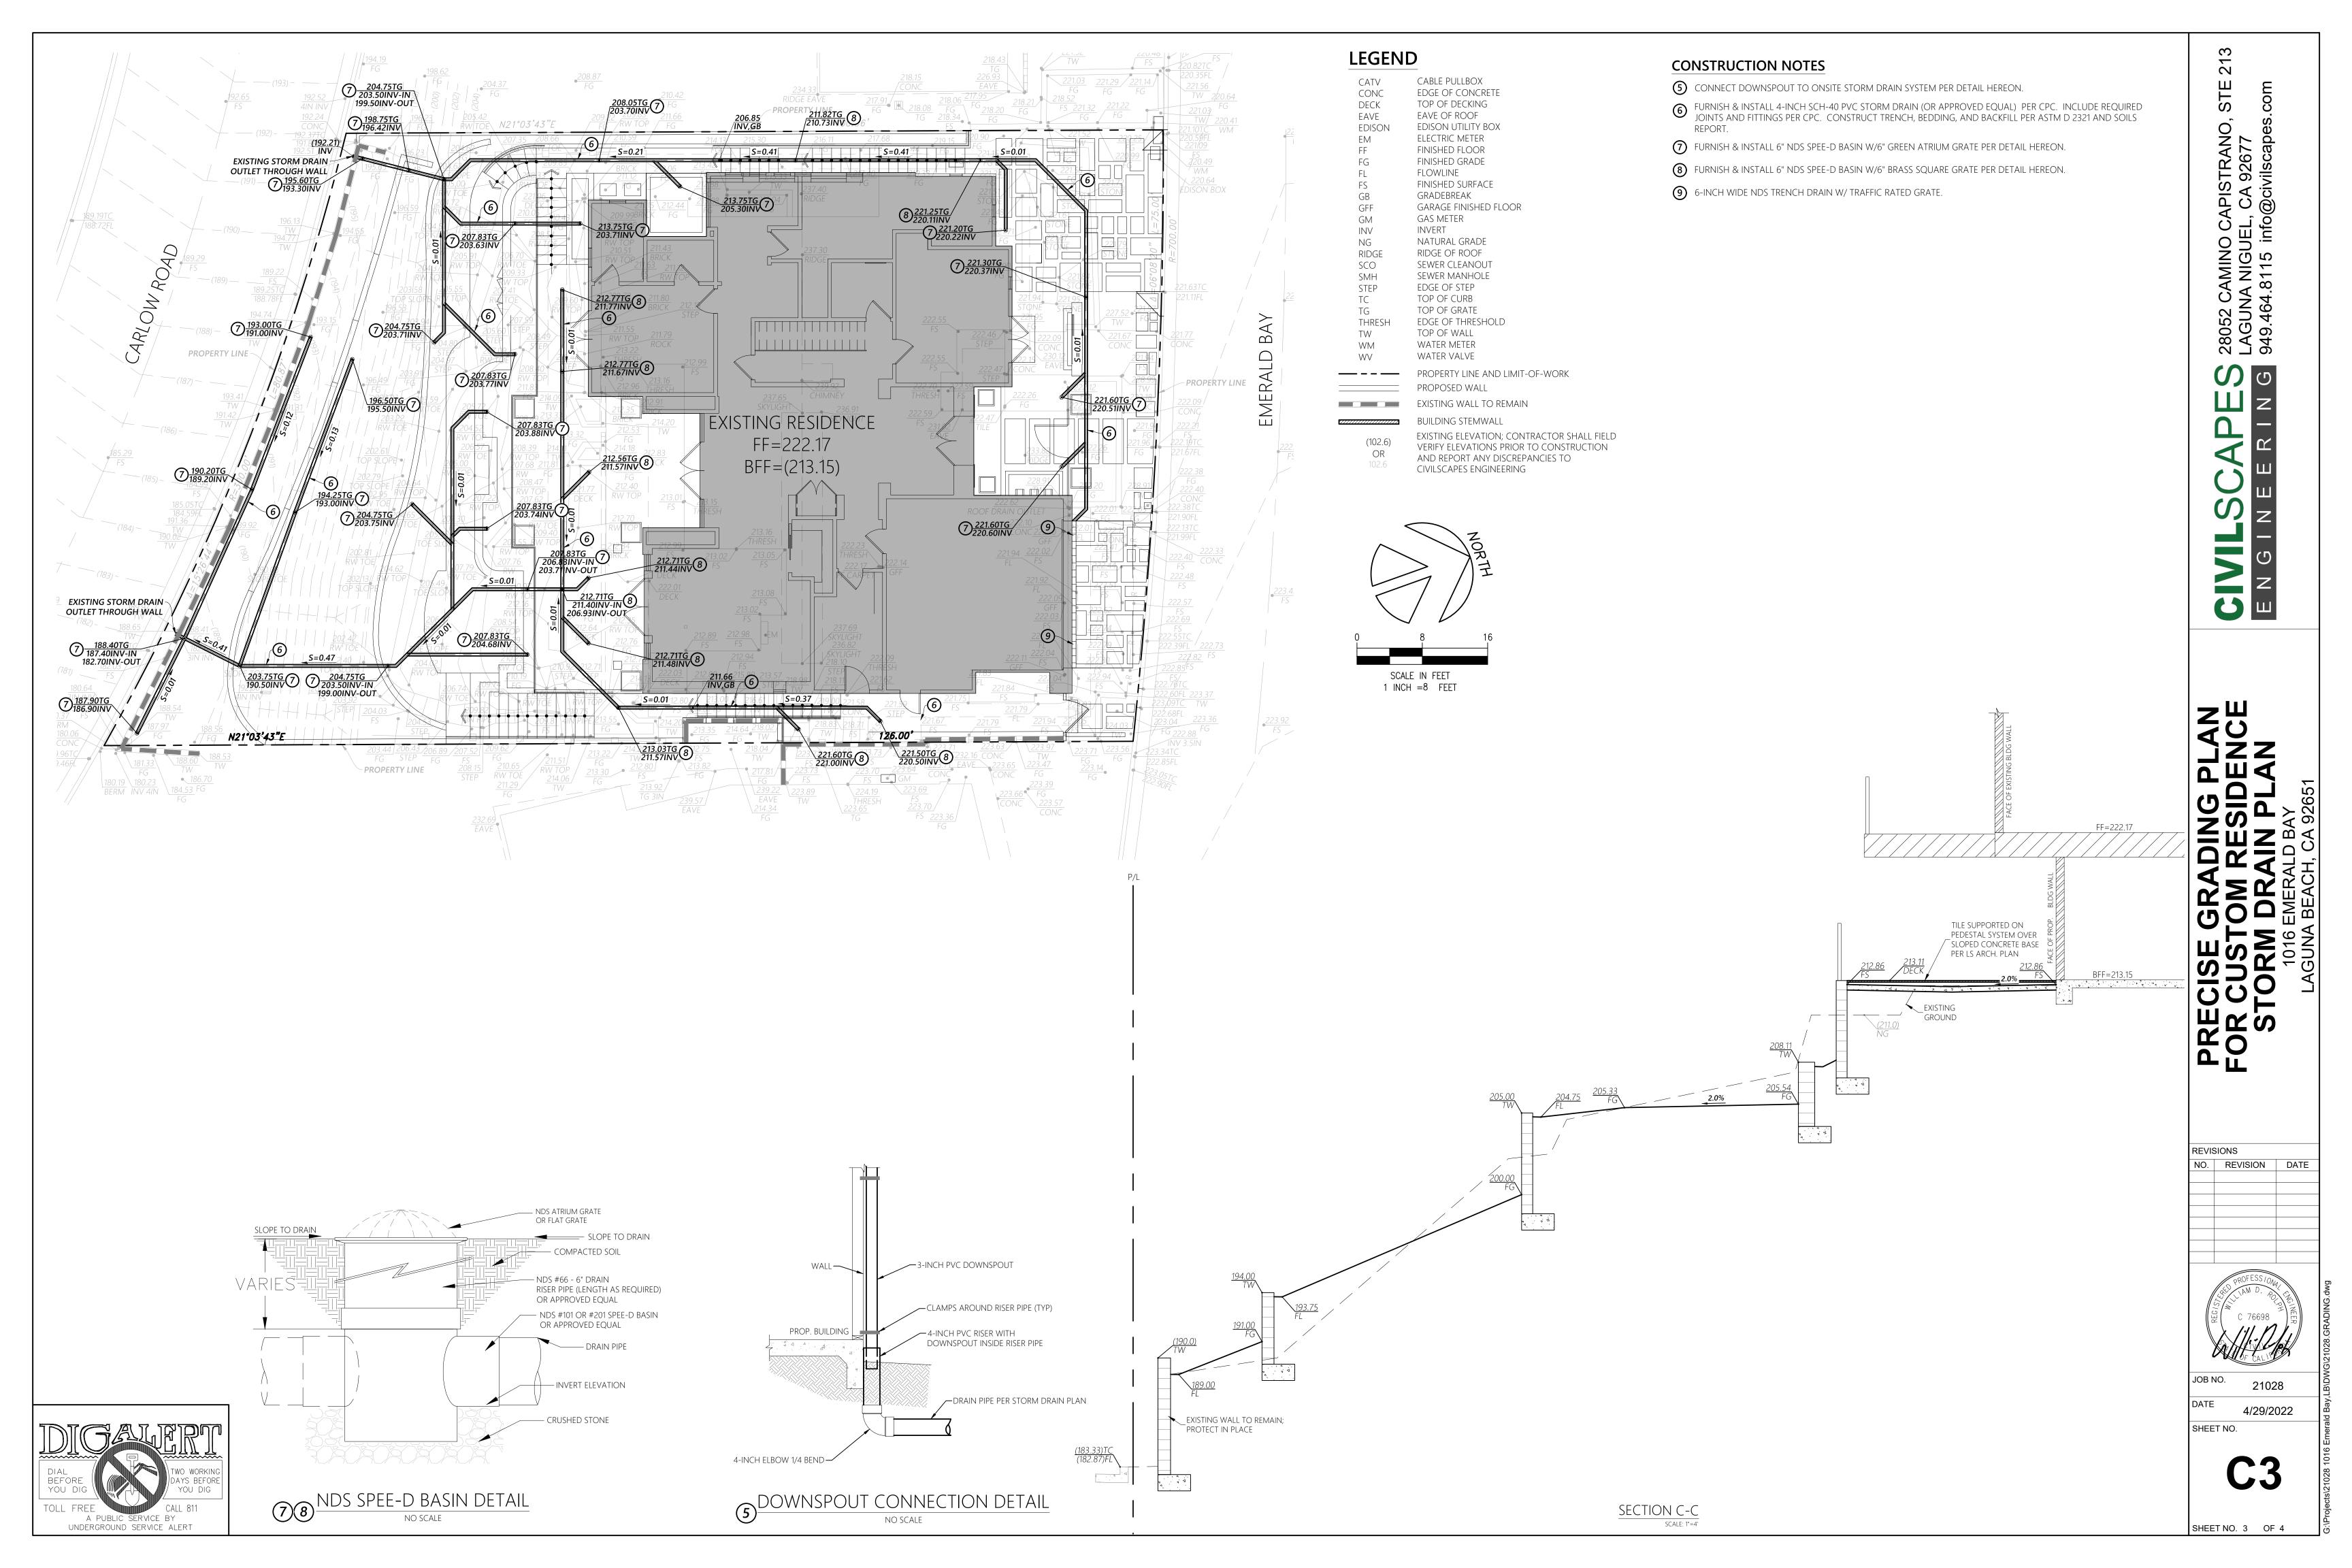

JOB NO. 21

DATE 4/29/2022 SHEET NO.

C4

SHEET NO. 4 OF 4



NOTES:

1. CONTRACTOR SHALL PROVIDE ONSITE CONCRETE WASHOUT FACILITY AND COMPLY WITH CASQA BMP WM-8.

2. ALL REMOVABLE EROSION PROTECTIVE DEVICES SHALL BE IN PLACE AT THE END OF EACH WORKING DAY WHEN THE 5-DAY RAIN PROBABILITY FORECAST EXCEEDS 40%.

3. SEDIMENTS FROM AREAS DISTURBED BY CONSTRUCTION SHALL BE RETAINED ON SITE USING AN EFFECTIVE COMBINATION OF EROSION AND SEDIMENT CONTROLS TO THE MAXIMUM EXTENT PRACTICABLE, AND STOCKPILES OF SOIL SHALL BE PROPERLY CONTAINED TO MINIMIZE SEDIMENT TRANSPORT FROM THE SITE TO STREETS, DRAINAGE FACILITIES OF ADJACENT PROPERTIES VIA RUNOFF, VEHICLE TRACKING, OR WIND.

3. APPROPRIATE BMPS FOR CONSTRUCTION-RELATED MATERIALS, WASTES, SPILLS OR RESIDUES SHALL BE IMPLEMENTED AND RETAINED ON SITE TO MINIMIZE TRANSPORT FROM THE SITE TO STREETS, DRAINAGE FACILITIES, OR ADJOINING PROPERTY BY WIND OR RUNOFF.

