| SDG&E LEGEND | | | |
|---------------|------------|--|--|
| STRUCTURE # | N/A | | |
| TIE-LINE # | N/A | | |
| R/W # | N/A | | |
| APN# | 125-171-14 | | |
| SBE# | 141-30-22 | | |
| LMR SIGNATURE | DATE: | | |

PROJECT TEAM

CLIENT REPRESENTATIVE

SMARTLINK, LLC 1997 ANNAPOLIS EXCHANGE PKWY, SUITE 200 CITY, STATE, ZIP: SUITE 200 ANNAPOLIS, MD 21401 ALISHA STRASHEIM

alisha.strasheim@smartlinkgroup.com

ZONING

COMPANY: SMARTLINK, LLC 1997 ANNAPOLIS EXCHANGE PKWY, ADDRESS: SUITE 200 CITY, STATE, ZIP: ANNAPOLIS, MD 21401 CONTACT: JOHN SILVERMAN

(818) 832-0631 PHONE: EMAIL: john.sllverman@smartlinkgroup.com

SITE ACQUISITION

SMARTLINK, LLC COMPANY: 1997 ANNAPOLIS EXCHANGE PKWY, SUITE 200 CITY, STATE, ZIP: ANNAPOLIS, MD 21401 CONTACT: JOHN SILVERMAN

PHONE: john.sllverman@smartlinkgroup.com

ENGINE

EMAIL:

CASA INDUSTRIES, INC. 4430 E. MIRALOMA AVE. SUITE D CITY, STATE, ZIP: ANAHEIM, CA 92807 JULIUS SANTIAGO PHONE: (714) 553-8899 EMAIL: jsantiago@casaind.com

SDG&E LAND MANAGER

ADDRESS: 8690 BALBOA AVE CP-A06 CITY, STATE, ZIP: SAN DIEGO, CA 92123 CONTACT: SEAN QUINN PHONE:

(619) 200-0610

squin@sdge.com

CONSTRUCTION MANAGER

1452 EDINGER AVE ADDRESS: CITY, STATE, ZIP: TUSTIN, CA. 92780 GREG EATON (310) 753-0691 greg.eaton@att.com

ATT PROJECT MANAGER

COMPANY: ADDRESS: 1452 EDINGER AVE CITY, STATE, ZIP: TUSTIN, CA. 92780 IVAN OCEGUEDA PHONE: (562) 210-9855 EMAIL: io109k@att.com

APPLICANT

COMPANY: ADDRESS: 1452 EDINGER AVE CITY, STATE, ZIP: TUSTIN, CA. 92780 IVAN OCEGUEDA (562) 210-9855 io109k@att.com

RF ENGINEER

739 E SANTA CLARA ST. **ROOM 217** CITY, STATE, ZIP: VENTURA, CA. 9300 GABBY DE SILVA (562) 216-0159

SDG&E WIRELESS COORDINATOR

gd8790@att.com

P.O. BOX 974 CITY,STATE,ZIP: DOLORES, CO 81323 JOHN J. HERNANDEZ (970) 882-3575 PHONE: john@drvci.com

SITE INFORMATION

APPLICANT / LESSEE



1452 EDINGER AVE. 3RD FLOOR

TUSTIN, CALIFORNIA 92780

PROPERTY OWNER

HANDICAP REQUIREMENTS:

SAN DIEGO GAS & ELECTRICITY ADDRESS: 8690 BALBOA AVE, CP-A01 CITY,STATE,ZIP: SAN DIEGO, CA 92123 CONTACT: **BRIAN NIEMELA** TELEPHONE: (858) 204-4664

LATITUDE: 33° 32' 58.57" N (33.549602°) 117° 37' 43.67" W (-117.628797°) LONGITUDE:

LAT./LONG. TYPE: NAD 83 **GROUND ELEVATION:** 602.6' AMSL ABOVE GROUND LEVEL: 35'-0" A.G.L. 125-181-03

±384 SQ. FT. AREA OF CONSTRUCTION: ORANGE COUNTY ZONING / JURISDICTION: **CURRENT ZONING:** A1 - GENERAL AGRICULTURE

PROPOSED USE: UNMANNED TELECOMMUNICATIONS FACILITY

HANDICAPPED ACCESS NOT REQUIRED

FACILITY IS UNMANNED AND NOT FOR HUMAN HABITATION.



Your world. Delivered

LOCAL MAP


SITE NUMBER: CLL01430 - NSB

SITE NAME: SDG&E MARGARITA SUBSTATION

FA#: 13025544 USID#: 314335

23082 ANTONIO PKWY LADERA RANCH, CA 92694 **ORANGE COUNTY**

VICINITY MAP

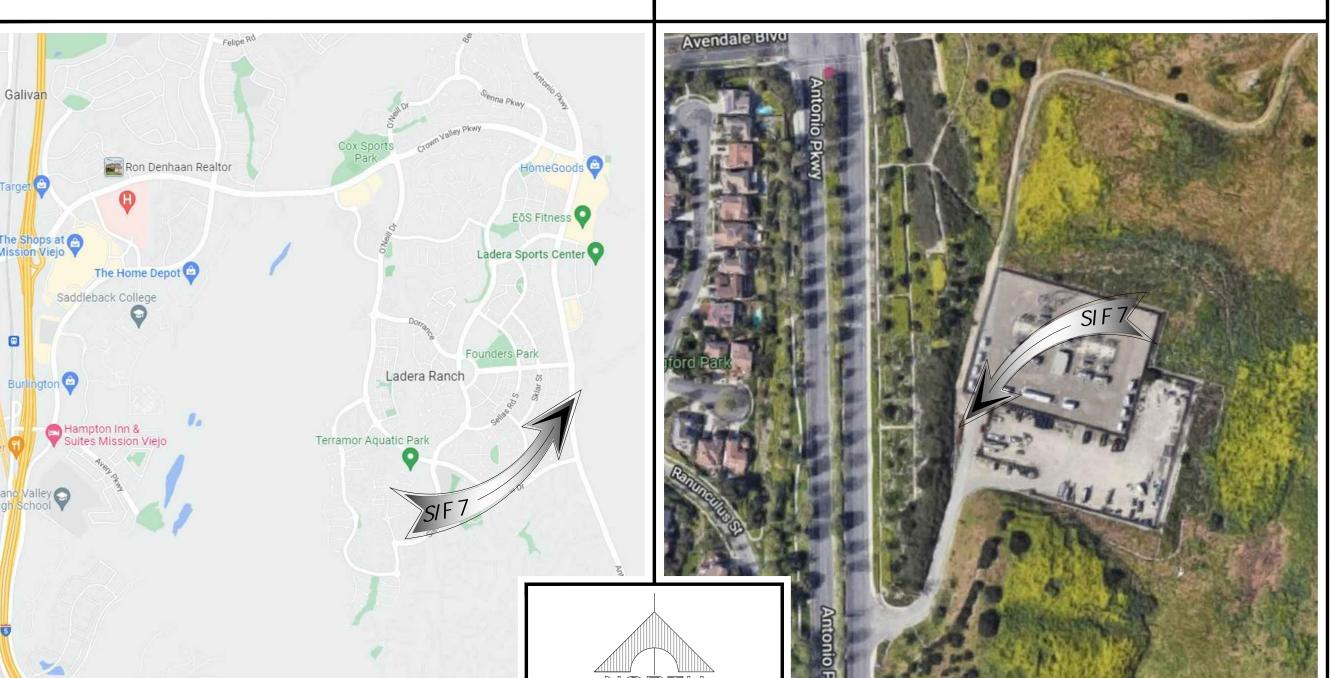

DRIVING DIRECTIONS

TURN RIGHT ONTO EDINGER AVE, TURN LEFT ONTO RED HILL AVE, TURN RIGHT TO MERGE ONTO I-5 S TOWARD SAN DIEGO, MERGE ONTO I-5 S, TAKE EXIT 86 FOR CROWN VALLEY PKWY, USE THE LEFT 3 LANES TO TURN LEFT ONTO CROWN VALLEY PKWY, TURN RIGHT ONTO ANTONIO PKWY, MAKE A U-TURN AT O'NEILL DR, DESTINATION WILL BE ON THE RIGHT.

CODE COMPLIANCE

ALL WORKS AND MATERIALS SHALL BE PERFORMED AND INSTALLED IN ACCORDANCE WITH THE CURRENT EDITIONS OF THE FOLLOWING CODES AS ADOPTED BY THE LOCAL GOVERNING AUTHORITIES. NOTHING IN THESE PLANS IS TO BE CONSTRUED TO PERMIT WORK NOT CONFORMING TO THE LATEST EDITIONS OF THE FOLLOWING CODES.

- 1. 2022 CALIFORNIA BUILDING CODE
- 2. 2022 CALIFORNIA ELECTRICAL CODE ADOPTED 2017 NEC
- 3. 2022 CALIFORNIA FIRE CODE
- 4. 2022 CALIFORNIA MECHANICAL CODE 5. 2022 CALIFORNIA PLUMBING CODE
- 7. COUNTY FIRE CODE ORDINANCE TITLE 16

6. 2022 CALIFORNIA ENERGY CODE

8. COUNTY LAND USE ORDINANCE - TITLE 22 9. COUNTY BUILDING AND CONSTRUCTION ORDINANCE - TITLE 19



APPROVALS

THE FOLLOWING PARTIES HEREBY APPROVE AND ACCEPT THESE DOCUMENTS & AUTHORIZE THE SUBCONTRACTOR TO PROCEED WITH THE CONSTRUCTION DESCRIBED HEREIN. ALL DOCUMENTS ARE SUBJECT TO REVIEW BY THE LOCAL BUILDING DEPARTMENT & MAY IMPOSE CHANGES OR MODIFICATIONS.

| DISCIPLINE: | SIGNATURE: | DATE: |
|-----------------------|------------|-------|
| AT&T RF ENGINEER: | | |
| AT&T OPERATIONS: | | |
| SITE ACQUISITION: | | |
| CONSTRUCTION MANAGER: | | |
| PROPERTY OWNER: | | |
| ZONING VENDOR: | | |
| PROJECT MANAGER: | | |

GENERAL CONTRACTOR NOTES

DO NOT SCALE DRAWINGS

SUBCONTRACTOR SHALL VERIFY ALL PLANS & EXISTING DIMENSIONS & CONDITIONS ON THE JOB SITE & SHALL IMMEDIATELY NOTIFY THE ENGINEER IN WRITING OF ANY DISCREPANCIES BEFORE PROCEEDING WITH THE WORK OR BE RESPONSIBLE FOR SAME

GENERAL NOTES

THE SITE AS REQUIRED FOR ROUTINE MAINTENANCE. THE PROJECT WILL NOT RESULT IN ANY SIGNIFICANT DISTURBANCE OR EFFECT ON DRAINAGE; NO SANITARY SEWER SERVICE, POTABLE WATER, OR TRASH DISPOSAL IS REQUIRED AND NO COMMERCIAL SIGNAGE IS PROPOSED.

PROJECT DESCRIPTION

'AT&T' PROPOSES TO CONSTRUCT. OPERATE AND MAINTAIN AN UNMANNED WIRELESS COMMUNICATIONS FACILITY. THIS FACILITY WILL CONSIST OF THE FOLLOWING:

- INSTALL 1 (P) 35'-0" HIGH MONO-EUCALYPTUS.
- INSTALL 1 (P) 6' HIGH CMU WALL ENCLOSURE WITH STONE VENEER.
- INSTALL 1 (P) 6' X 6' STEEL W.I.C. SHELTER ON CONCRETE PAD. INSTALL 1 (P) 20KW (51 GAL.) GENERAC COMPACT GENERATOR ON CONCRETE
- INSTALL (P) UTILITY PANELS. INSTALL 1 (P) GPS ANTENNA.
- INSTALL 2 (P) DC-12 OUTDOOR UNITS.
- INSTALL 12 (P) PANEL ANTENNAS (4 PER SECTOR). INSTALL 18 (P) LTE RRUS AT ANTENNA LEVEL (6 PER SECTOR).
- INSTALL 4 (P) DC-9 SURGE SUPPRESSORS (SQUID).
- INSTALL 1 (P) 2' Ø MW ANTENNA.

*APPROX. 1500' JOINT U/G BORING FOR POWER & TELCO RUN

DRAWING INDEX SHEET TITLE SHEET NO: T-1 TITLE SHEET SDGE NOTES SITE SURVEY LS-2 SURVEY NOTES SITE PLAN AND ENLARGED SITE PLAN ENLARGED SITE PLAN (PIPE RACK LOCATION) SHELTER AREA, ANTENNA PLAN AND ANTENNA/RRU SCHEDULE A-3**ELEVATIONS** EQUIPMENT SPECIFICATIONS A-5 DETAIL

CODE COMPLIANCE

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- 1. 2022 CALIFORNIA BUILDING CODE 6. 2022 CALIFORNIA ENERGY CODE 2. 2022 CALIFORNIA ELECTRICAL CODE 7. COUNTY COASTAL ZONE LAND USE ORDINANCE-TITLE 23
- ADOPTED 2017 NEC 8. COUNTY FIRE CODE ORDINANCE - TITLE 16 3. 2022 CALIFORNIA FIRE CODE 4. 2022 CALIFORNIA MECHANICAL CODE 9. COUNTY LAND USE ORDINANCE - TITLE 22
- 5. 2022 CALIFORNIA PLUMBING CODE 10. COUNTY BUILDING AND CONSTRUCTION ORDINANCE - TITLE 19



HE INFORMATION CONTAINED IN THIS SET OF DRAWINGS IS PROPRIETARY & CONFIDENTIAL TO AT&T WIRELESS ANY USE OR DISCLOSURE OTHER THAN AS IT RELATES TO AT&T WIRELESS IS STRICTLY PROHIBITED



1997 ANNAPOLIS EXCHANGE PKWY, SUITE 200 ANNAPOLIS, MD 21401 TEL: (949) 387-1265 FAX: (949) 387-1275



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|-----|----------|----------------------------------|
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| 1 | 12/12/22 | REVISED 95% ZONING DRAWINGS |
| 0 | 05/05/22 | 95% ZONING DRAWINGS |
| Α | 04/18/22 | 90% ZONING DRAWINGS |
| REV | DATE | DESCRIPTION |

NOT TO BE USED FOR CONSTRUCTION

IT IS A VIOLATION OF LAW FOR ANY PERSON, UNLESS THEY ARE ACTING UNDER THE DIRECTION OF A LICENSED PROFESSIONAL ENGINEER, TO ALTER THIS DOCUMENT.

CLL01430 SDGE MARGARITA SUBSTATION 23082 ANTONIO PKWY LADERA RANCH, CA 92694 MONO-EUCALYPTUS (INDOOR)

DRAWN BY: CHECKED BY: EMS

SHEET TITLE:

TITLE SHEET

SHEET NUMBER:

ENVIRONMENTAL REQUIREMENTS

THE FOLLOWING LIST SUMMARIZES RECOMMENDED ENVIRONMENTAL PROTOCOLS THAT SHOULD BE OBSERVED BY CARRIER AND CONTRACTOR FIELD CREWS DURING ANY SITE CONSTRUCTION OR MAINTENANCE ACTIVITIES. IN ADDITION, CARRIER AND CONTRACTOR FIELD CREWS SHOULD FOLLOW SDG&E'S ENVIRONMENTAL FIELD PROTOCOLS (APPENDIX C).

· VEHICLES MUST BE KEPT ON ACCESS ROADS. A 15-MILE-PER-HOUR SPEED LIMIT SHALL BE OBSERVED ON DIRT ACCESS ROADS TO ALLOW REPTILE SPECIES TO DISPERSE. VEHICLES MUST BE TURNED AROUND IN ESTABLISHED

- OR DESIGNATED AREAS ONLY.
- NO WILDLIFE, INCLUDING RATTLESNAKES, MAY BE HARMED, EXCEPT TO PROTECT LIFE AND LIMB.
- · FIREARMS SHALL BE PROHIBITED ON THE RIGHTS-OF-WAY EXCEPT FOR THOSE USED BY SECURITY PERSONNEL.
- · FEEDING OF WILDLIFE IS NOT ALLOWED.
- CARRIER AND CONTRACTOR PERSONNEL ARE NOT ALLOWED TO BRING PETS ON THE RIGHTS—OF—WAY IN ORDER TO MINIMIZE HARASSMENT OR KILLING OF WILDLIFE AND TO PREVENT THE INTRODUCTION OF DESTRUCTIVE DOMESTIC ANIMAL DISEASES TO NATIVE WILDLIFE POPULATIONS.
- PARKING OR DRIVING UNDERNEATH OAK TREES IS NOT ALLOWED IN ORDER TO PROTECT ROOT STRUCTURES EXCEPT IN ESTABLISHED TRAFFIC AREAS.
- · PLANT OR WILDLIFE SPECIES MAY NOT BE COLLECTED FOR PETS OR FOR ANY OTHER REASON.
- · LITTERING IS NOT ALLOWED. NEITHER CARRIER NOR CONTRACTOR PERSONNEL SHALL DEPOSIT OR LEAVE ANY FOOD OR WASTE ON THE RIGHTS-OF-WAY OR ADJACENT PROPERTY.
- WILDFIRES SHALL BE PREVENTED OR MINIMIZED BY EXERCISING CARE WHEN DRIVING AND BY NOT PARKING VEHICLES WHERE CATALYTIC CONVERTERS CAN IGNITE DRY VEGETATION. IN TIMES OF HIGH FIRE HAZARD, IT MAY BE NECESSARY FOR TRUCKS TO CARRY WATER AND SHOVELS, OR FIRE EXTINGUISHERS IN THE FIELD. THE USE OF SHIELDS, PROTECTIVE MATS, OR OTHER FIRE PREVENTION METHODS SHALL BE USED DURING GRINDING AND WELDING TO PREVENT OR MINIMIZE THE POTENTIAL FOR FIRE. CARE SHOULD BE EXHIBITED WHEN SMOKING IN NATURAL HABITATS.
- CARRIER AND CONTRACTOR FIELD CREWS SHALL REFER ENVIRONMENTAL ISSUES INCLUDING WILDLIFE RELOCATION,
 DEAD OR SICK WILDLIFE, HAZARDOUS WASTE, OR QUESTIONS ABOUT AVOIDING ENVIRONMENTAL IMPACTS TO
 CARRIER'S ENVIRONMENTAL FIELD MONITOR. CARRIER'S ENVIRONMENTAL FIELD MONITOR MAY NEED TO ENLIST
 BIOLOGISTS OR EXPERTS IN WILDLIFE HANDLING TO ASSIST WITH WILDLIFE RELOCATIONS

ANTENNA GENERAL INSTALLATION/CONSTRUCTION NOTES:

1. NEW STEEL (EXCEPT PIPE) SHALL CONFORM TO THE REQUIREMENTS OF THE "STANDARDS SPECIFICATION FOR STRUCTURAL STEEL" ASTM A36 (36 KSI YIELD POINT MATERIAL).

2. NEW STEEL PIPE SHALL CONFORM TO THE REQUIREMENTS OF THE "STANDARD SPECIFICATIONS FOR THE PIPE, STEEL, BLACK AND HOT DIPPED, ZINC COATED, WELDED AND SEAMLESS" ASTM A53 TYPE E OR S GRADE B (35 KSI YIELD POINT MATERIAL) OR THE "STANDARD SPECIFICATIONS FOR HOT FORMED WELDED AND SEAMLESS CARBON STEEL STRUCTURAL TUBING" ASTM A 501 (36 KSI YIELD POINT MATERIAL). PIPE SHALL BE GALVANIZED INSIDE AND OUTSIDE.

3. NO HOLES SHALL BE MADE IN ANY STEEL MEMBERS OF SDG&E STEEL TRANSMISSION STRUCTURES UNLESS OTHERWISE AUTHORIZED BY SDG&E. SAID AUTHORIZATION SHALL BE IN WRITING. NO HOLE BURNING SHALL BE

4. NEW BOLTS CONFORM TO THE REQUIREMENTS FOR THE "SPECIFICATIONS FOR HIGH STRENGTH BOLTS FOR STRUCTURAL STEEL JOINTS" ASTM A325. ALL HOLES FOR BOLTS SHALL BE 1/16 INCH LARGER THAN THE BOLT DIAMETER WITH AN EDGE DISTANCE OF AT LEAST 1 3/4 TIMES THE BOLT DIAMETER AND A SPACING OF AT LEAST 3 TIMES THE BOLT DIAMETER. ALL BOLTS SHALL BE PROVIDED WITH PAL-NUTS OR LOCK NUTS.

5. NO WELDING ON ANY STEEL MEMBERS OF SDG&E STEEL TRANSMISSION STRUCTURES UNLESS OTHERWISE AUTHORIZED BY SDG&E. SAID AUTHORIZATION SHALL BE IN WRITING. ALL NEW STEEL SHALL BE HOT-DIPPED GALVANIZED AFTER FABRICATION. GALVANIZING SHALL CONFORM TO THE REQUIREMENTS OF THE "SPECIFICATION FOR ZINC (HOT-GALVANIZED) COATING ON PRODUCTS FABRICATED FROM ROLLED, PRESSED AND FORGED STEEL SHAPES, PLANES, BARS, AND STRIP ASTM A123. AND THE "SPECIFICATION FOR ZINC-COATING (HOT-DIP) ON ASSEMBLED STEEL PRODUCTS" ASTM A386.

6. BOLTS SHALL BE GALVANIZED ACCORDING TO THE "STANDARD SPECIFICATIONS FOR ZINC-COATING (HOT-DIP) ON IRON AND STEEL HARDWARE" ASTM A153.

7. INFORMATION WAS TAKEN FROM EXISTING TOWER STRUCTURAL DRAWINGS. SDG&E HAS NOR MADE FIELD INSPECTION TO VERIFY TOWER MEMBER SIZE AND DIMENSIONS. IF THE EXISTING CONDITIONS ARE NOT AS REPRESENTED AS SHOWN ON DRAWINGS, SDG&E SHOULD BE CONTACTED IMMEDIATELY TO RE-EVALUATE THE STRUCTURAL INTEGRITY OF THE TOWER.

8. KNOWLEDGEABLE WORKMEN WITH TOWER CONSTRUCTION EXPERIENCE SHOULD ACCOMPLISH ANY STRUCTURAL MODIFICATION WORK SPECIFIED ON THESE SKETCHES.

9. DRAWINGS DO NOT INDICATE THE METHOD OF CONSTRUCTION. THE CONTRACTOR SHALL SUPERVISE AND DIRECT THE WORK AND SHALL BE SOLELY RESPONSIBLE FOR ALL CONSTRUCTION MEANS, METHODS, TECHNIQUES, SEQUENCES AND PROCEDURES.

10. IT IS THE CONTRACTORS SOLE RESPONSIBILITY TO DETERMINE THE ERECTION PROCEDURE AND SEQUENCE TO INSURE THE STABILITY AND SAFETY OF THE TOWER AND PIPE RISER AND THE ADEQUACY OF TEMPORARY OR INCOMPLETE CONNECTIONS DURING CONSTRUCTION.

11. THE CONTRACTOR SHALL BE RESPONSIBLE FOR THE INITIATING, MAINTAINING AND SUPERVISING ALL SAFETY PRECAUTIONS AND PROGRAMS IN CONNECTION WITH THE WORK. THIS INCLUDES WHAT EVER PROVISIONS NEED TO BE TAKEN TO PROTECT THE PROPERTY IN THE VICINITY OF THE TOWER DURING CONSTRUCTION.

12. THE STRUCTURAL ANALYSIS ASSUMES THAT ALL TOWER COMPONENTS ARE IN BRAND-NEW CONDITION. NO ALLOWANCE WAS MADE FOR ANY DAMAGED, MISSING OR RUSTED MEMBERS. IF ANY OF THESE CONDITIONS ARE

DISCOVERED THE CONTRACTOR SHALL BRING THEM TO THE ATTENTION OF SDG&E.

13. THE TOWER HAS BEEN ANALYZED ACCORDING TO THE ELECTRIC UTILITY'S REQUIREMENTS. IF THE TOWER MOUNT

OWNER OR LOCAL OR STATE AGENCIES REQUIRE A HIGHER DIVISION WIND VELOCITY, AND/OR ICE CONDITIONS, SDG&E SHOULD BE MADE AWARE OF THESE REQUIREMENTS.

14. DURING CONSTRUCTOR THE CONTRACTOR SHALL COORDINATE WITH THE ELECTRIC UTILITY AND CORDON OFF

AREAS BELOW AND AROUND THE WORK TO PREVENT INJURY TO, PERSONS AND/OR PROPERTY BELOW. DAMAGE

RESULTING FROM THE CONSTRUCTION WORK SHALL BE REPAIRED AT THE CONTRACTOR'S EXPENSE.

15. DRAWINGS SHOULD SHOW DETAILS OF THE FABRICATED MATERIAL AS WELL AS DETAILS OF ATTACHING THIS NEW MATERIAL TO AN EXISTING STRUCTURE. THE CONTRACTOR IS RESPONSIBLE FOR ATTACHING MATERIAL TO THE EXISTING STRUCTURE AT LOCATIONS SPECIFIED. THE CONTRACTOR SHALL FIELD VERIFY THAT THE SPECIFIED LOCATIONS WILL HAVE PROPER FIT AND CLEARANCE. SDG&E SHOULD BE CONTACTED IF THE EXISTING CONDITIONS ARE DIFFERENT THAN THOSE SPECIFIED BY SDG&E.

16. ALL FIELD CUT SURFACES, FIELD DRILLED HOLE SURFACES, AND DAMAGED GALVANIZED SURFACES SHALL BE REPAIRED WITH "GALVANOX" PAINT OR EQUAL.

17. THE MINIMUM EDGE DISTANCE FOR ALL HORIZONTAL BRACING MEMBERS USED TO CONNECT THE PIPE RISER TO THE EXISTING LATTICE STRUCTURE SHALL BE 1.25" FOR 5/8" DIAMETER BOLTS AND 1.25" FOR ¾"DIAMETER MINIMUM EDGE DISTANCE BEING DEFINED AS THE MINIMUM DIMENSION PARALLEL TO THE LONG AXIS OF THE BRACING MEMBERS, WHICH EXTENDS FROM THE EDGE OF METAL TO THE CENTERLINE OF THE CONNECTION HOLE.

18. PCS SYSTEM GROUNDING CAN BE TIED TO THE TOWER GROUNDING SYSTEM. PROTECTION FROM FAULT OCCURRENCE IS THE SOLE RESPONSIBILITY OF THE PCS CARRIER. ALL OBJECTS MOUNTED ON ANY SDG&E STRUCTURE SHALL BE GROUNDED OR ELECTRICALLY CONNECTED TO THE STEEL STRUCTURE.



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| REV | DATE | DESCRIPTION |

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CLL01430
SDGE MARGARITA SUBSTATION
23082 ANTONIO PKWY
LADERA RANCH, CA 92694
MONO-EUCALYPTUS (INDOOR)


| DRAWN BY: | CHECKED BY |
|-----------|------------|
| EMS | JS |

SHEET TITLE:

SDGE NOTES

SHEET NUMBER:

GN-1

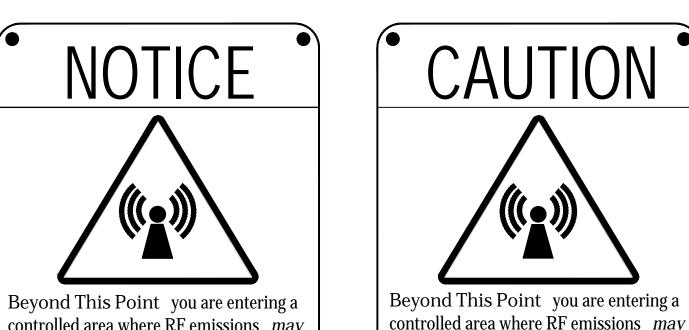

controlled area where RF emissions may exceed the FCC General Population Exposure Limits.

Follow all posted signs and site guidelines for working in a RF environment.

WARNING!

DANGER DO NOT TOUCH TOWER!

SERIOUS "RF" BURN HAZARD!

MAINTAIN AN ADEQUATE CLEARANCE

BETWEEN TOWER SUPPORTS AND GUY

FAILURE TO OBEY ALL POSTED SIGNS AND SITE
GUIDELINES FOR WORKING IN A RADIO FREQUENCY
ENVIRONMENT COULD RESULT IN SERIOUS INJURY.
CONTACT CURRENT MAY EXCEED LIMITS PRESCRIBED
IN ANSI/FEF C95 1-1992 FOR CONTROLLED.

ALERTING SIGN


NO SCALE

Ref: 47CFR 1.1307(b)



Limits.



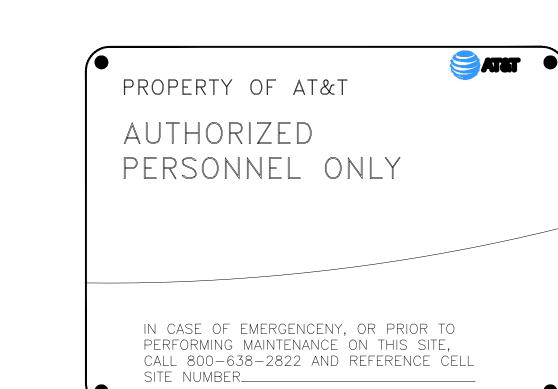

exceed the FCC Occupational Exposure

Obey all posted signs and site guidelines for

SATET

working in a RF enviroment.

INFO SIGN #5



INFORMATION

ACTIVE ANTENNAS ARE MOUNTED

STAY BACK A MINIMUM

OF 3 FEET

FROM THESE ANTENNAS

Contact AT&T at $_$ and follow their instructions prior to performing any maintenance or repairs closer than 3 feet from the

ON THE OUTSIDE OF THIS BUILDING

BEHIND THIS PANEL

ON THIS STRUCTURE

This is AT&T site#_

INFORMATION

INFO SIGN #3
NO SCALE

away from any antenna and obey all posted signs.

Contact the owner(s) of the antenna(s) before working closer than 3 feet from the antenna.

Contact AT&T at ______ prior to performing any maintenance or repairs near AT&T antennas. This is Site#_____

Contact the management office if this door/hatch/gate is found unlocked.

AT&T operates telecommunications antennas at this location. Remain at least 3 feet

INFORMACION

una distancia de no menos de 3 pies y obedecer todos los avisos.

Comuniquese con el propictario o los propicatarios de las antenas antes de trabajar o caminar a una distancia de menos de 3 pies de la antena.

Comuniquese con AT&T ______antes de realizar cualquier mantenimiento o reparaciones cerca de la antenas de AT&T.

Esta es la estacion base numero_____

Favor comunicarse con la oficina de la administracion del edificio si esta puerta o compuerta encuentra sin candado.

NO SCALE



ATET

INFO SIGN #2
NO SCALE


INFO SIGN #4

at&t



NFPA SIGN

NO SCALE

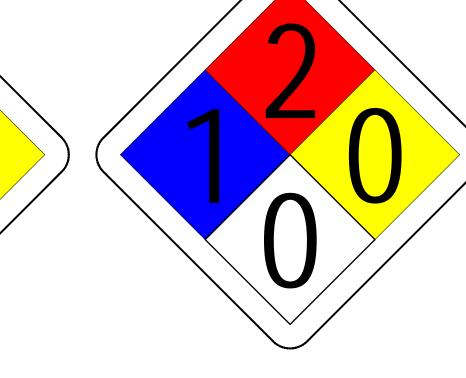

ALERTING SIGN


NO SCALE



THIS ROOM CONTAINS
LEAD ACID BATTERY SYSTEMS
AND

ENERGIZED CIRCUITS
Electrolyte Solutions Are Corrosive

NFPA SIGN
NO SCALE

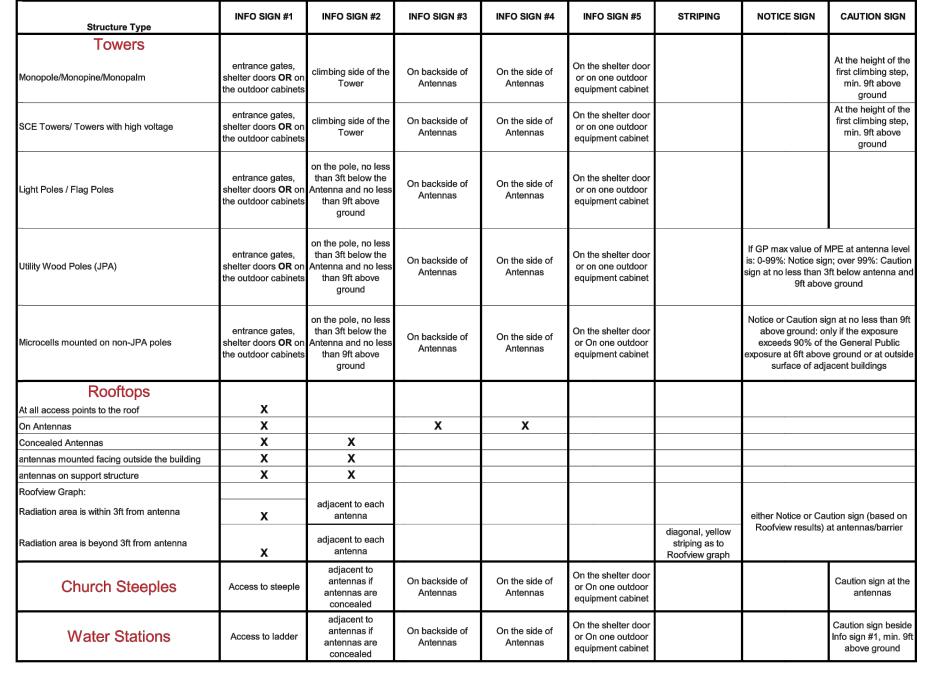

GENERAL SIGNAGE GUIDELINES

Notes for Rooftop sites:

- 1. Either NOTICE or CAUTION signs need to be posted at each sector as close as possible to: the outer edge of the striped off area or the outer antennas of the sector.
- 2. If Roofview shows: only blue = Notice Sign, blue and yellow = Caution Sign, only yellow = Caution Sign to be installed.
- 3. Should the required striping area interfere with any structures or equipment (A/C, vents, roof hatch, doors, other antennas, dishes, etc.),
- please notify AT&T to modify the striping area, prior to starting the work

SIGNAGE GUIDELINES CHART




NO SCALE

NO SMOKING SIGN



GALLON CAPACITY SIGN
NO SCALE

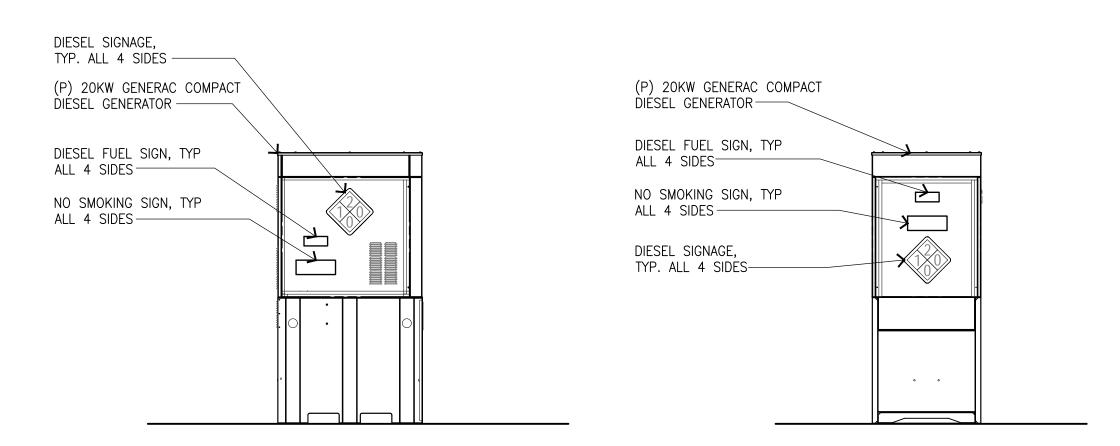

GENERATOR SIGNAGE DETAIL



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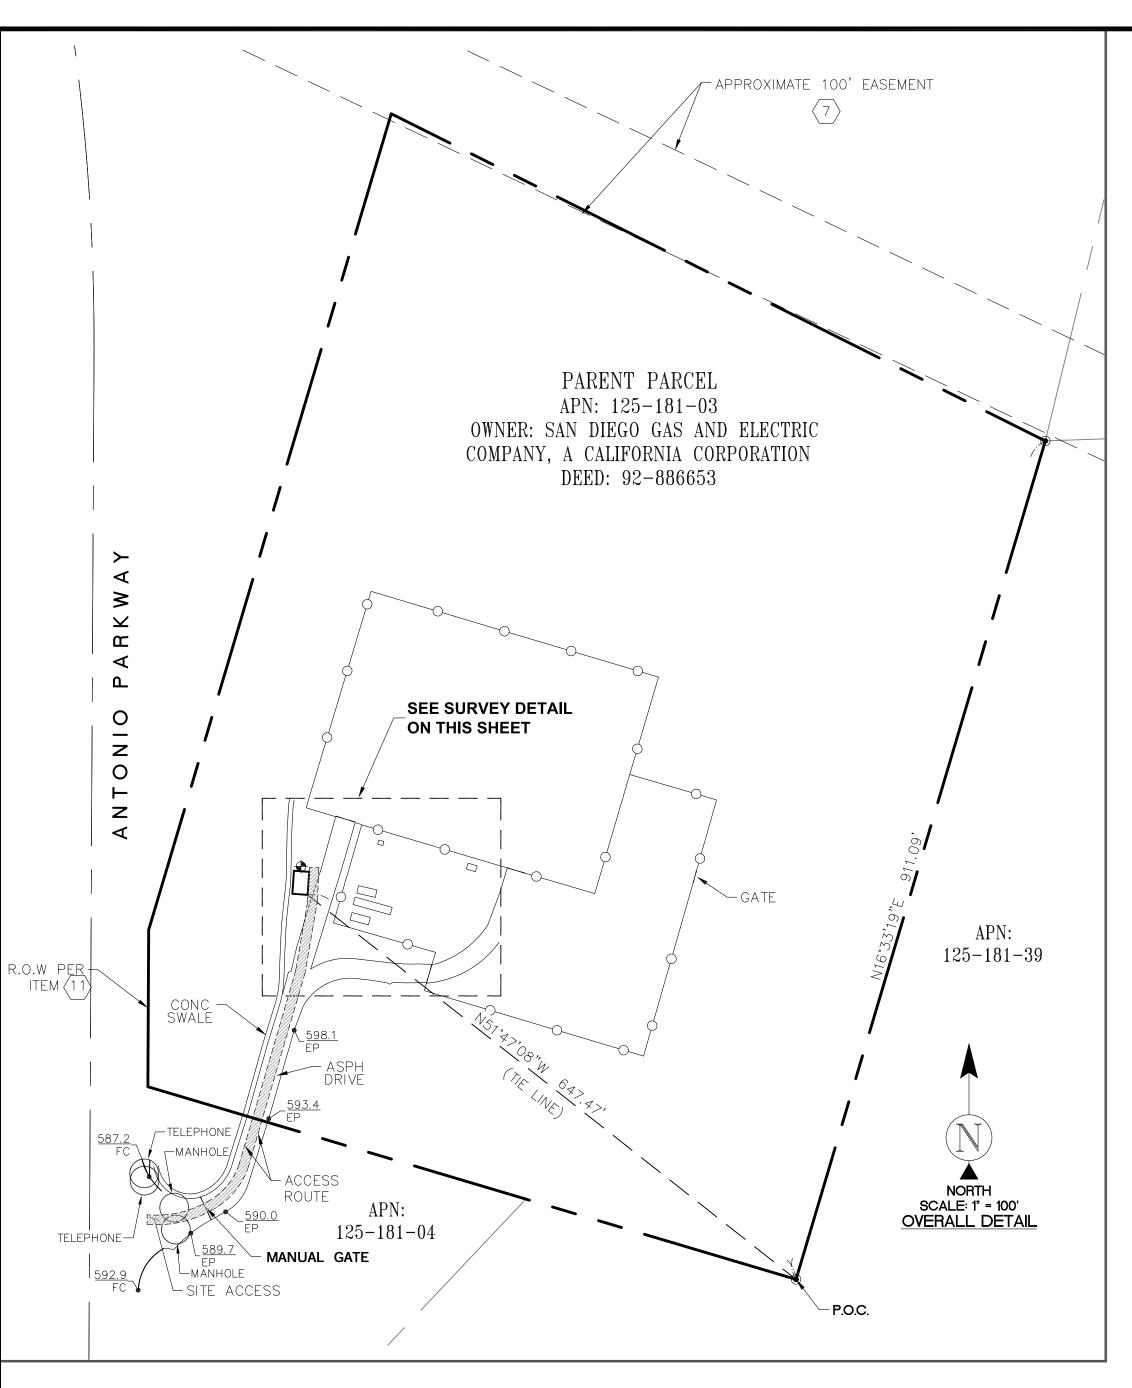
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|-----------|-------------|
| EMS | JS |

SHEET TITLE:

GENERAL SIGNAGE

SHEET NUMBER:

GN-1



SURVEY DATE 09/13/2022

BASIS OF BEARING

BEARINGS SHOWN HEREON ARE BASED UPON THE CALIFORNIA ZONE SIX STATE PLANE COORDINATE SYSTEM BASED ON THE NORTH AMERICAN DATUM OF 1983(2011) (EPOCH 2019.25). DETERMINED BY GLOBAL POSITIONING SYSTEM EQUIPMENT ON THE SMARTNET REFERENCE NETWORK.

PROJECT ELEVATIONS ESTABLISHED FROM GPS DERIVED ORTHOMETRIC HEIGHTS BY APPLICATION OF NGS 'GEOID 12B' MODELED SEPARATIONS TO ELLIPSOID HEIGHTS DETERMINED BY OBSERVATIONS OF THE 'SMARTNET' REAL TIME NETWORK. ALL ELEVATIONS SHOWN HEREON ARE REFERENCED TO NAVD88.

GRID-TO-GROUND SCALE FACTOR NOTE ALL BEARINGS AND DISTANCES ARE BASED ON THE CALIFORNIA STATE ZONE SIX STATE PLANE COORDINATE ZONE GRID. TO DERIVE GROUND DISTANCES DIVIDE BY 0.99996120

THIS PROJECT APPEARS TO BE LOCATED WITHIN FLOOD ZONE "X". ACCORDING TO FEDERAL EMERGENCY MANAGEMENT AGENCY FLOOD INSURANCE RATE MAP(S), MAP ID #06059C0442J, DATED 12/03/2009

UTILITY NOTES

SURVEYOR DOES NOT GUARANTEE THAT ALL UTILITIES ARE SHOWN OR THEIR LOCATIONS ARE DEFINITE. IT IS THE RESPONSIBILITY OF THE CONTRACTOR AND DEVELOPER TO CONTACT 811 AND ANY OTHER INVOLVED AGENCIES TO LOCATE ALL UTILITIES PRIOR TO CONSTRUCTION. REMOVAL, RELOCATION AND/ OR REPLACEMENT IS THE RESPONSIBILITY OF THE CONTRACTOR.

LEASE AREA LEGAL DESCRIPTION

A PORTION OF PARCEL A, LABELED "MARGARITA SUBSTATION" AS SHOWN ON RECORD OF SURVEY 95-1066, AS INSTRUMENT NUMBER 95-0211614 IN BOOK 154, PAGES 8 THRU 18, ORANGE COUNTY RECORDS, BEING MORE PARTICULARLY DESCRIBED AS FOLLOWS:

COMMENCING ON A 2 INCH IRON PIN AT THE SOUTHEAST CORNER OF SAID PARCEL, AS SHOWN ON SAID RECORD OF SURVEY, FROM WHICH A 2 INCH IRON PIN AT THE NORTHEAST CORNER OF SAID PARCEL, AS SHOWN ON SAID RECORD OF SURVEY, BEARS NORTH 16°33'19" EAST, 911.09 FEET; THENCE LEAVING SAID POINT OF COMMENCEMENT, NORTH 51°47'08" WEST, 647.47 FEET TO THE POINT OF BEGINNING.

THENCE NORTH 86°01'16" WEST, 16.00 FEET; NORTH 03°58'44" EAST, 24.00 FEET; SOUTH 86°01'16" EAST, 16.00 FEET; SOUTH 03°58'44" WEST, 24.00 FEET TO THE POINT OF BEGINNING;

CONTAINING 384 SQUARE FEET (0.009 ACRES) OF LAND, MORE

SURVEYOR'S NOTES


CONTOURS DERIVED FROM DIRECT FIELD OBSERVATIONS AND FOLLOW THE CURRENT NATIONAL MAP STANDARDS FOR VERTICAL ACCURACY.


THE BOUNDARY SHOWN HEREON IS PLOTTED FROM RECORD INFORMATION AND DOES NOT CONSTITUTE A BOUNDARY SURVEY OF THE PROPERTY.

ALL DISTANCES SHOWN HEREON ARE GRID DISTANCES.

SURVEYOR HAS NOT PERFORMED A SEARCH OF PUBLIC RECORDS TO DETERMINE ANY DEFECT IN TITLE ISSUED.

POSITION OF GEODETIC COORDINATES LATITUDE 33° 32' 58.57" (33.549602°) NORTH (NAD83) LONGITUDE 117° 37' 43.67" (117.628797°) WEST (NAD83) GROUND ELEVATION @ 602.6' (NAVD88)

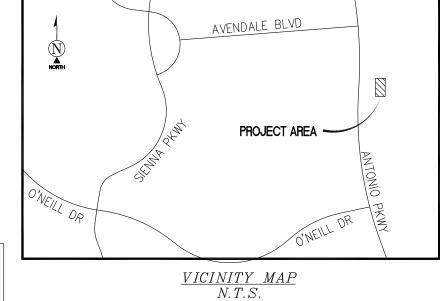


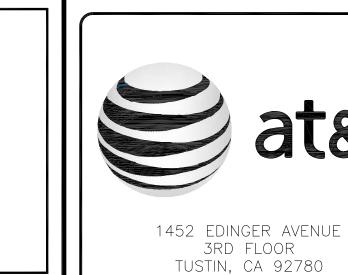





| 1 | 12/05/22 | TITLE/DESIGN | (SM) |
|-----|----------|--------------|------|
| А | 09/26/22 | PRELIMINARY | (RR) |
| REV | DATE | DESCRIPTION | |
| 40 | | • | |

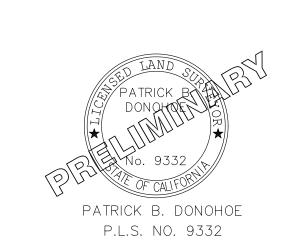

IT IS A VIOLATION OF LAW FOR ANY PERSON, UNLESS THEY ARE ACTING UNDER THE DIRECTION OF A LICENSED PROFESSIONAL SURVEYOR, TO ALTER THIS DOCUMENT.

CLL01430

AVENDALE BOULEVARD & ANTONIO PARKWAY LADERA RANCH, CA, 92694

> SHEET TITLE SITE SURVEY


SHEET NUMBER

LEGEND

AP ASPHALT

CONC CONCRETE Oxxxx UTILITY MANHOLES EP EDGE OF PAVEMENT FC FACE OF CURB POSITION OF NG NATURAL GRADE GEODETIC COORDINATES SPOT ELEVATION RIGHT OF WAY LINES

TOP TOP OF SLOPE P.O.B. POINT OF BEGINNING P.O.C. POINT OF COMMENCEMENT -O-O-O-O-O-CHAIN LINK FENCE - - SUBJECT PROPERTY LINE ----- ADJACENT PROPERTY LINE - ---- LEASE AREA LIMITS — — — — — MAJOR CONTOUR INTERVAL — — — — — — MINOR CONTOUR INTERVAL

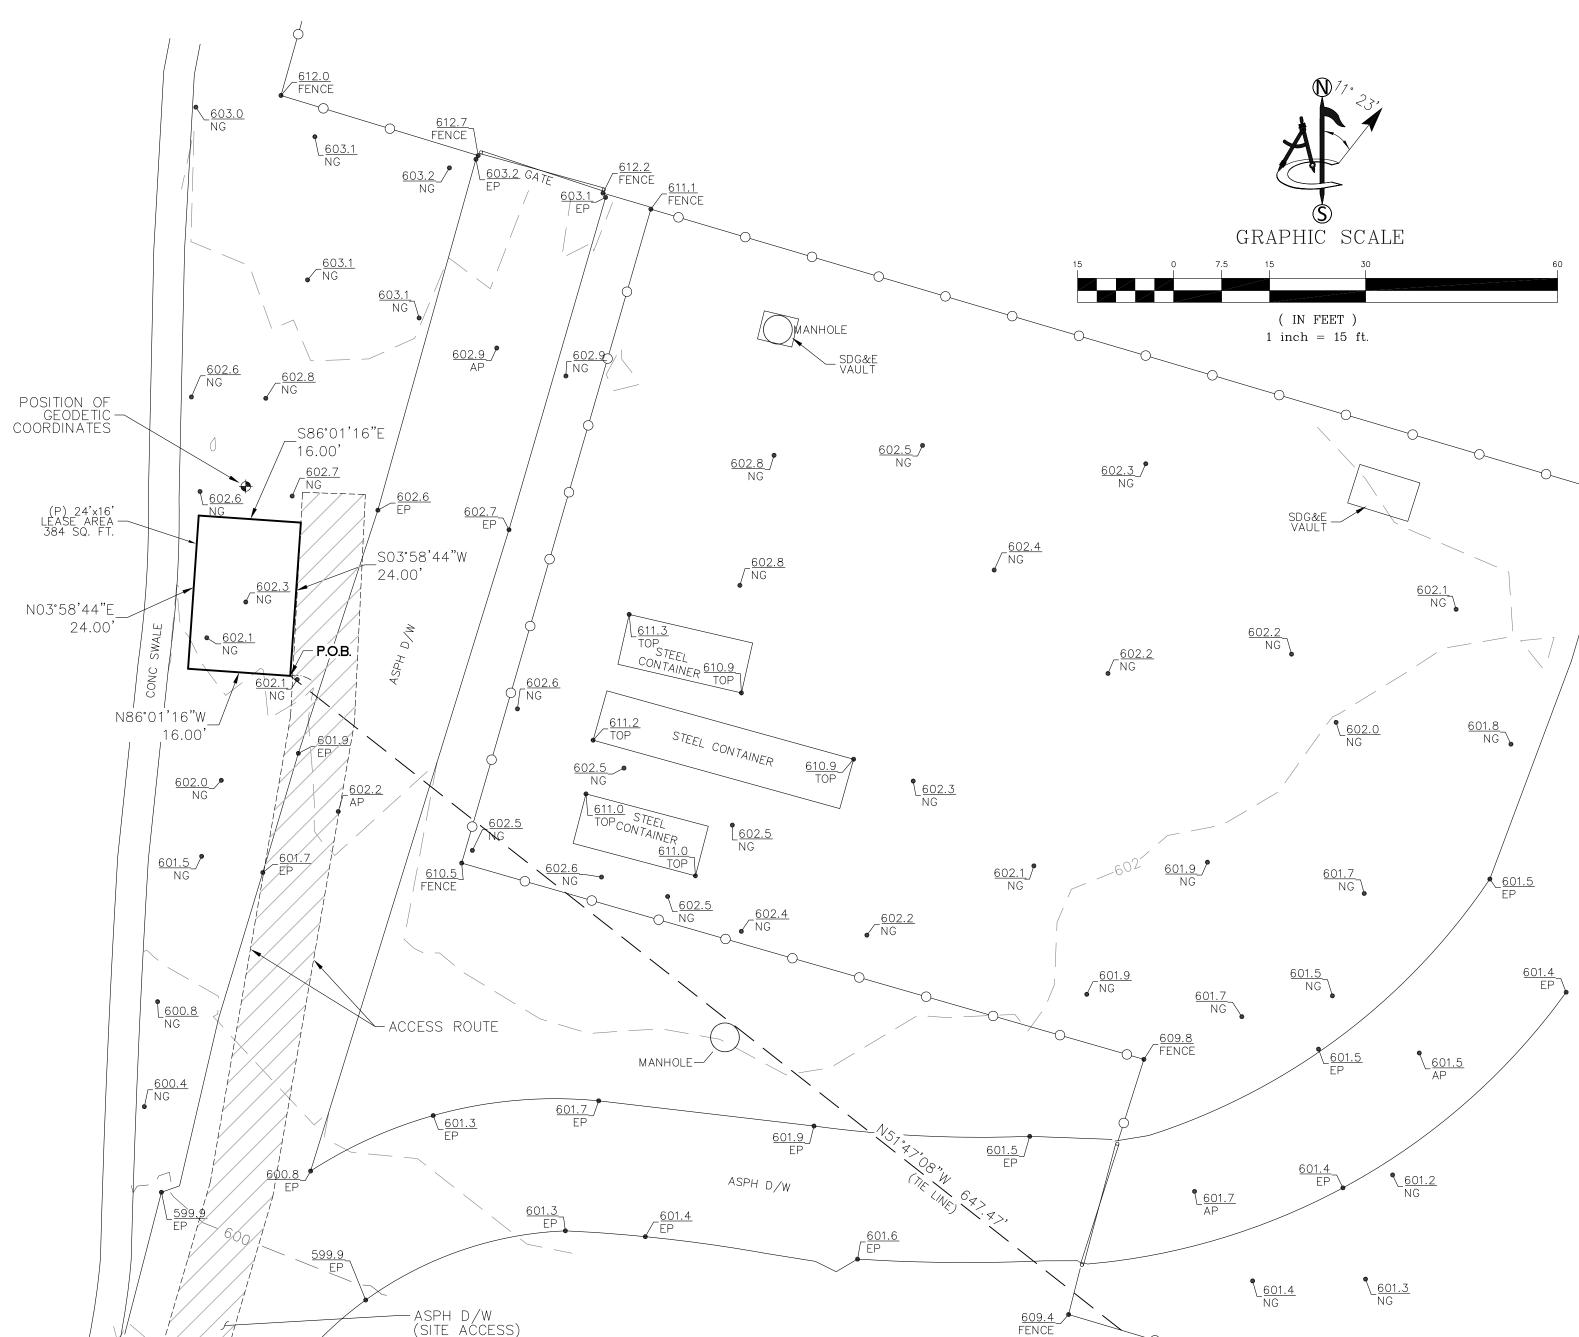

SCHEDULE "B" NOTE

REFERENCE IS MADE TO THE TITLE REPORT ORDER #92017581-920-CMM-CM8, ISSUED BY COMMONWEALTH LAND TITLE INSURANCE COMPANY, DATED MARCH 30, 2022. ALL EASEMENTS CONTAINED WITHIN SAID TITLE REPORT AFFECTING THE IMMEDIATE AREA SURROUNDING THE LEASE HAVE BEEN PLOTTED.

ITEMIZED NOTES:

- 1. WATER RIGHTS, CLAIMS OR TITLE TO WATER, WHETHER OR NOT DISCLOSED BY THE PUBLIC RECORDS. (NOTHING TO SHOW)
- 2. EASEMENT(S) FOR THE PURPOSE(S) SHOWN BELOW AND RIGHTS INCIDENTAL THERETO, AS GRANTED IN A DOCUMENT:
 GRANTED TO: THE COUNTY OF ORANGE
 PURPOSE: DITCHES AND/OR WATER RIGHTS TO THE SURFACE FLOW OF TRABUCO CREEK RECORDING DATE: MARCH 8, 1934
 RECORDING NO: BOOK 666, PAGE 27 OF OFFICIAL RECORDS

AFFECTS: A PORTION OF SAID LAND
THE EXACT LOCATION AND EXTENT OF SAID EASEMENT IS NOT DISCLOSED OF RECORD.
REFERENCE IS HEREBY MADE TO SAID DOCUMENT FOR FULL PARTICULARS.
(EXACT LOCATION INDETERMINATE — NOT SHOWN)

- 3. MATTERS CONTAINED IN THAT CERTAIN DOCUMENT ENTITLED: COMMON USE AGREEMENT DATED: JUNE 17 1985 EXECUTED BY: SAN DIEGO PIPELINE COMPANY AND SANTA MARGARITA WATER DISTRICT RECORDING DATE: FEBRUARY 5, 1988 RECORDING NO: 88-54228 OF OFFICIAL RECORDS REFERENCE IS HEREBY MADE TO SAID DOCUMENT FOR FULL PARTICULARS.
- 4. MATTERS CONTAINED IN THAT CERTAIN DOCUMENT ENTITLED: ACCEPTANCE DATED: FEBRUARY 5, 1990 EXECUTED BY: COUNTY OF ORANGE RECORDING DATE: AUGUST 7, 1990 RECORDING NO: 90-416328 OF OFFICIAL RECORDS REFERENCE IS HEREBY MADE TO SAID DOCUMENT FOR FULL PARTICULARS. (NOTHING TO SHOW)

(EXACT LOCATION INDETERMINATE - NOT SHOWN)

(EXACT LOCATION INDETERMINATE - NOT SHOWN)

(AS SHOWN ON SURVEY)

- 5. EASEMENT(S) FOR THE PURPOSE(S) SHOWN BELOW AND RIGHTS INCIDENTAL THERETO AS RESERVED IN A DOCUMENT; RESERVED BY: SANTA MARGARITA COMPANY PURPOSE: PURPOSES OF GRADING, EXCAVATING, CONSTRUCTING, MAINTAINING, REPAIRING, INSPECTING, LANDSCAPING, IRRIGATING AND RENEWING MANUFACTURED SLOPES ADJACENT TO ANTONIO PARKWAY, TOGETHER WITH THE INCIDENTAL RIGHTS TO ENTER UPON, PASS AND REPASS AND TO DEPOSIT TOOLS, IMPLEMENTS AND OTHER MATERIALS OVER AND ALONG THE SLOPE EASEMENT AREA IN CONNECTION WITH THE FOREGOING PURPOSES, PROVIDED, HOWEVER THAT GRANTOR SHALL OBTAIN PRIOR WRITTEN APPROVAL FROM GRANTEE FOR IMPROVEMENTS WITHIN SAID SLOPE EASEMENT AREA TO INSURE THAT GRANTOR'S IMPROVEMENTS DO NOT INTERFERE WITH OR ENDANGER GRANTEE'S USE AND ENJOYMENT OF SAID PROPERTY TOGETHER WITH THE RIGHT TO REVIEW AND COMMENT ON ALL MAJOR PROPOSED IMPROVEMENTS AND/OR LANDSCAPING TO BE CONSTRUCTED AND/OR PLANTED ON THE PROPERTY RECORDING DATE: DECEMBER 29, 1992 RECORDING NO: 92-886653 OF OFFICIAL RECORDS AFFECTS: A PORTION OF SAID LAND REFERENCE IS HEREBY MADE TO SAID DOCUMENT FOR FULL PARTICULARS.
- 6. AN UNRECORDED MORTGAGE AND DEED OF TRUST, EXECUTED BY SAN DIEGO GAS AND ELECTRIC COMPANY TO THE BANK OF CALIFORNIA, NATIONAL ASSOCIATION (NOW BANKERS TRUST COMPANY OF CALIFORNIA), AS TRUSTEE, DATED JULY 1, 1940 AND ENTERED INTO AS OF DECEMBER 21, 1992, TO SECURE PAYMENT OF ALL BONDS OF THE SAN DIEGO GAS AND ELECTRIC COMPANY AT ANY TIME OUTSTANDING THEREUNDER, SUBJECT TO THE SAME TERMS AND CONDITIONS CONTAINED IN THAT CERTAIN MORTGAGE AND DEED OF TRUST FROM SAN DIEGO GAS AND ELECTRIC COMPANY TO THE BANK OF CALIFORNIA, NATIONAL ASSOCIATION, AS TRUSTEE, DATED JULY 1, 1940 AND RECORDED OCTOBER 10, 1940 IN BOOK 1087, PAGE 1 OF OFFICIAL RECORDS OF SAN DIEGO COUNTY, CALIFORNIA, TOGETHER WITH ALL SUPPLEMENTS THERETO.

DISCLOSED BY A MEMORANDUM OF MORTGAGE RECORDED DECEMBER 31, 1992 AS INSTRUMENT NO. 92-898721 OF OFFICIAL RECORDS.
REFERENCE IS HEREBY MADE TO SAID DOCUMENT FOR FULL PARTICULARS.
(NOTHING TO SHOW)

- (7.) EASEMENT(S) FOR THE PURPOSE(S) SHOWN BELOW AND RIGHTS INCIDENTAL THERETO, AS GRANTED IN A DOCUMENT:
 GRANTED TO: SAN DIEGO GAS AND ELECTRIC COMPANY, A CORPORATION PURPOSE: TRANSMISSION AND DISTRIBUTION OF ELECTRICITY AND TELEPHONE, SIGNAL AND COMMUNICATION AND ALL OTHER PURPOSES RECORDING DATE: FEBRUARY 10, 1993
 RECORDING NO: 93-91210 OF OFFICIAL RECORDS AFFECTS: A PORTION OF SAID LAND AFFECTS: THE HEREIN DESCRIBED LAND AND OTHER LAND.
- 8. EASEMENT(S) FOR THE PURPOSE(S) SHOWN BELOW AND RIGHTS INCIDENTAL THERETO, AS GRANTED IN A DOCUMENT:
 GRANTED TO: SAN DIEGO GAS AND ELECTRIC COMPANY, A CORPORATION PURPOSE: TRANSMISSION AND DISTRIBUTION OF ELECTRICITY AND TELEPHONE, SIGNAL AND COMMUNICATION AND ALL OTHER PURPOSES RECORDING DATE: FEBRUARY 10, 1993
 RECORDING NO: 93-91214 OF OFFICIAL RECORDS AFFECTS: A PORTION OF SAID LAND AFFECTS: THE HEREIN DESCRIBED LAND AND OTHER LAND.
 (DOES NOT AFFECT PARENT PARCEL NOT SHOWN)

9. EASEMENT(S) FOR THE PURPOSE(S) SHOWN BELOW AND RIGHTS INCIDENTAL THERETO, AS GRANTED IN A DOCUMENT:

GRANTED TO: SAN DIEGO GAS AND ELECTRIC COMPANY
PURPOSE: RECONSTRUCT, USE, MAINTAIN AND REPAIR ANY EXISTING ROADWAYS;
AND/OR INSTALL, PLACE, LAY, CONSTRUCT, OPERATE, USE, PATROL, MAINTAIN, GRADE,
REPAIR, REPLACE AND
RECONSTRUCT ADDITIONAL ROADWAYS

RECONSTRUCT ADDITIONAL ROADWAYS
RECORDING DATE: JULY 7, 1994
RECORDING NO: 94-443053 OF OFFICIAL RECORDS
AFFECTS: A PORTION OF SAID LAND

AFFECTS: THE HEREIN DESCRIBED LAND AND OTHER LAND. (DOES NOT AFFECT PARENT PARCEL — NOT SHOWN)

10. MATTERS CONTAINED IN THAT CERTAIN DOCUMENT ENTITLED: JOINT USE AGREEMENT DATED: MARCH 16, 1993 EXECUTED BY: SANTA FE PACIFIC PARTNERS, L.P., AND SAN DIEGO GAS AND ELECTRIC COMPANY, A CORPORATION

RECORDING DATE: MARCH 26, 1993
RECORDING NO: 93- 185764 OF OFFICIAL RECORDS
REFERENCE IS HEREBY MADE TO SAID DOCUMENT FOR FULL PARTICULARS.
AFFECTS: THE HEREIN DESCRIBED LAND AND OTHER LAND.

AND RE-RECORDING DATE: JULY 27, 1995
AND RE-RECORDING NO: 95-321260 OF OFFICIAL RECORDS
(EXACT LOCATION INDETERMINATE - NOT SHOWN)

(AS SHOWN ON SURVEY)

EASEMENT(S) FOR THE PURPOSE(S) SHOWN BELOW AND RIGHTS INCIDENTAL THERETO, AS GRANTED IN A DOCUMENT:

GRANTED TO: COUNTY OF ORANGE
PURPOSE: DRAINAGE
RECORDING DATE: JULY 12, 1999
RECORDING NO: 99-513547 OF OFFICIAL RECORDS
AFFECTS: A PORTION OF SAID LAND
REFERENCE IS HEREBY MADE TO SAID DOCUMENT FOR FULL PARTICULARS.

- 12. THE FACT THAT THE PUBLIC RECORD DOES NOT DISCLOSE THAT THE OWNERSHIP OF SAID LAND INCLUDES RIGHTS OF ACCESS TO OR FROM ANY PUBLIC STREET, NOTWITHSTANDING THE INSURING CLAUSES OF THE POLICY, THE COMPANY DOES NOT INSURE AGAINST LOSS OR DAMAGE BY REASON OF A LACK OF A RIGHT OF ACCESS TO AND FROM THE LAND.

 (NOTHING TO SHOW)
- 13. INFORMATION IN POSSESSION OF THE COMPANY INDICATES THAT A DIVISION OF LAND, AS DEFINED IN GOVERNMENT CODE SECTION 66424, IS CONTEMPLATED IN THE CURRENT TRANSACTION INVOLVING THE LAND DESCRIBED IN THIS REPORT. SUCH CONTEMPLATED DIVISION OF LAND WOULD APPEAR TO FALL WITHIN THE PURVIEW OF THE SUBDIVISION MAP ACT (COMMENCING WITH GOVERNMENT CODE SECTION 66410), AND AS A PREREQUISITE TO THE ISSUANCE OF ANY TITLE ASSURANCE UNDER THIS APPLICATION, AT LEAST ONE OF THE FOLLOWING REQUIREMENTS MUST BE ACCOMPLISHED TO THIS COMPANY'S SATISFACTION:
- (a) THAT A FINAL (TRACT) MAP HAS BEEN RECORDED IN COMPLIANCE WITH THE SUBDIVISION MAP ACT AND RELATED ORDINANCES;
- (b) THAT A PARCEL MAP HAS BEEN RECORDED IN COMPLIANCE WITH THE SUBDIVISION MAP ACT AND RELATED ORDINANCES;
- (c) THAT A CERTIFICATE OF COMPLIANCE AS PROVIDED FOR IN THE SUBDIVISION MAP ACT HAS BEEN RECORDED, OR WILL BE RECORDED THROUGH THIS APPLICATION.(d) OTHER EVIDENCE, SATISFACTORY TO THIS COMPANY, INDICATING COMPLIANCE OR NONVIOLATION MUST BE FURNISHED.(NOTHING TO SHOW)
- 14. PLEASE BE ADVISED THAT OUR SEARCH DID NOT DISCLOSE ANY OPEN DEEDS OF TRUST OF RECORD. IF YOU SHOULD HAVE KNOWLEDGE OF ANY OUTSTANDING OBLIGATION, PLEASE CONTACT THE TITLE DEPARTMENT IMMEDIATELY FOR FURTHER REVIEW PRIOR TO CLOSING.

 (NOTHING TO SHOW)
- 15. ANY RIGHTS OF THE PARTIES IN POSSESSION OF A PORTION OF, OR ALL OF, SAID LAND, WHICH RIGHTS ARE NOT DISCLOSED BY THE PUBLIC RECORDS. THE COMPANY WILL REQUIRE, FOR REVIEW, A FULL AND COMPLETE COPY OF ANY UNRECORDED AGREEMENT, CONTRACT, LICENSE AND/OR LEASE, TOGETHER WITH ALL SUPPLEMENTS, ASSIGNMENTS AND AMENDMENTS THERETO, BEFORE ISSUING ANY POLICY OF TITLE INSURANCE WITHOUT EXCEPTING THIS ITEM FROM COVERAGE. THE COMPANY RESERVES THE RIGHT TO EXCEPT ADDITIONAL ITEMS AND/OR MAKE ADDITIONAL REQUIREMENTS AFTER REVIEWING SAID DOCUMENTS. (NOTHING TO SHOW)

LESSOR'S LEGAL DESCRIPTION

THE LAND REFERRED TO HEREIN BELOW IS SITUATED LADERA RANCH, IN THE COUNTY OF ORANGE, STATE OF CALIFORNIA, AND IS DESCRIBED AS FOLLOWS:

ALL THAT CERTAIN REAL PROPERTY SITUATED IN THE CITY OF LADERA RANCH, COUNTY OF ORANGE, STATE OF CALIFORNIA, DESCRIBED AS FOLLOWS:

THAT CERTAIN PORTION OF PARCEL 2 AS SHOWN ON AND DESCRIBED IN CERTIFICATE OF COMPLIANCE NO. 82-2 RECORDED SEPTEMBER 3, 1982 AS INSTRUMENT NO. 82-313505 OF OFFICIAL RECORDS OF IN THE CITY OF LADERA RANCH, COUNTY OF ORANGE, STATE OF CALIFORNIA, BEING A PORTION OF THE EAST HALF OF SECTION 20, TOWNSHIP 7 SOUTH, RANGE 7 WEST, LYING WITHIN RANCHO MISSION VIEJO OR LA PAZ, AS SHOWN ON A RECORD OF SURVEY SECTIONING SAID RANCHO MISSION VIEJO OR LA PAZ RECORDED IN BOOK 9, PAGES 15 THROUGH 22 INCLUSIVE OF RECORD OF SURVEYS IN THE OFFICE OF THE COUNTY RECORDER OF SAID COUNTY, DESCRIBED AS FOLLOWS:

COMMENCING AT A FOUND 2 INCH PIPE SET FORTH IN THE SECTION CORNER COMMON TO SECTIONS 16, 17, 20 AND 21 OF SAID TOWNSHIP 7 SOUTH, RANGE 7 WEST SAID CORNER IS SHOWN ON SAID RECORD OF SURVEY RECORDED IN BOOK 9, PAGES 15 THROUGH 22, INCLUSIVE; SAID CORNER ALSO BEARS NORTH 89° 15' 03" WEST, 5,220.08FEET (RECORD NORTH 89° 58' 00" WEST, 5,222.67FEET) FROM A FOUND 2 INCH PIPE SET FORTH THE SECTION CORNER COMMON TO SECTIONS 15, 16, 21 AND 22 OF SAID TOWNSHIP 7 SOUTH, RANGE 7 WEST; THENCE FROM SAID COMMON SECTION CORNER SOUTH 13° 40' 00" WEST, A DISTANCE OF 1,941.95 FEET TO THE TRUE POINT OF BEGINNING OF THE PARCEL OF LAND HEREIN DESCRIBED; THENCE FROM SAID TRUE POINT OF BEGINNING SOUTH 16° 33' 55" WEST, A DISTANCE OF 911.18 FEET; THENCE NORTH 73° 26' 05" WEST, A DISTANCE OF 1,043.43 FEET; THENCE SOUTH 63° 26' 05" EAST, A DISTANCE OF 761.58 FEET TO THE TRUE POINT OF BEGINNING.



1452 EDINGER AVENUE 3RD FLOOR TUSTIN, CA 92780




428 MAIN STREET
SUITE 206
HUNTINGTON BEACH, CA 92648
PH. (480) 659-4072
www.ambitconsulting.us

ambit consulting



| 1 | 12/05/22 | TITLE/DESIGN | (SM) |
|-----|----------|--------------|------|
| А | 09/26/22 | PRELIMINARY | (RR) |
| REV | DATE | DESCRIPTION | |

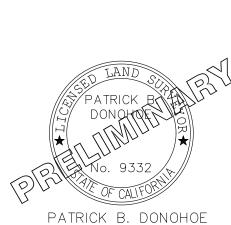

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P.L.S. NO. 9332

CLL01430


AVENDALE BOULEVARD &
ANTONIO PARKWAY


LADERA RANCH, CA, 92694


SHEET TITLE NOTES

SHEET NUMBER

S — 7

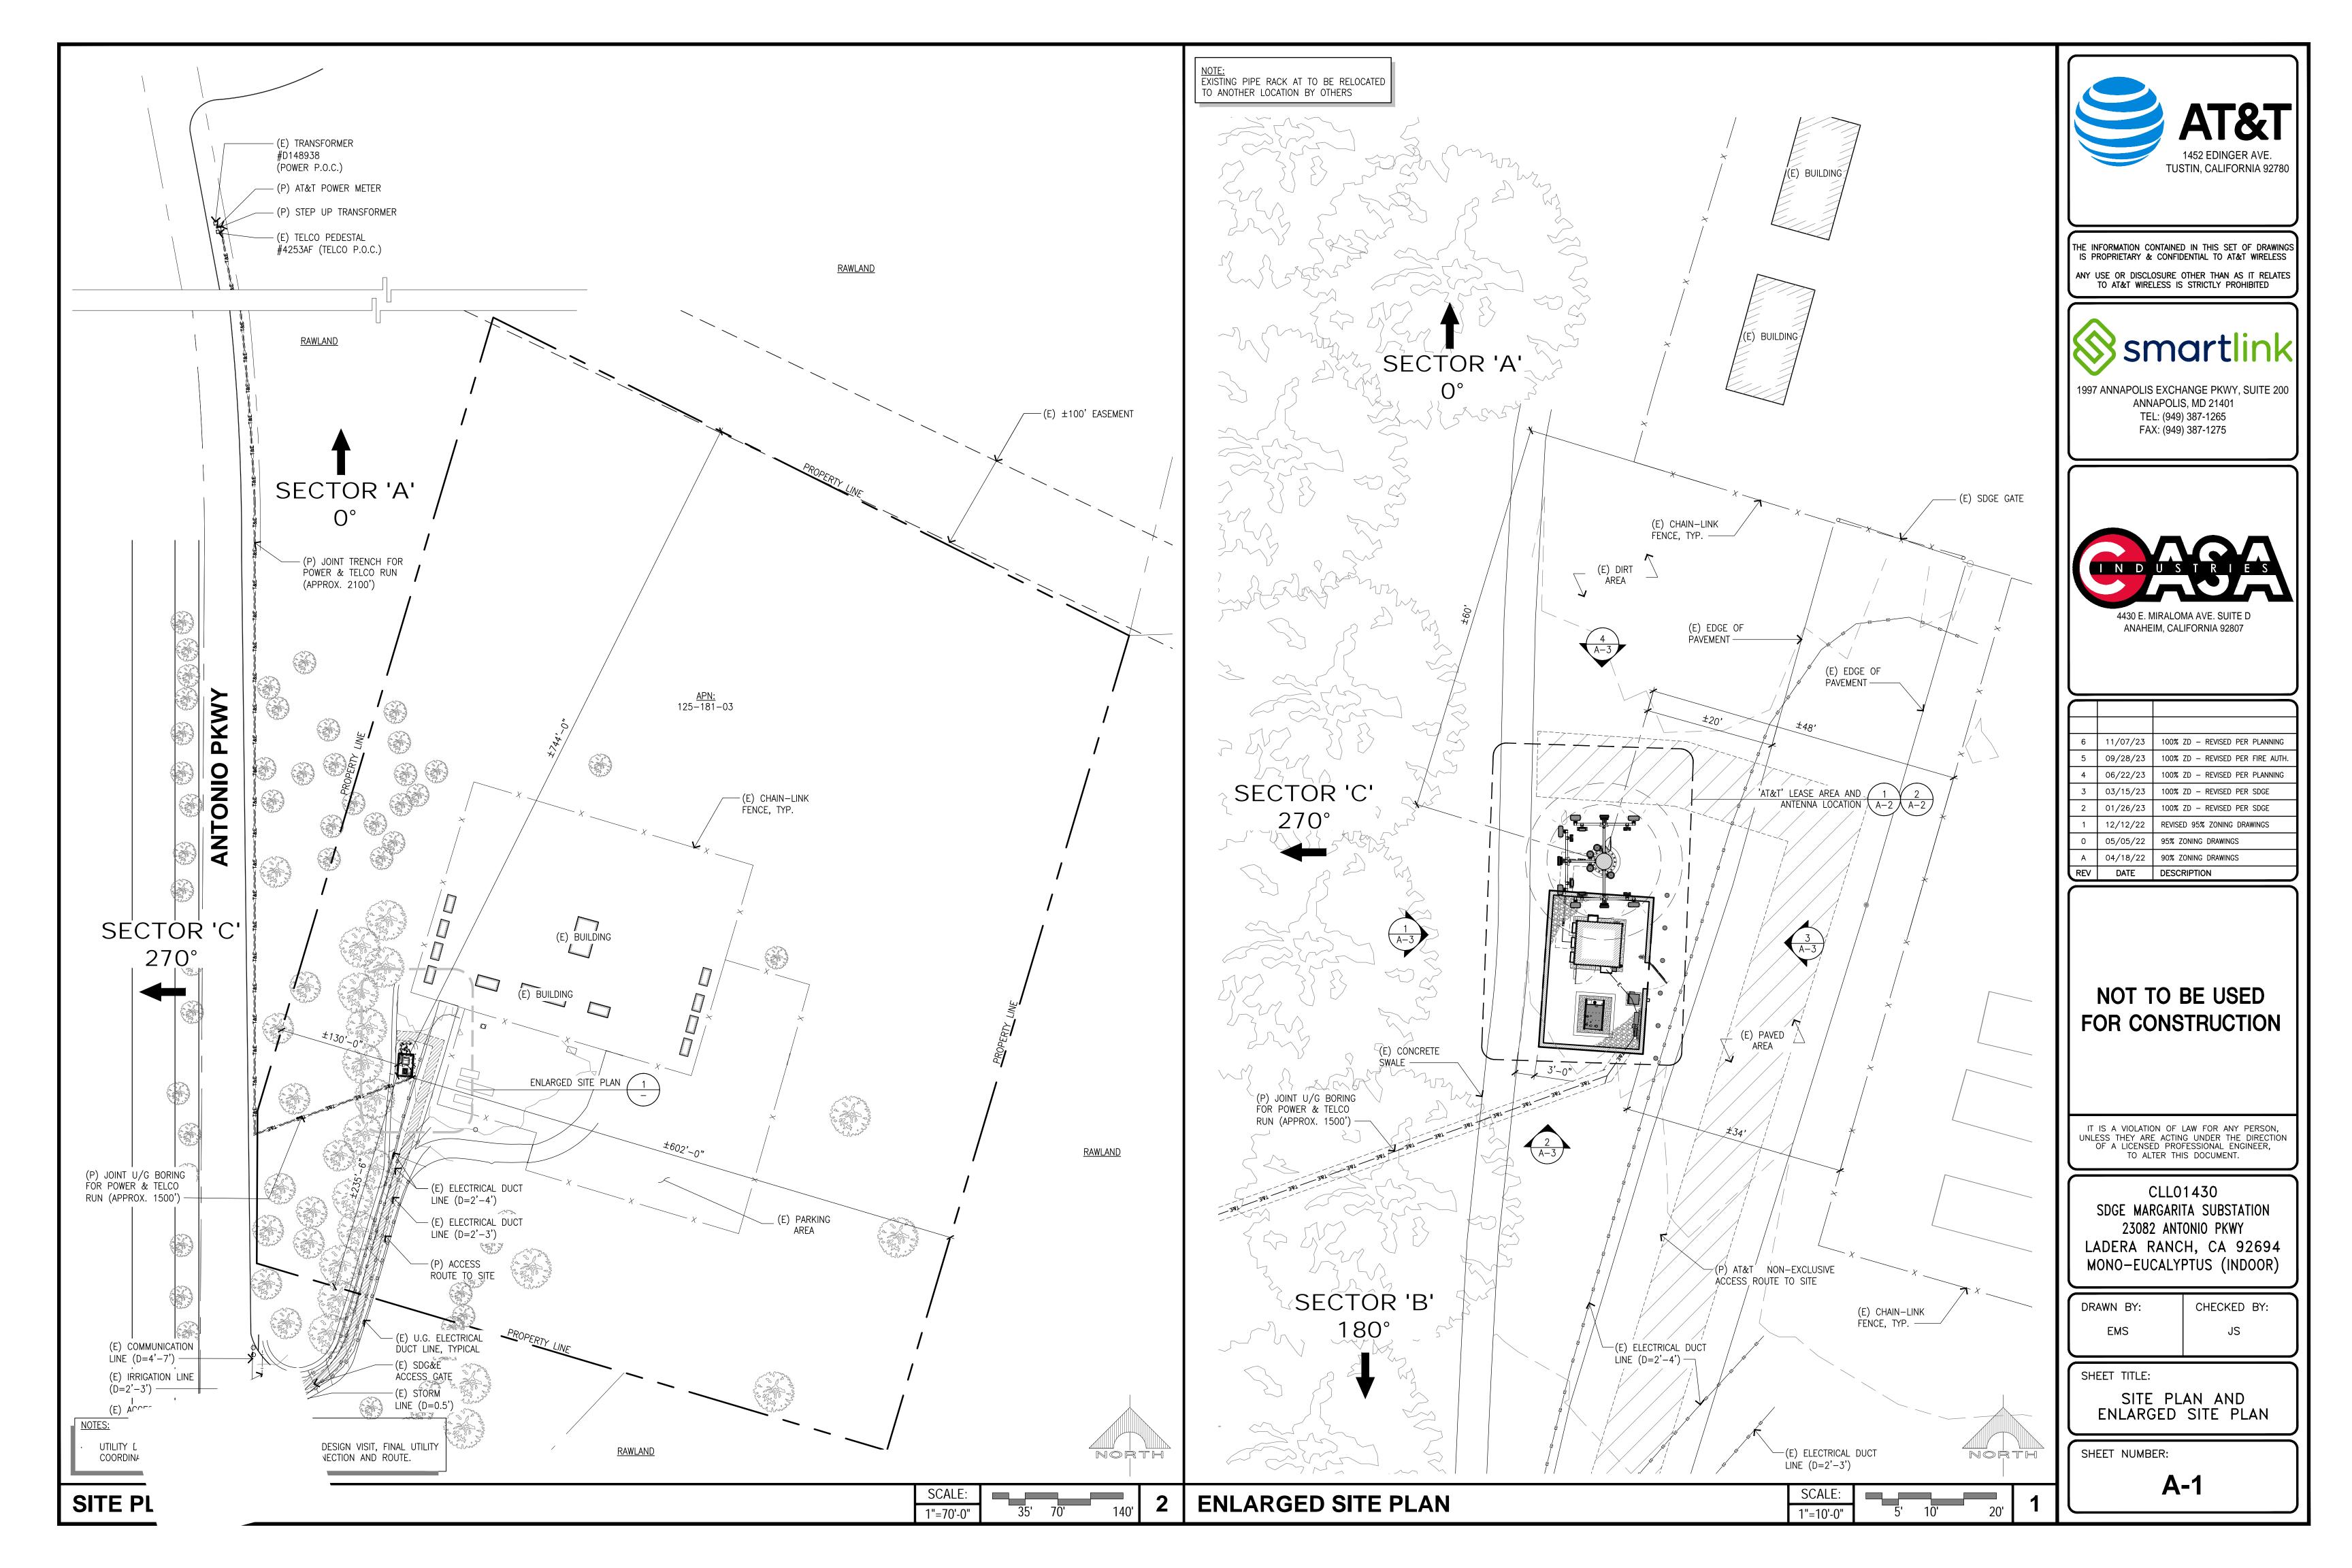

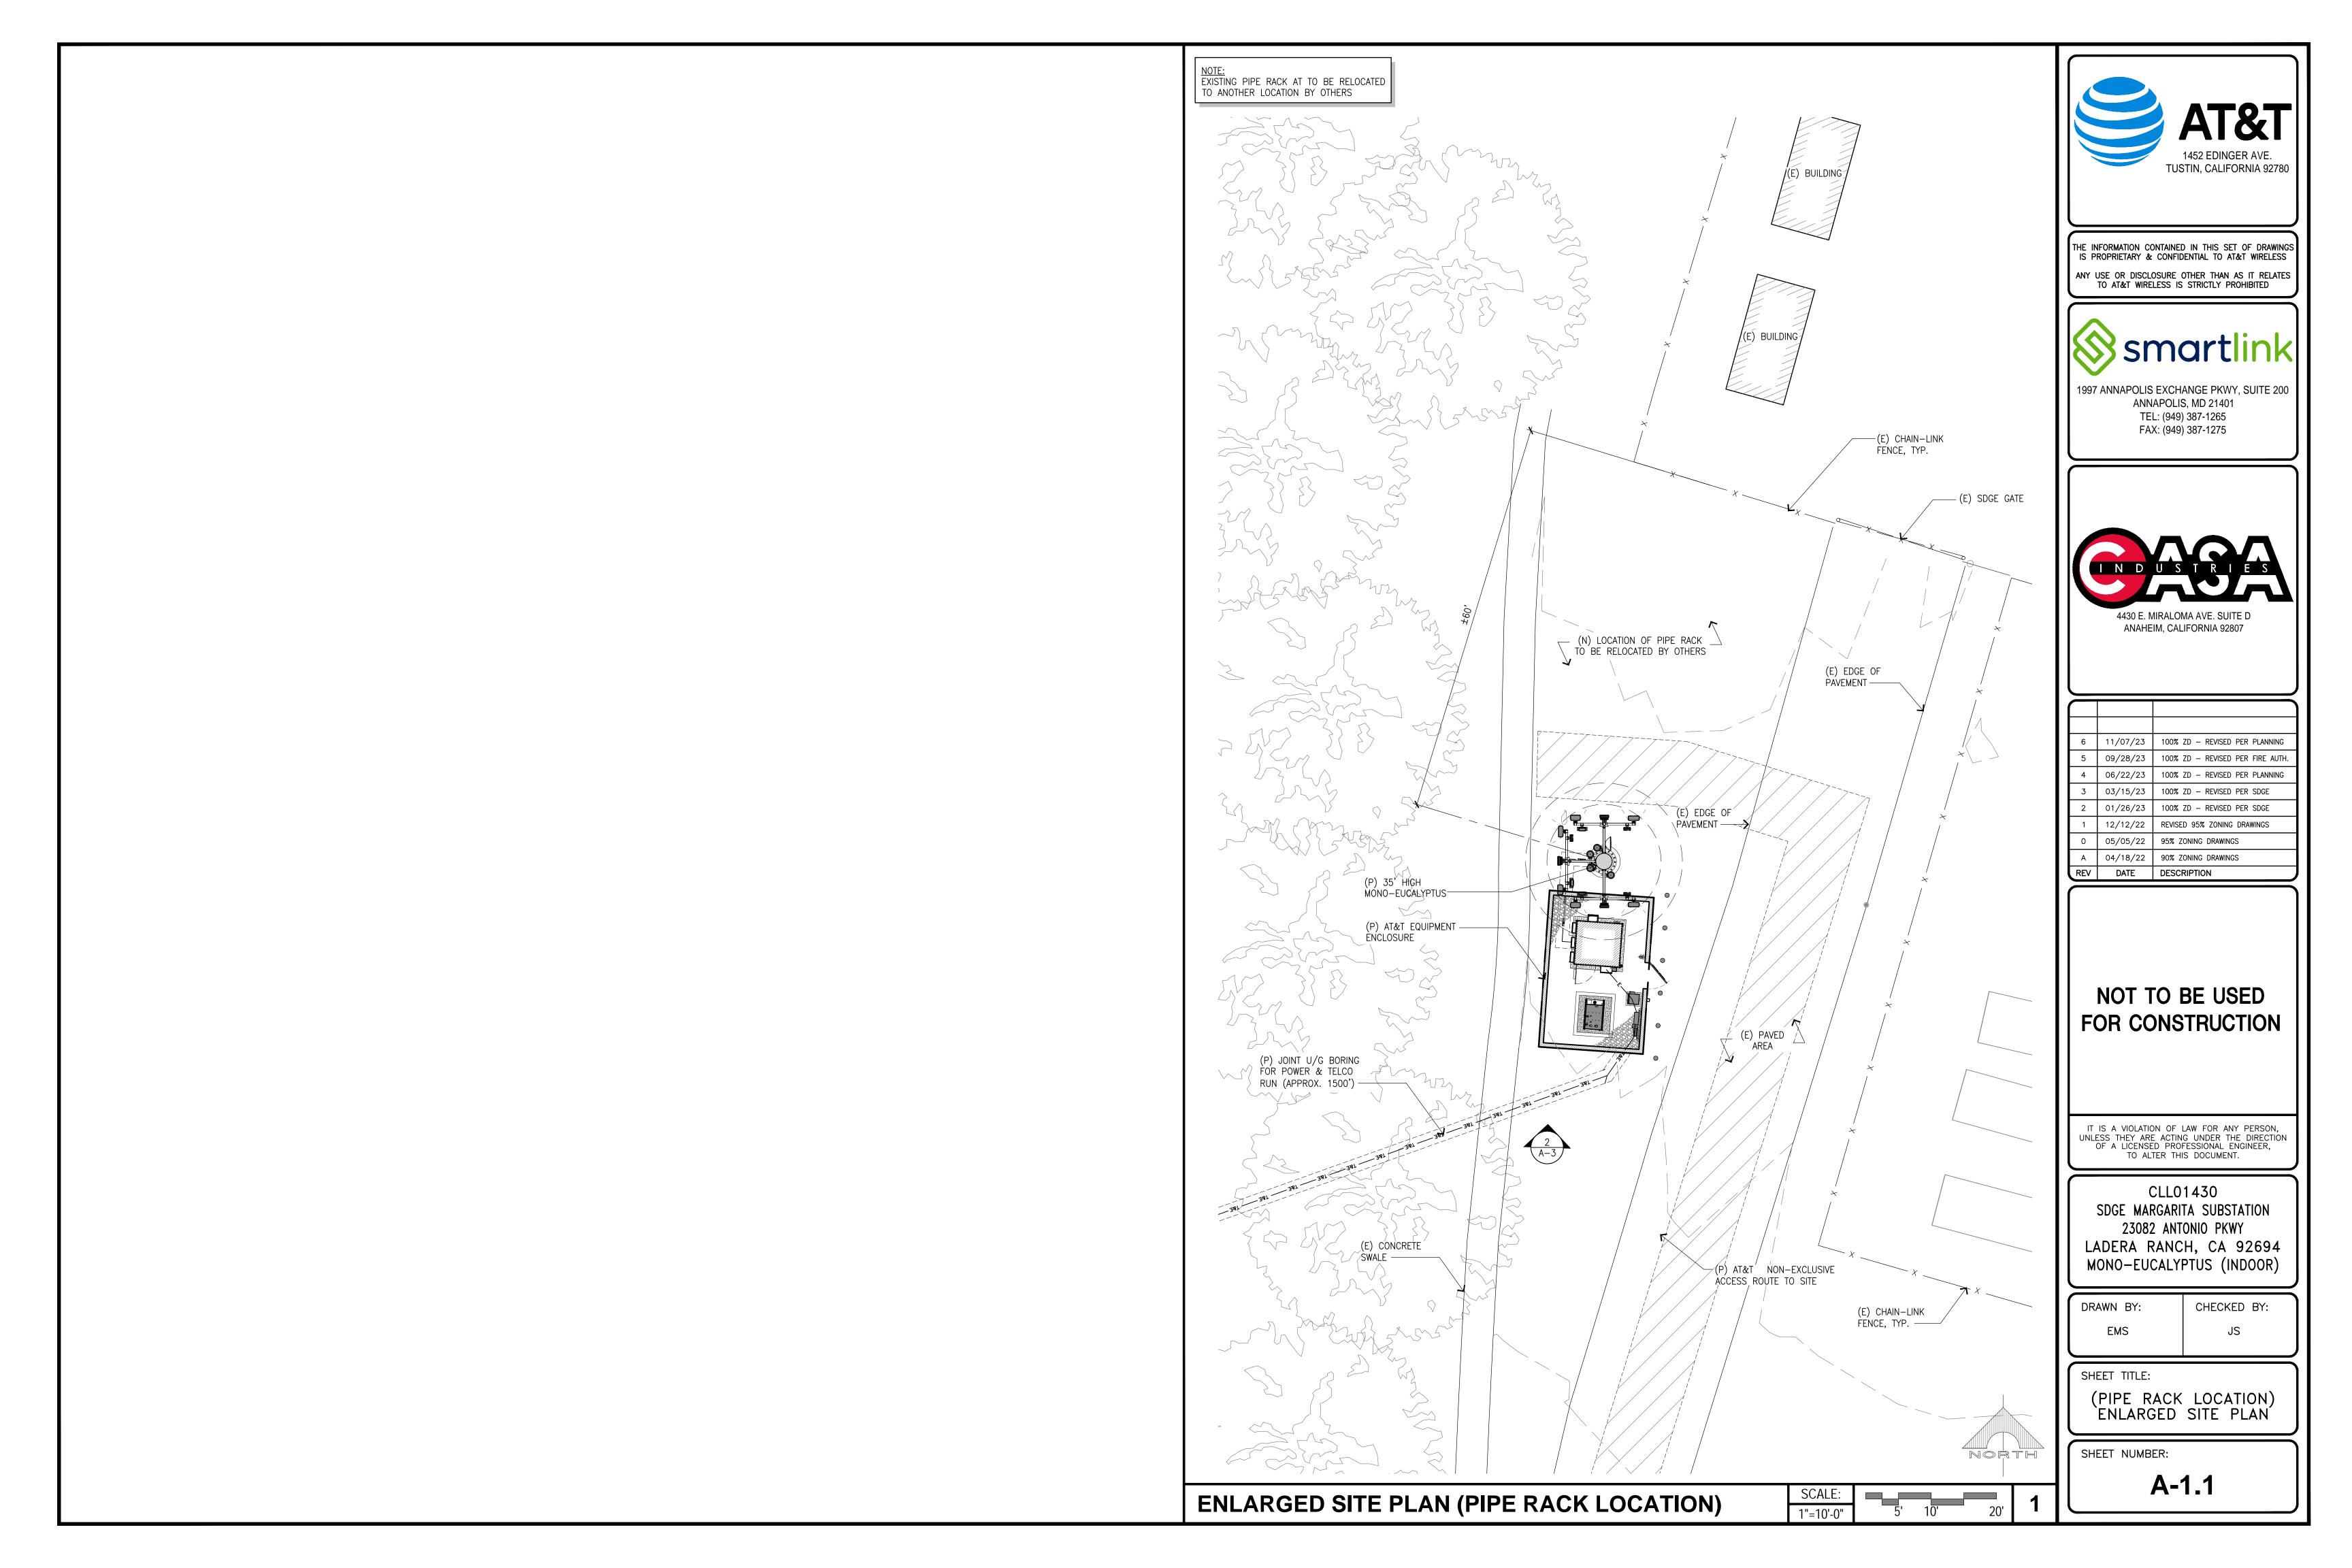

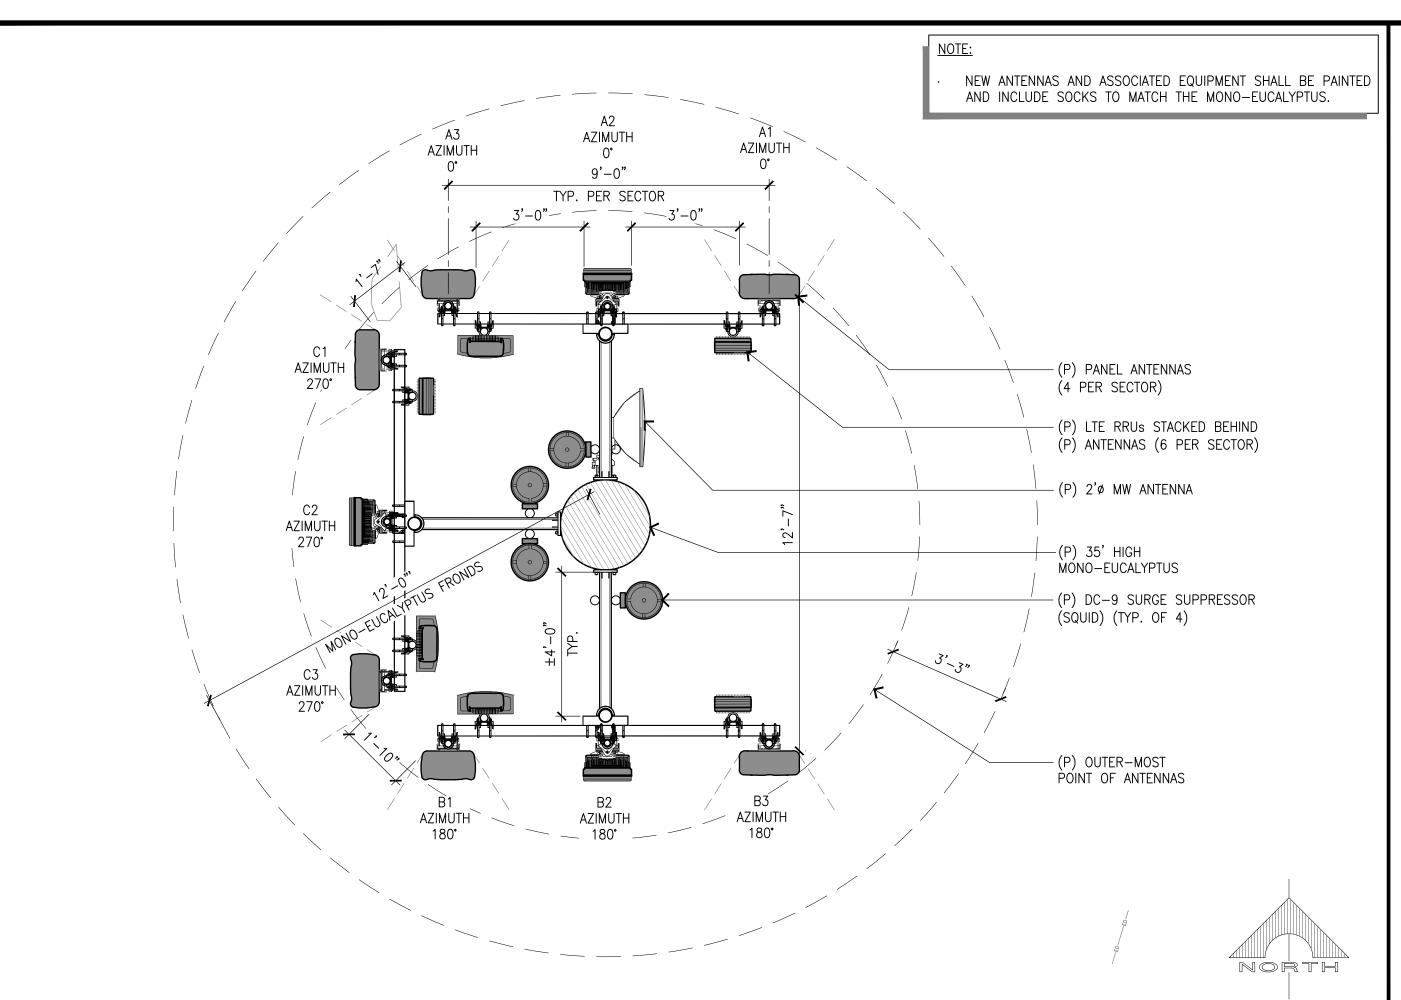

ANTENNA PLAN

SCALE:

3/8"=1'-0"


2

| | PROPOSED ANTENNA AND TRANSMISSION CABLE REQUIREMENTS | | | | | | | |
|----------|--|------------------------------------|-----------------------------|-------------------|---------|---------|------------------------------------|-------------------|
| CEC. |)TOD | PROPOSED | ANTENNA | | ANTENNA | RAD | TRANSMISSION LINES (LENGTH FT +/-) | |
| SEC | CTOR | TECHNOLOGY | AIR/HEX/8-PORT | SIZE (4'; 6'; 8') | AZIMUTH | CENTER | JUMPER | DC CABLE (AWG #6) |
| | A1 | LTE | COMMSCOPE NNH4-65C-R6-V3 | 8' | 0° | 30'-0" | <12' | +/- 60' |
| SECTOR | 40 | LTE | ERICSSON AIR6449 N77D | 2'-7" | 0° | 32'-8" | <12' | +/- 60' |
| | A2 | LTE | ERICSSON AIR6419 N77G | 2'-4" | 0° | 29'-1" | <12' | +/- 60' |
| ALPHA | A3 | OLINTEL | | 8' | 0° | 30'-0" | <12' | +/- 60' |
| | B1 | B1 LTE QUINTEL QD8612-7 | | 8' | 180° | 30'-0" | <12' | +/- 60' |
| SECTOR | LTE | | ERICSSON AIR6449 N77D | 2'-7" | 180° | 32'-8" | <12' | +/- 60' |
| BETA § | B2 | LTE ERICSSON 2'-4" | | 2'-4" | 180° | 29'-1" | <12' | +/- 60' |
| <u> </u> | В3 | COMMSCOPE | | 180° | 30'-0" | <12' | +/- 60' | |
| | C1 | C1 LTE COMMSCOPE NNH4-65C-R6-V3 8' | | 8' | 270° | 30'-0" | <12' | +/- 60' |
| SECTOR | STOR | LTE | ERICSSON AIR6449 N77D | 2'-7" | 270° | 32'-8" | <12' | +/- 60' |
| | C2 | LTE | ERICSSON AIR6419 N77G | 2'-4" | 270° | 29'-1" | <12' | +/- 60' |
| САММА | C3 LTE QUINTEL 8' | | 270° | 30'-0" | <12' | +/- 60' | | |

| | REMOTE RADIO UNITS (RRU'S) | | | | | | | | |
|-----------------|----------------------------|----------------|-----------|-------------------------|-------|--------------------|-------|--|--|
| 252725 | | | DDU GOUNT | RRU LOCATION | MINIM | MINIMUM CLEARANCES | | | |
| SEC | TOR | RRU UP OR DOWN | RRU COUNT | (DISTANCE FROM ANTENNA) | ABOVE | BELOW | SIDES | | |
| - 00 | A1 | UP | 3 | <12' | 18" | 8" | 8" | | |
| ALPHA SECTOR | A2 | UP | - | - | - | _ | _ | | |
| S | A3 | UP | 3 | <12' | 18" | 8" | 8" | | |
| ~ | B1 | UP | 3 | <12' | 18" | 8" | 8" | | |
| BETA SECTOR | B2 | UP | - | - | _ | _ | _ | | |
| | В3 | UP | 3 | <12' | 18" | 8" | 8" | | |
| - ~ | C1 | UP | 3 | <12' | 18" | 8" | 8" | | |
| GAMMA SECTOR | C2 | UP | _ | - | _ | _ | _ | | |
| | С3 | UP | 3 | <12' | 18" | 8" | 8" | | |

FIRE DEPARTMENT NOTES:

OCFA INSPECTION REQUIRED, SCHEDULE AT LEAST 2 DAYS IN ADVANCE, @ 714-573-6150. A CFC PERMIT IS REQUIRED FOR ABOVEGROUND TANKS USED FOR THE STORAGE OF COMBUSTIBLE LIQUIDS. THIS PERMIT WILL BE ISSUED BY AN OCFA INSPECTOR. AREAS SHALL BE KEPT FREE OF WEEDS AND COMBUSTIBLE

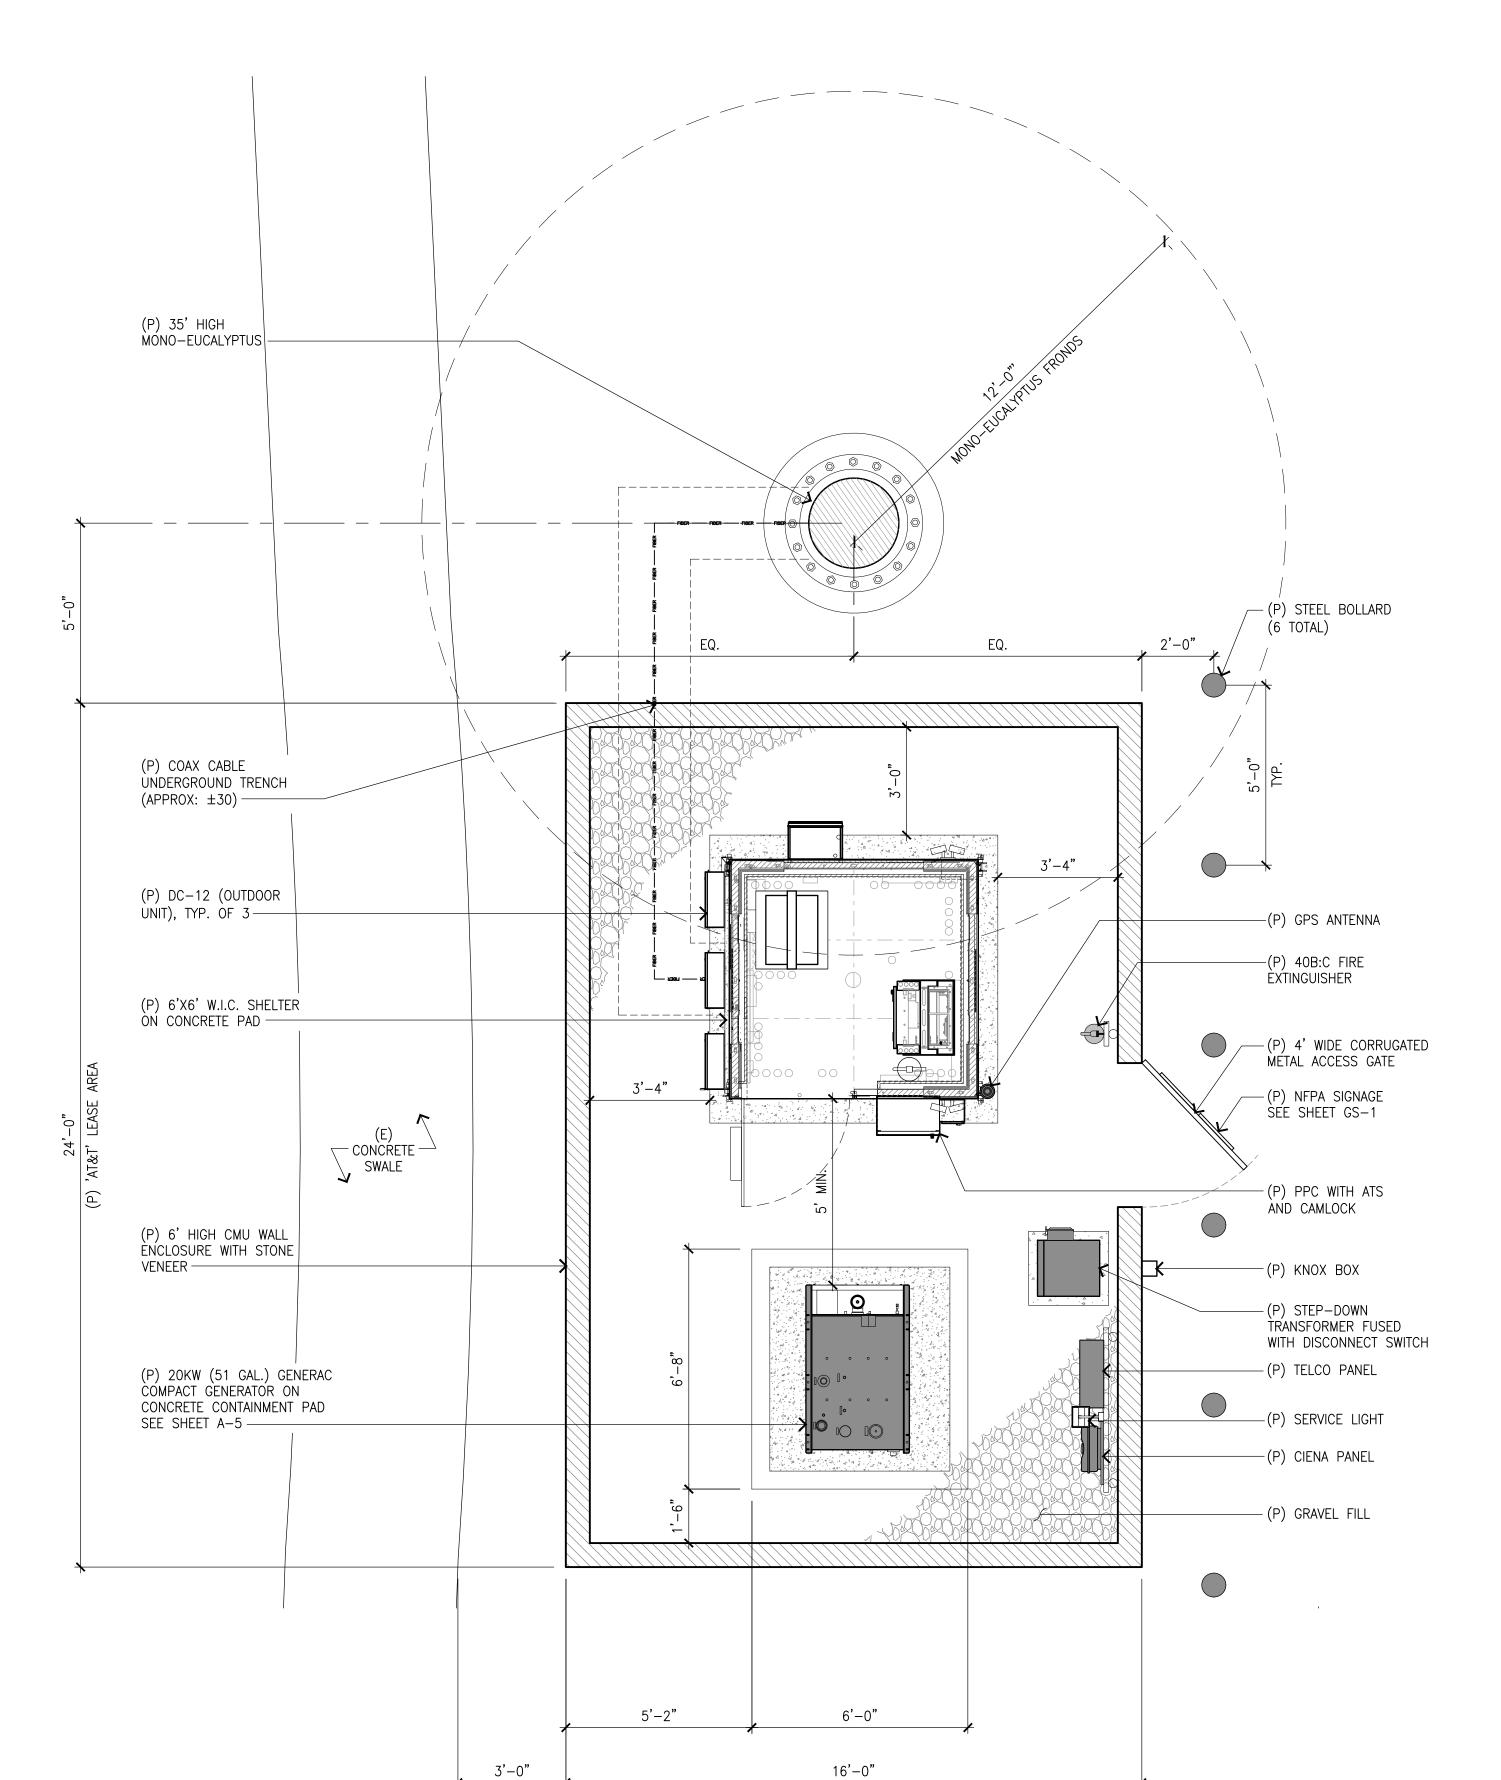

(P) 'AT&T' LEASE AREA



THE INFORMATION CONTAINED IN THIS SET OF DRAWINGS IS PROPRIETARY & CONFIDENTIAL TO AT&T WIRELESS

ANY USE OR DISCLOSURE OTHER THAN AS IT RELATES TO AT&T WIRELESS IS STRICTLY PROHIBITED



1997 ANNAPOLIS EXCHANGE PKWY, SUITE 200 ANNAPOLIS, MD 21401 TEL: (949) 387-1265 FAX: (949) 387-1275



| 6 | 11/07/23 | 100% ZD - REVISED PER PLANNING |
|-----|----------|----------------------------------|
| 5 | 09/28/23 | 100% ZD - REVISED PER FIRE AUTH. |
| 4 | 06/22/23 | 100% ZD - REVISED PER PLANNING |
| 3 | 03/15/23 | 100% ZD - REVISED PER SDGE |
| 2 | 01/26/23 | 100% ZD - REVISED PER SDGE |
| 1 | 12/12/22 | REVISED 95% ZONING DRAWINGS |
| 0 | 05/05/22 | 95% ZONING DRAWINGS |
| Α | 04/18/22 | 90% ZONING DRAWINGS |
| REV | DATE | DESCRIPTION |

NOT TO BE USED FOR CONSTRUCTION

IT IS A VIOLATION OF LAW FOR ANY PERSON, UNLESS THEY ARE ACTING UNDER THE DIRECTION OF A LICENSED PROFESSIONAL ENGINEER, TO ALTER THIS DOCUMENT.

CLL01430
SDGE MARGARITA SUBSTATION
23082 ANTONIO PKWY
LADERA RANCH, CA 92694
MONO-EUCALYPTUS (INDOOR)

| DRAWN BY: | CHECKED BY: |
|-----------|-------------|
| EMS | JS |

SHEET TITLE:

SHELTER AREA/ANTENNA PLAN AND ANTENNA/RRU SCHEDULE

SHEET NUMBER:


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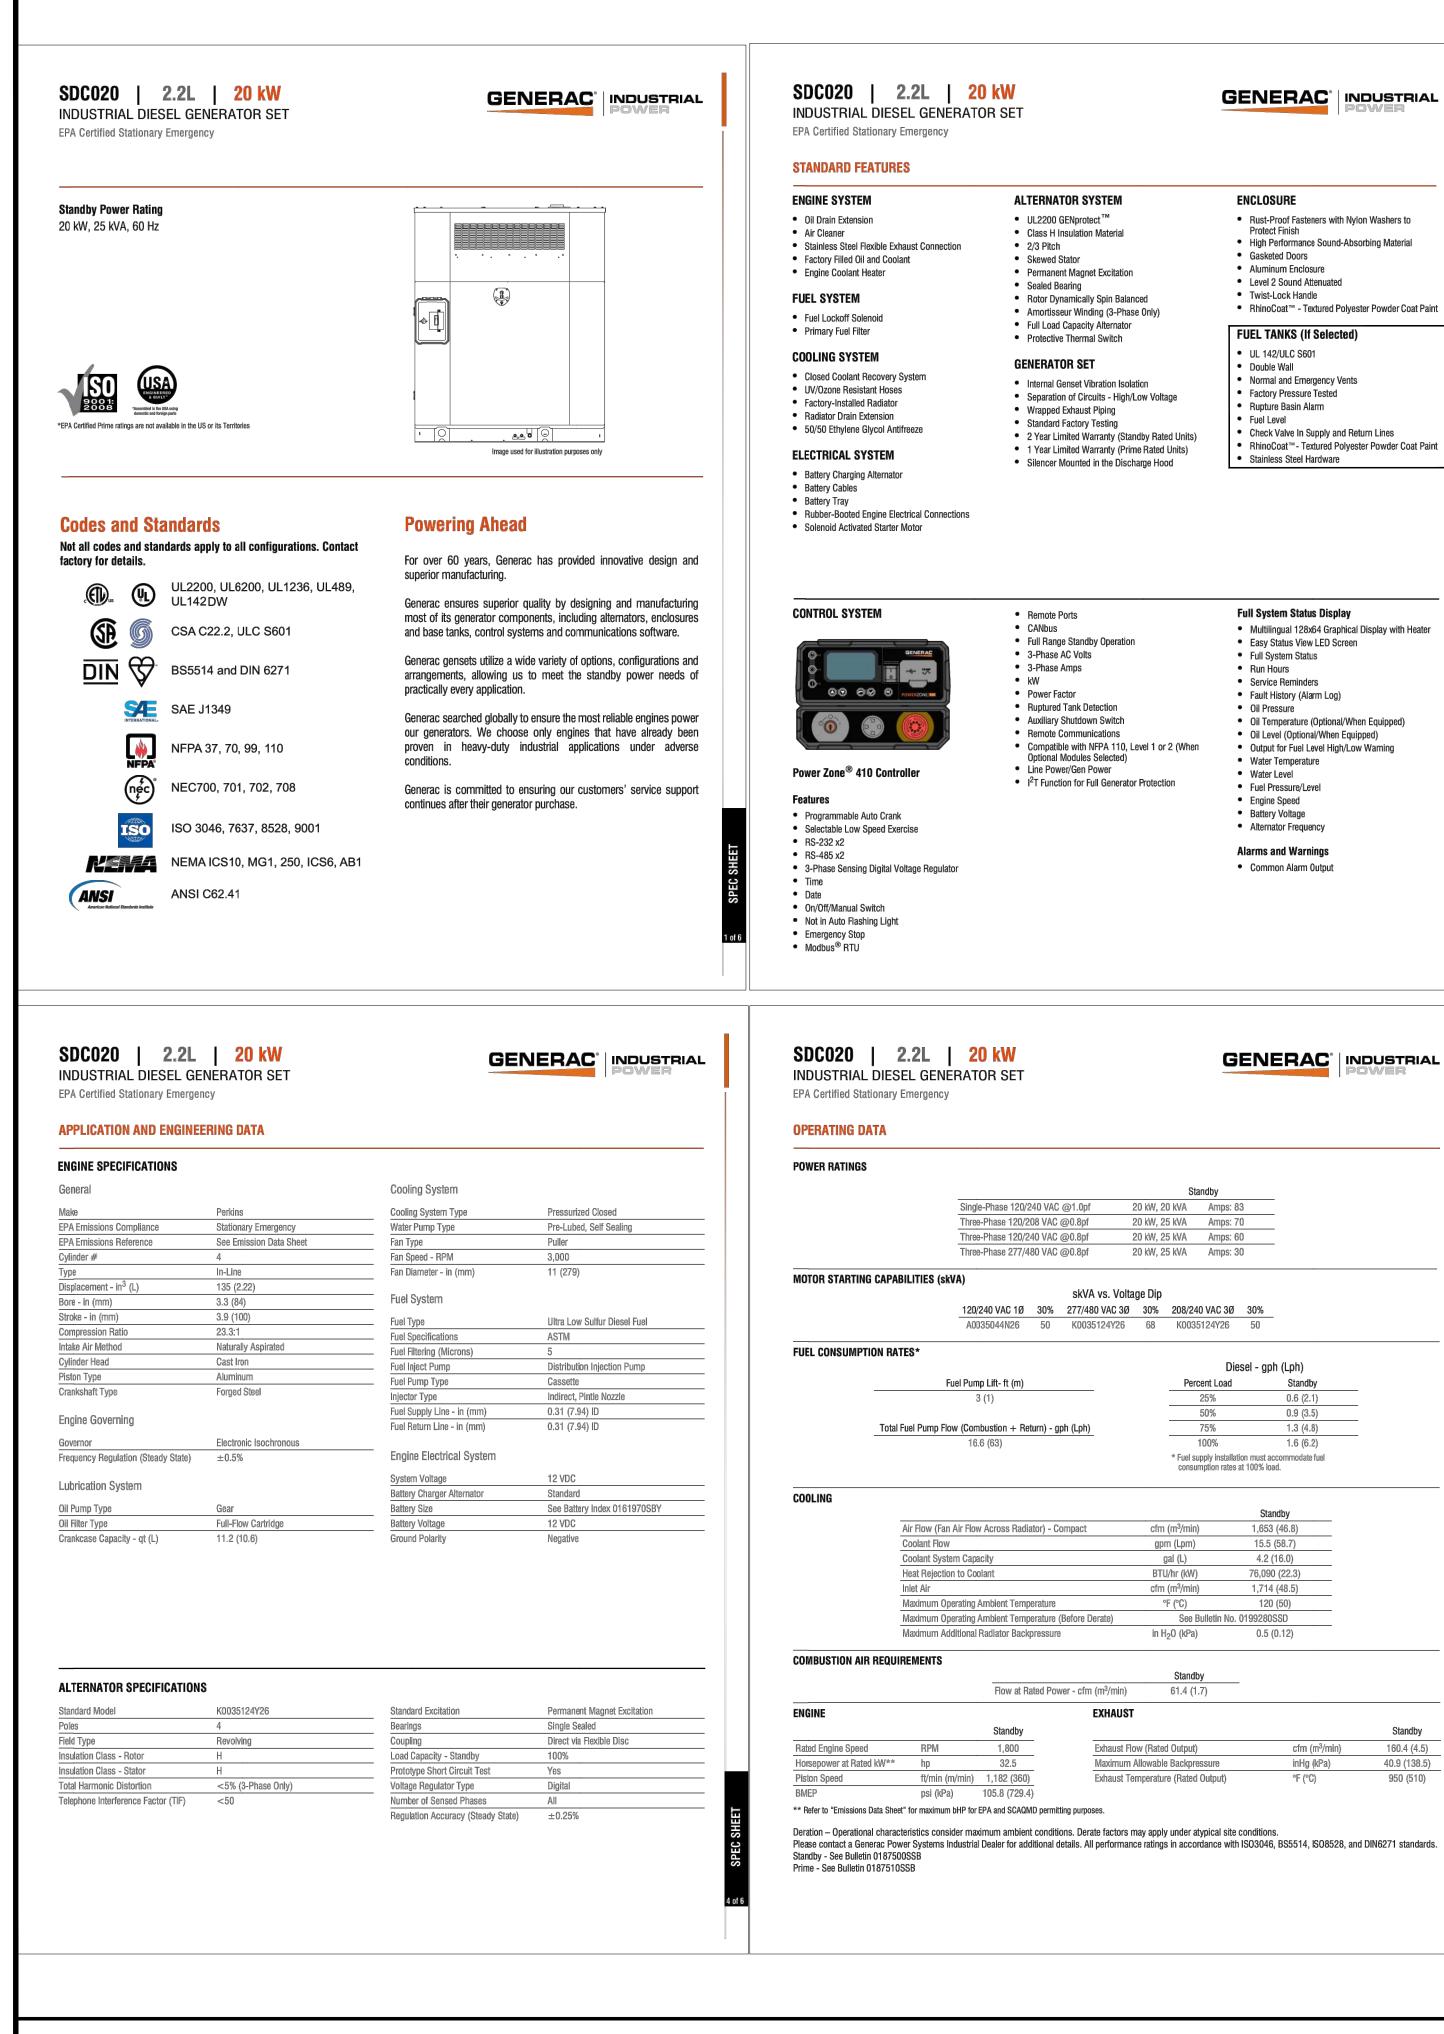
A-2


ANTENNA AND RRU SCHEDULE (PENDING RFDS)

3 SHELTER AREA PLAN

AREA PLAN



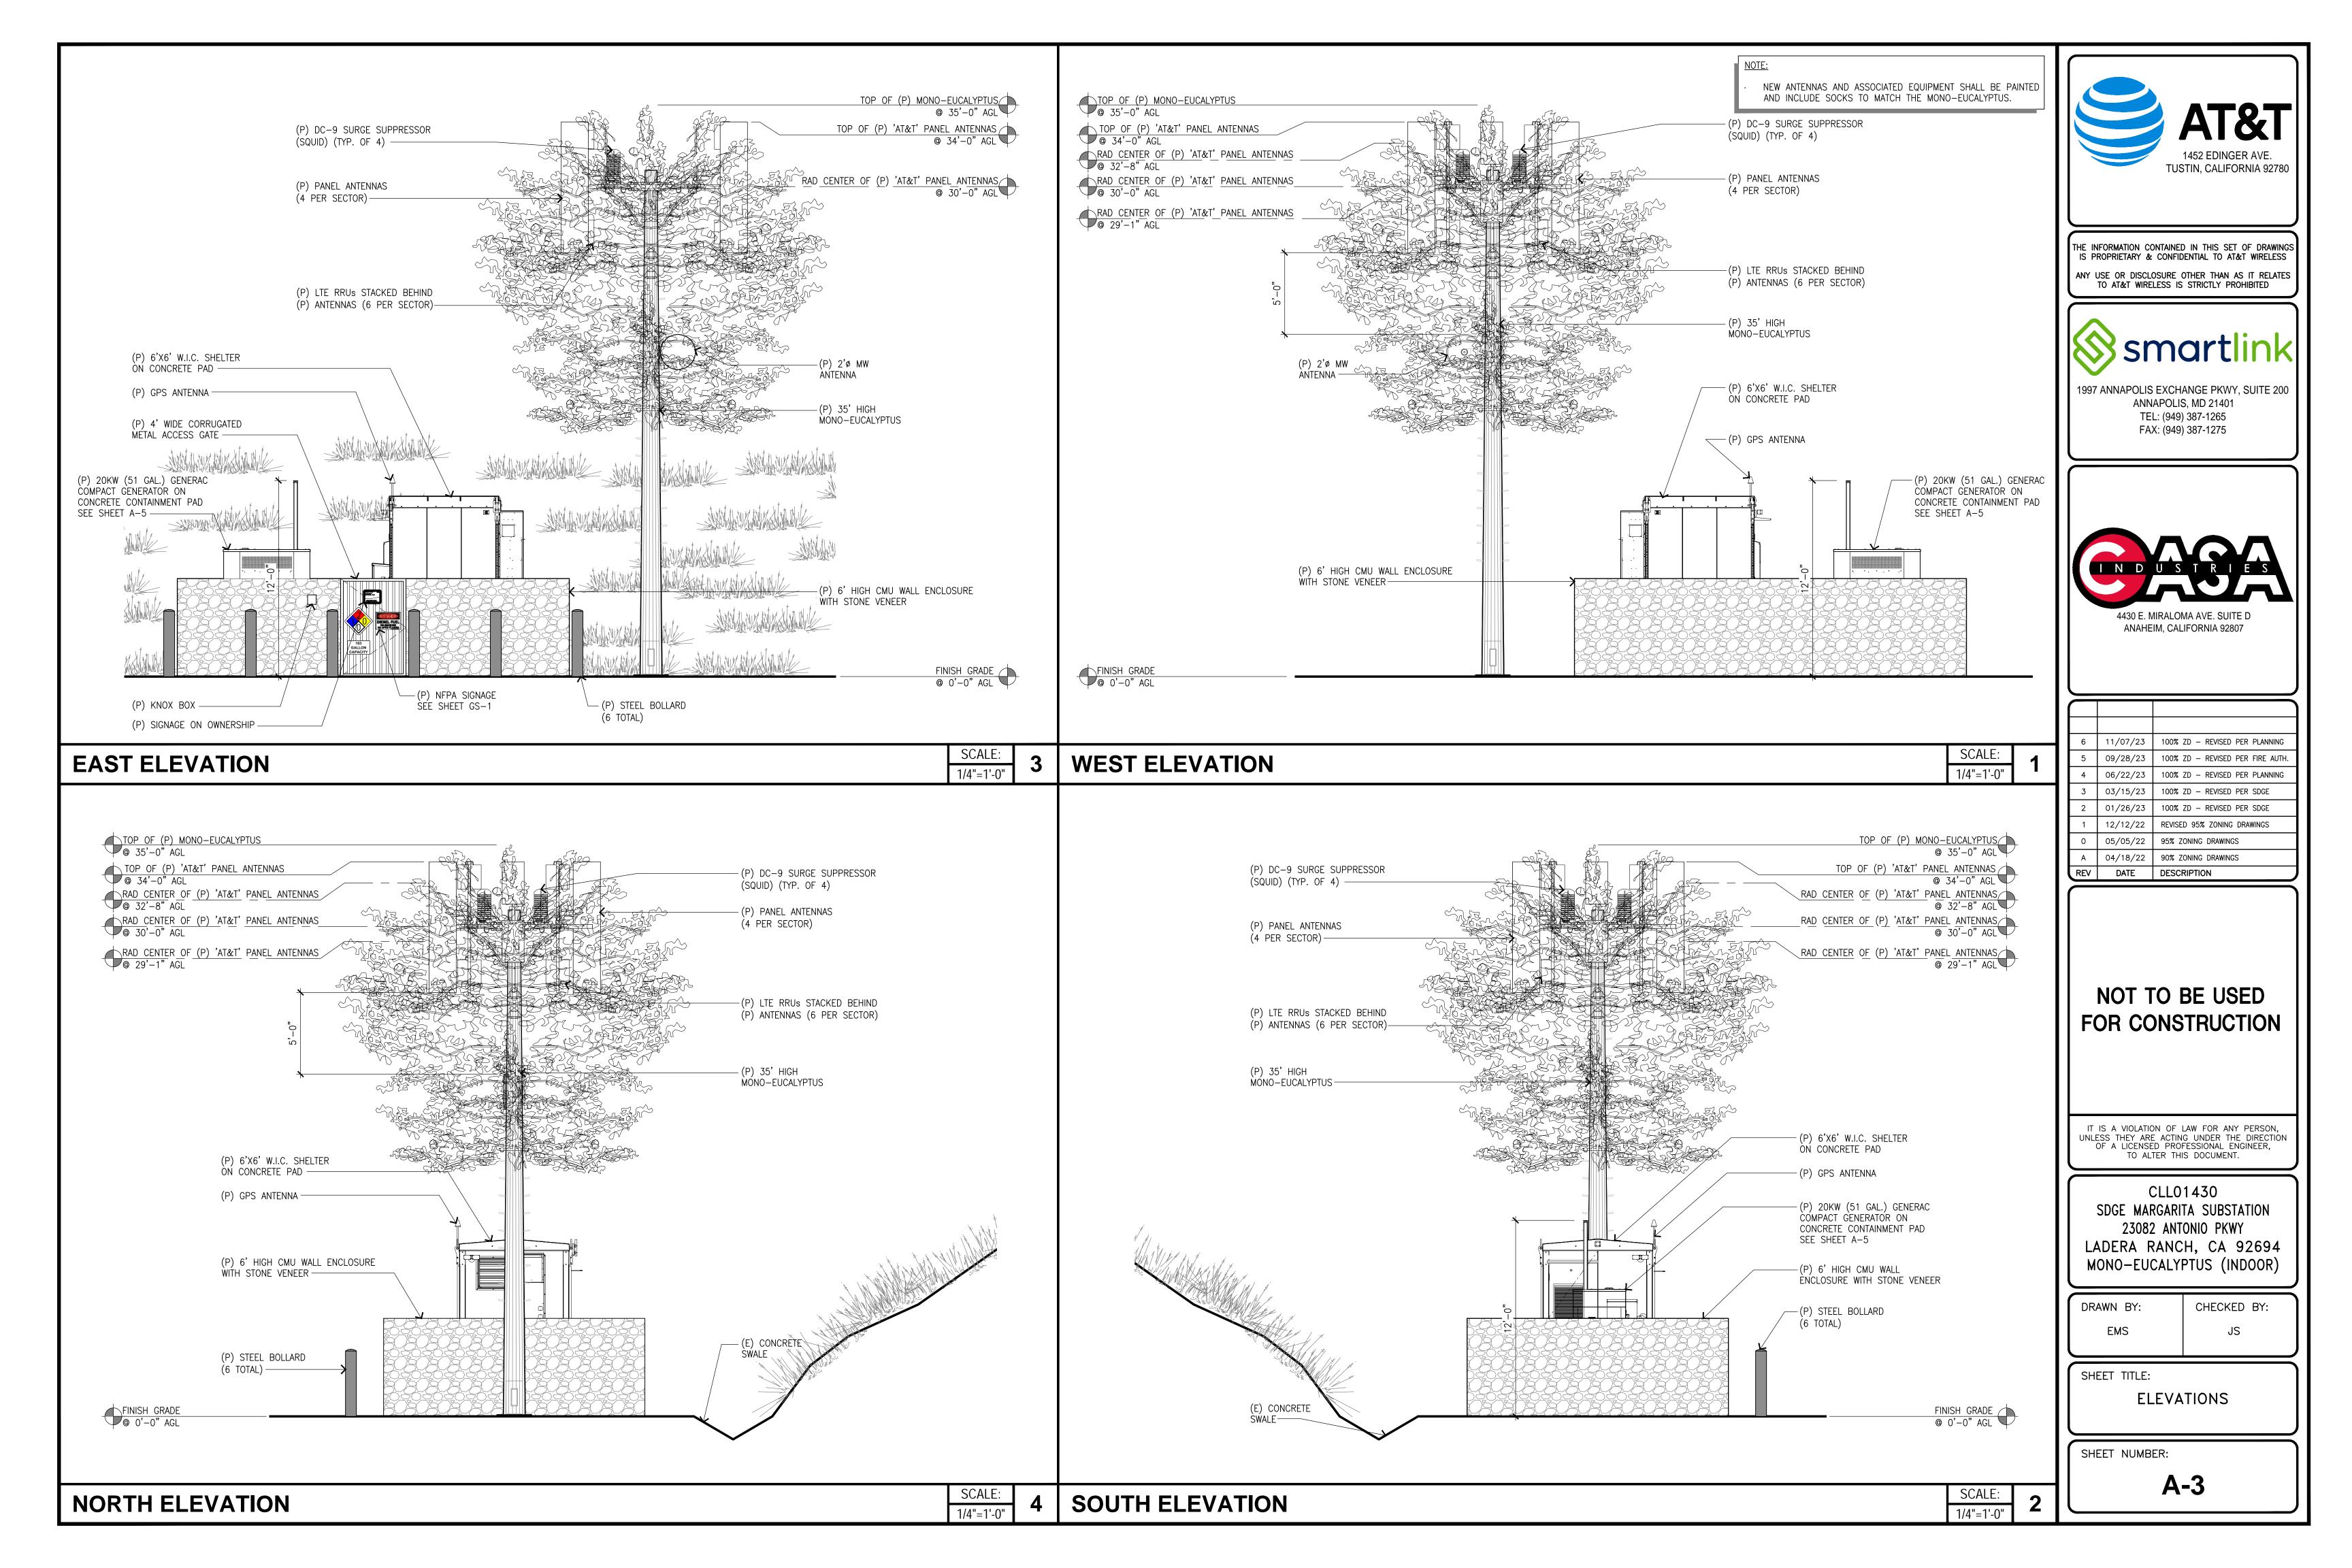

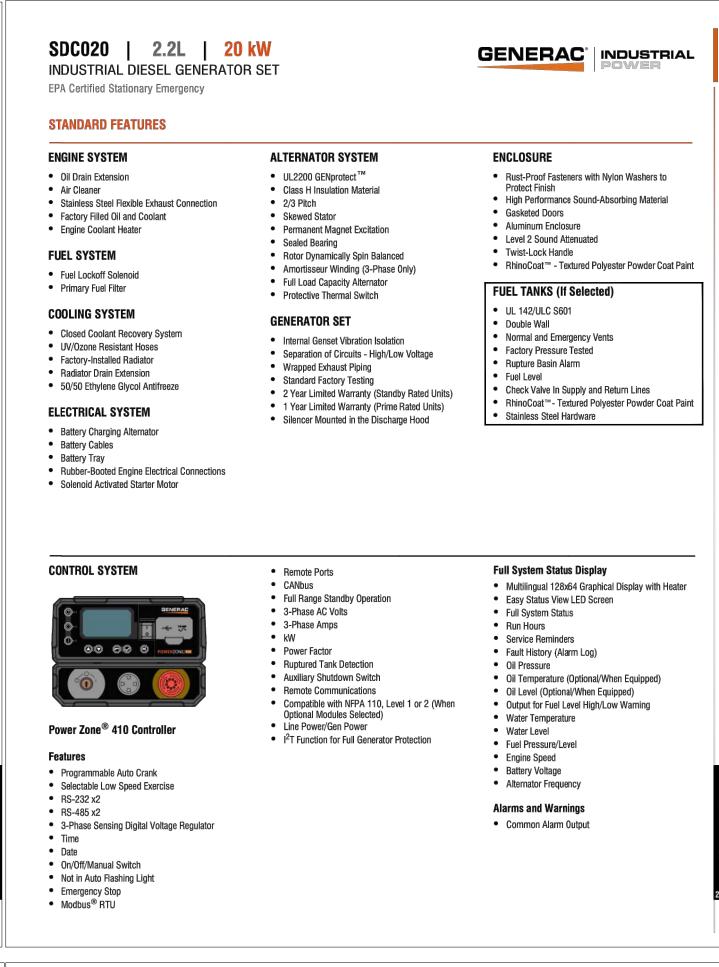

Single-Phase 120/240 VAC @1.0pf

ree-Phase 120/208 VAC @0.8pf

Three-Phase 120/240 VAC @0.8pf

Three-Phase 277/480 VAC @0.8pf

Flow at Rated Power - cfm (m3/min)

105.8 (729.4)

EXHAUST

Exhaust Flow (Rated Output)

Maximum Allowable Backpressure

Exhaust Temperature (Rated Output)

Fuel Pump Lift- ft (m)

20 kW, 25 kVA Amps: 60

20 kW, 25 kVA Amps: 30

Diesel - gph (Lph)

1,653 (46.8)

15.5 (58.7)

76,090 (22.3)

1.714 (48.5)

inHg (kPa)

160.4 (4.5)

40.9 (138.5)

950 (510)

consumption rates at 100% load.


See Bulletin No. 0199280SSD


skVA vs. Voltage Dip


120/240 VAC 1Ø 30% 277/480 VAC 3Ø 30% 208/240 VAC 3Ø 30%

A0035044N26 50 K0035124Y26 68 K0035124Y26 50

GENERAC INDUSTRIAL

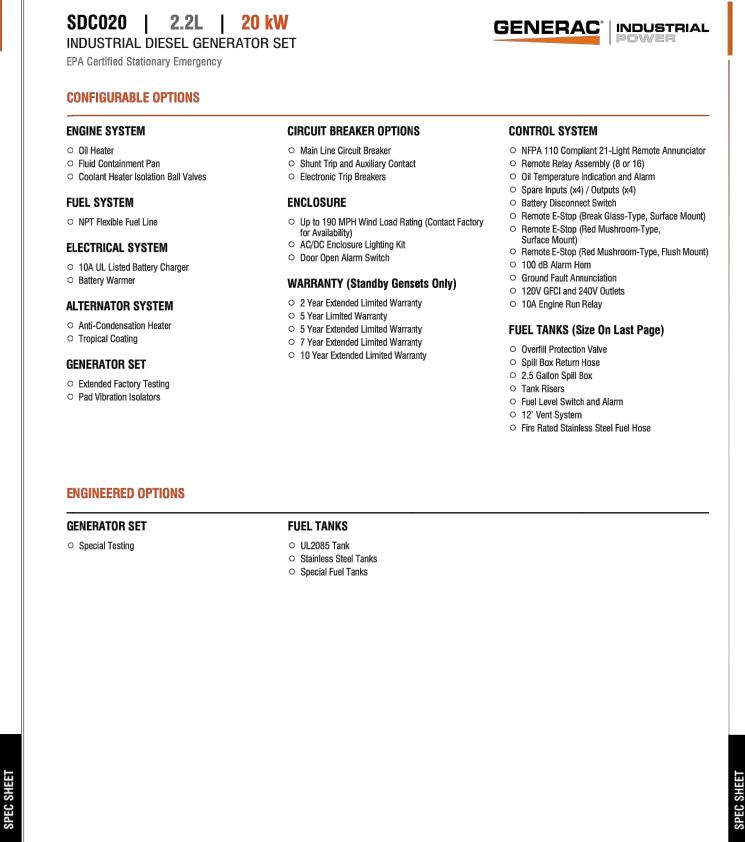

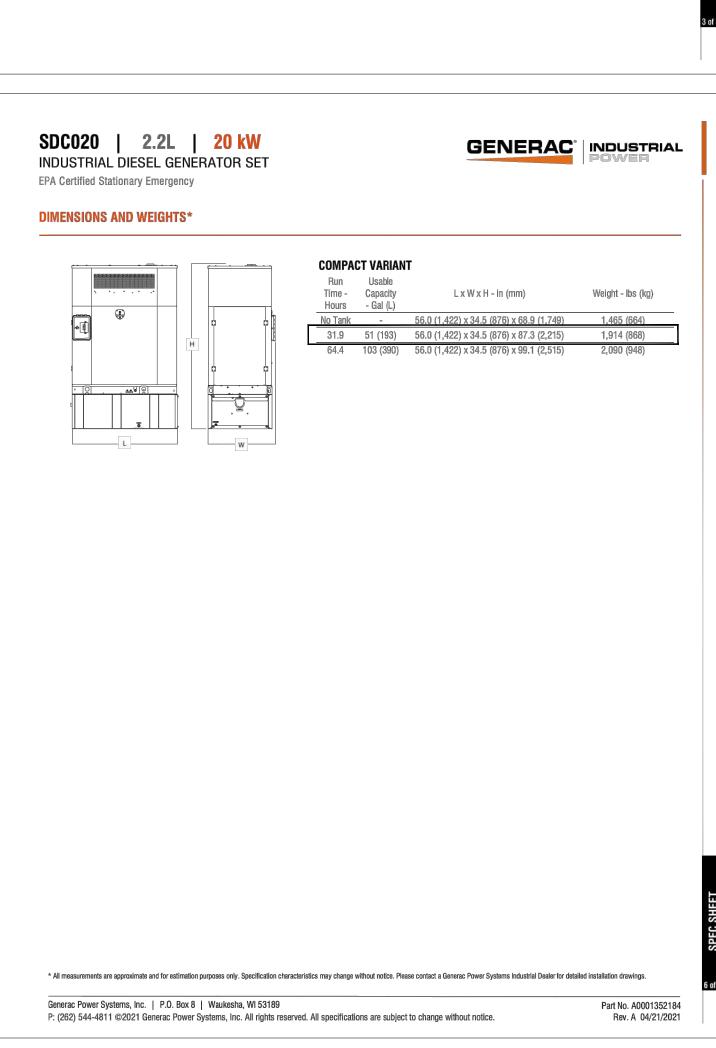

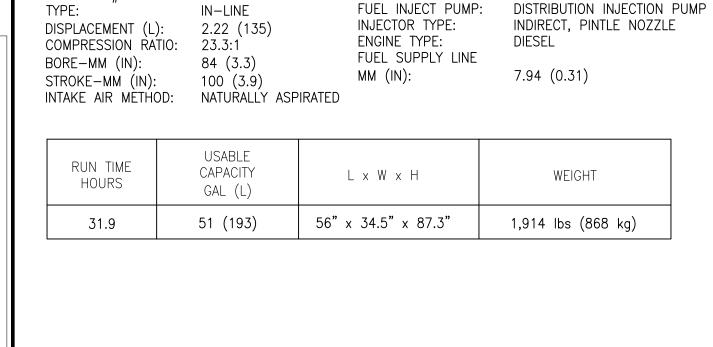

GENERAC

FUEL TANK

VENT PIPES -

• • • •

LEFT SIDE VIEW

SDC020 20 KW

FUEL SYSTEM

FUEL TYPE:

FUEL FILTERING:

FUEL SPECIFICATIONS: ASTM

FUEL TANK

VENT PIPES -


FRONT VIEW

<u>GENERAL</u>

MODEL:

CYLINDER #

MANUFACTURER:

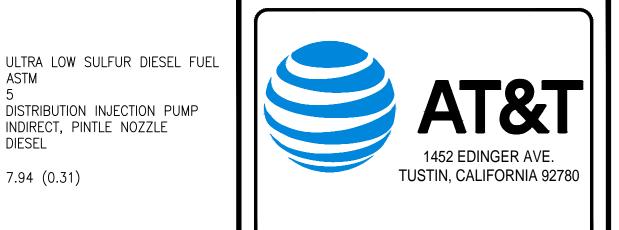

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|---|-----|----------|----------------------------------|
| | | | |
| | 6 | 11/07/23 | 100% ZD - REVISED PER PLANNING |
| | 5 | 09/28/23 | 100% ZD - REVISED PER FIRE AUTH. |
| | 4 | 06/22/23 | 100% ZD - REVISED PER PLANNING |
| | 3 | 03/15/23 | 100% ZD - REVISED PER SDGE |
| | 2 | 01/26/23 | 100% ZD - REVISED PER SDGE |
| | 1 | 12/12/22 | REVISED 95% ZONING DRAWINGS |
| | 0 | 05/05/22 | 95% ZONING DRAWINGS |
| | Α | 04/18/22 | 90% ZONING DRAWINGS |
| | REV | DATE | DESCRIPTION |

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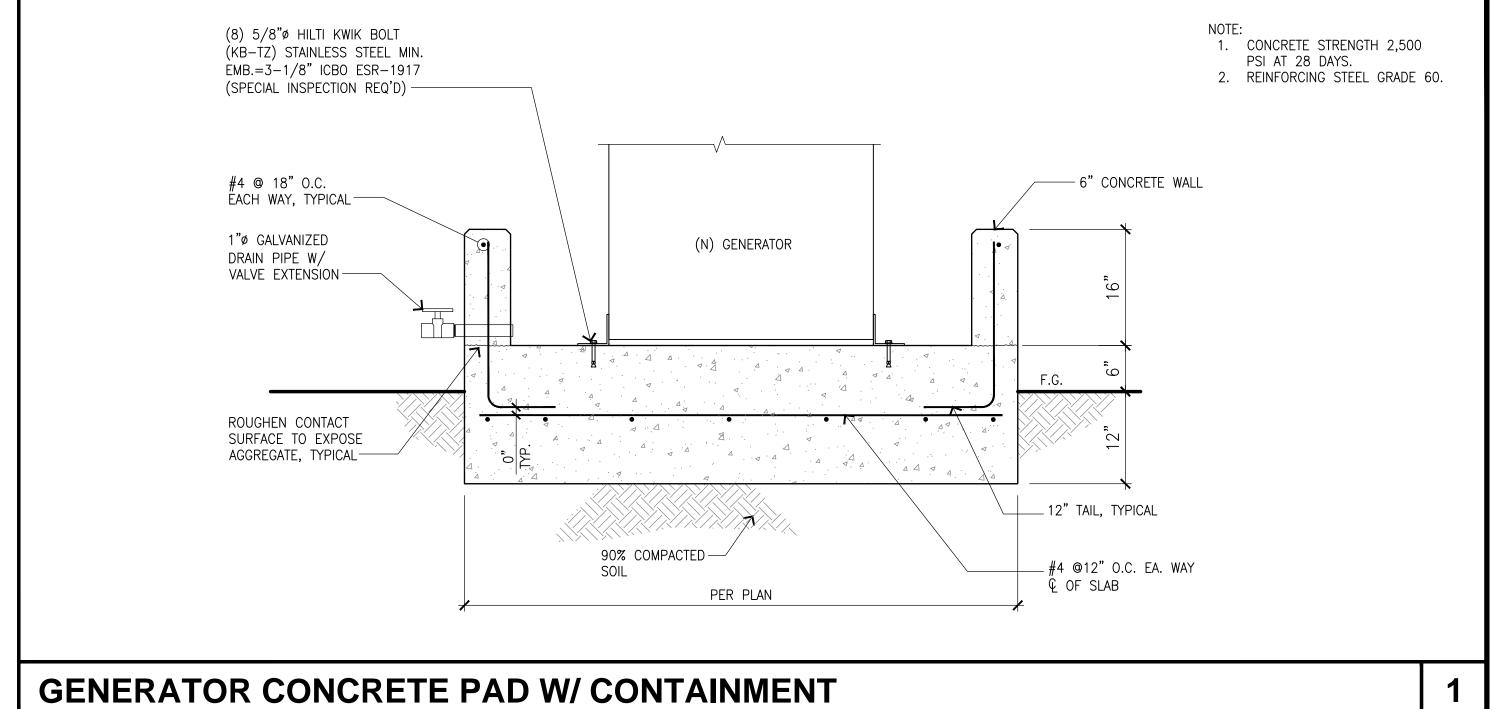
SHEET TITLE: **EQUIPMENT SPECIFICATIONS**

SHEET NUMBER:

A-4

GENERATOR SPECIFICATIONS

GENERATOR SPECIFICATIONS





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| | 6 | 11/07/23 | 100% ZD - REVISED PER PLANNING | |
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| | REV | DATE | DESCRIPTION | |
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MONO-EUCALYPTUS (INDOOR)

| DRAWN BY: | CHECKED E |
|-----------|-----------|
| EMS | JS |

SHEET TITLE:

DETAILS

SHEET NUMBER:

A-5