

DOUBLE R RANCH EQUINE SHADE STRUCTURES

19292 EL TORO ROAD TRABUCO CANYON, CALIFORNIA 92676


A PROJECT FOR



ORANGE COUNTY RESCUE MISSION

1 Hope Drive Tustin, California 92782

PROJECT LOCATION

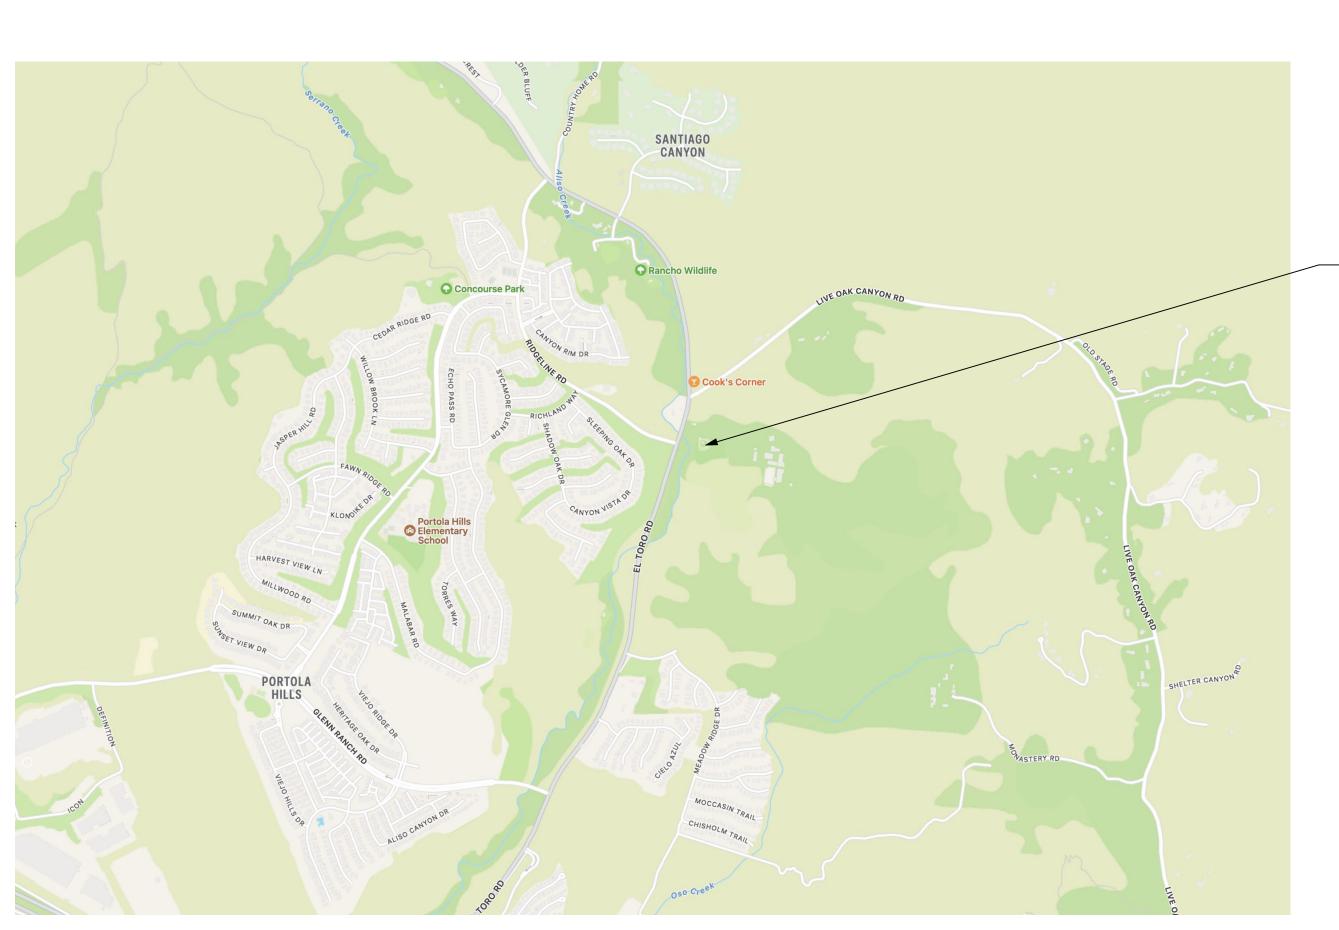

PROJECT LOCATION MAP

PROJECT SCOPE:

The project concists of the erection of 14 prefabricated, covered steel stall structures, a 24,324 SF exterior arena, a 300 SF exterior hay storage shed and associated water and sewer services, two 60' diameter round training pens (2,827 SF each. There will also be a designated location for the 2 - 2 cubic yard bins that will hold manure for collection by the refuse company.

There are 72 parking existing on the site. We believe that the equine facilities are an ancillary use for the property and will not generate a measurable increase in vehicular traffic or parking demands.

ZONING DESIGNATION:

The Zoning for the site is designated 'Foothill Trabuco Specific Plan'.

SHEET LIST

SDP-1	TITLE SHEET
SDP-2	SITE PLAN
SDP-3	EXISTING FACILITIES INVENTORY
SDP-4	TOPOGRAPHIC PLAN
F-1	SHADE STRUCTURE FLOOR PLANS
S-2	SHADE STRUCTURE ROOF PLANS
S-3	SHADE STRUCTURE ELEVATIONS
S-4	SHADE STRUCTURE ELEVATIONS
SDP-9	CONCEPTUAL GRADING PLAN
SDP-10	HAY STORAGE - MANURE STORAGE
SDP -11	RESOURCE COMPONENT OVERLAY

PROJECT DIRECTORY

PROJECT OWNER:

Orange County Rescue Mission 1 Hope Drive Tustin, California 92782 Contact: Bryan Crain

714 247 4351

CIVIL ENGINEER:

The Burgess Engineering Group 27758 Santa Margarita Parkway Suite 284 Mission Viejo, California 92791

Contact: John Burgess 949 436 1637

GEOTECHNICAL CONSULTANT:

Stoney Miller Consultants 33 Journey Suite 200 Aliso Viejo, California 92656 Contact: Erik Hilde

GENERAL CONTRACTOR:

Saddleback Development 28832 Sierra Peak Lane Trabuco Canyon, California 92679

949 903 1013

Contact: Tim Loza

CULTURAL RESOURCE CONSULTANT:

Ultra Systems 16431 Scientific Way Irvine, California 92718

Contact: Stephen O'Neil

BIOLOGICAL RESOURCE CONSULTANT:

Ultra Systems 16431 Scientific Way Irvine, California 92718

Contact: Michelle Tollet 949 788 4900

856-011-23 & 856-011-24

ASSESSORS PARCEL NUMBERS

PA23-0145

				PRO
No.	DATE	REVISION	APPROVED	

Orange County Rescue Mission

19292 El Toro Road

Trabuco Canyon, CA 92676

County of Orange

Department of Planning

J. T. Yean DATE: 07 01 24
Approver Title

DESIGNED:

JJB, Jr.

DRAWN:

JJB,Jr


JJB, Jr

BURGESS ENGINEERING GROUP

27758 Santa Margarita Parkway Suite 284

Mission Viejo, California 92691

949 588 8801 949 588 7216 (Fax)

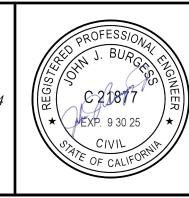



TITLE PAGE

Department of Engineering DR/

DRAWING 174607

SHEET SDP-1 OF 11

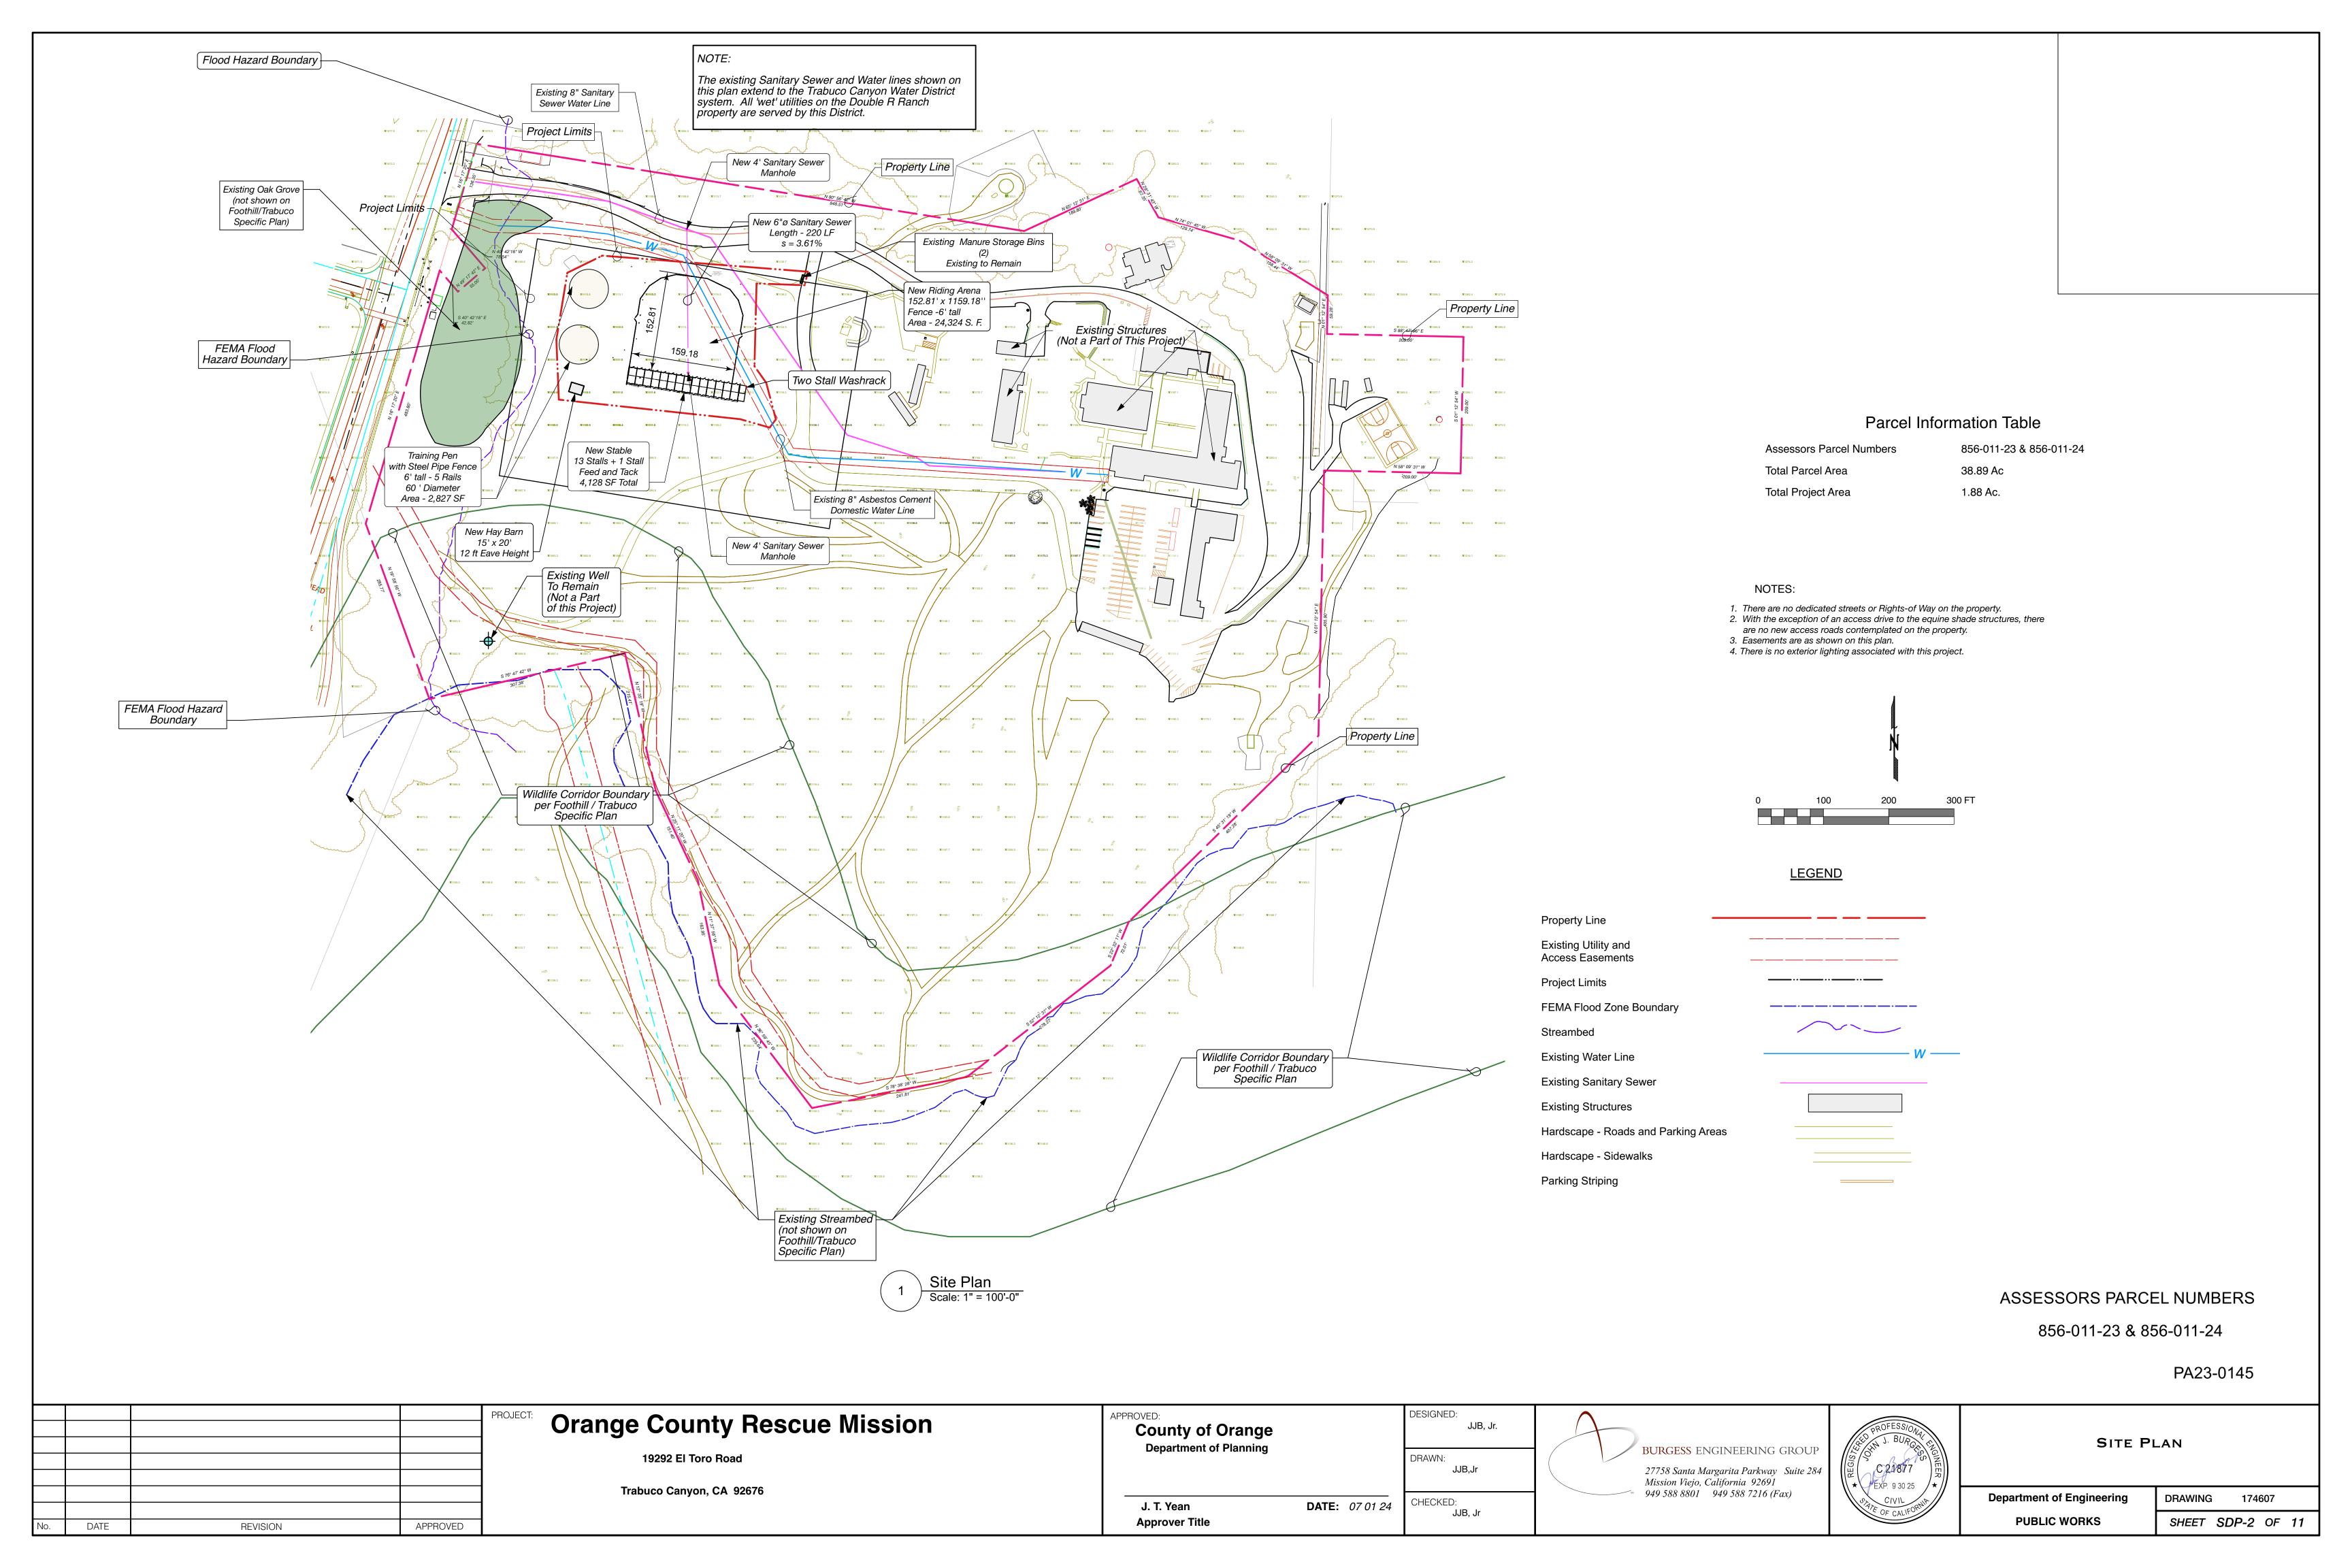

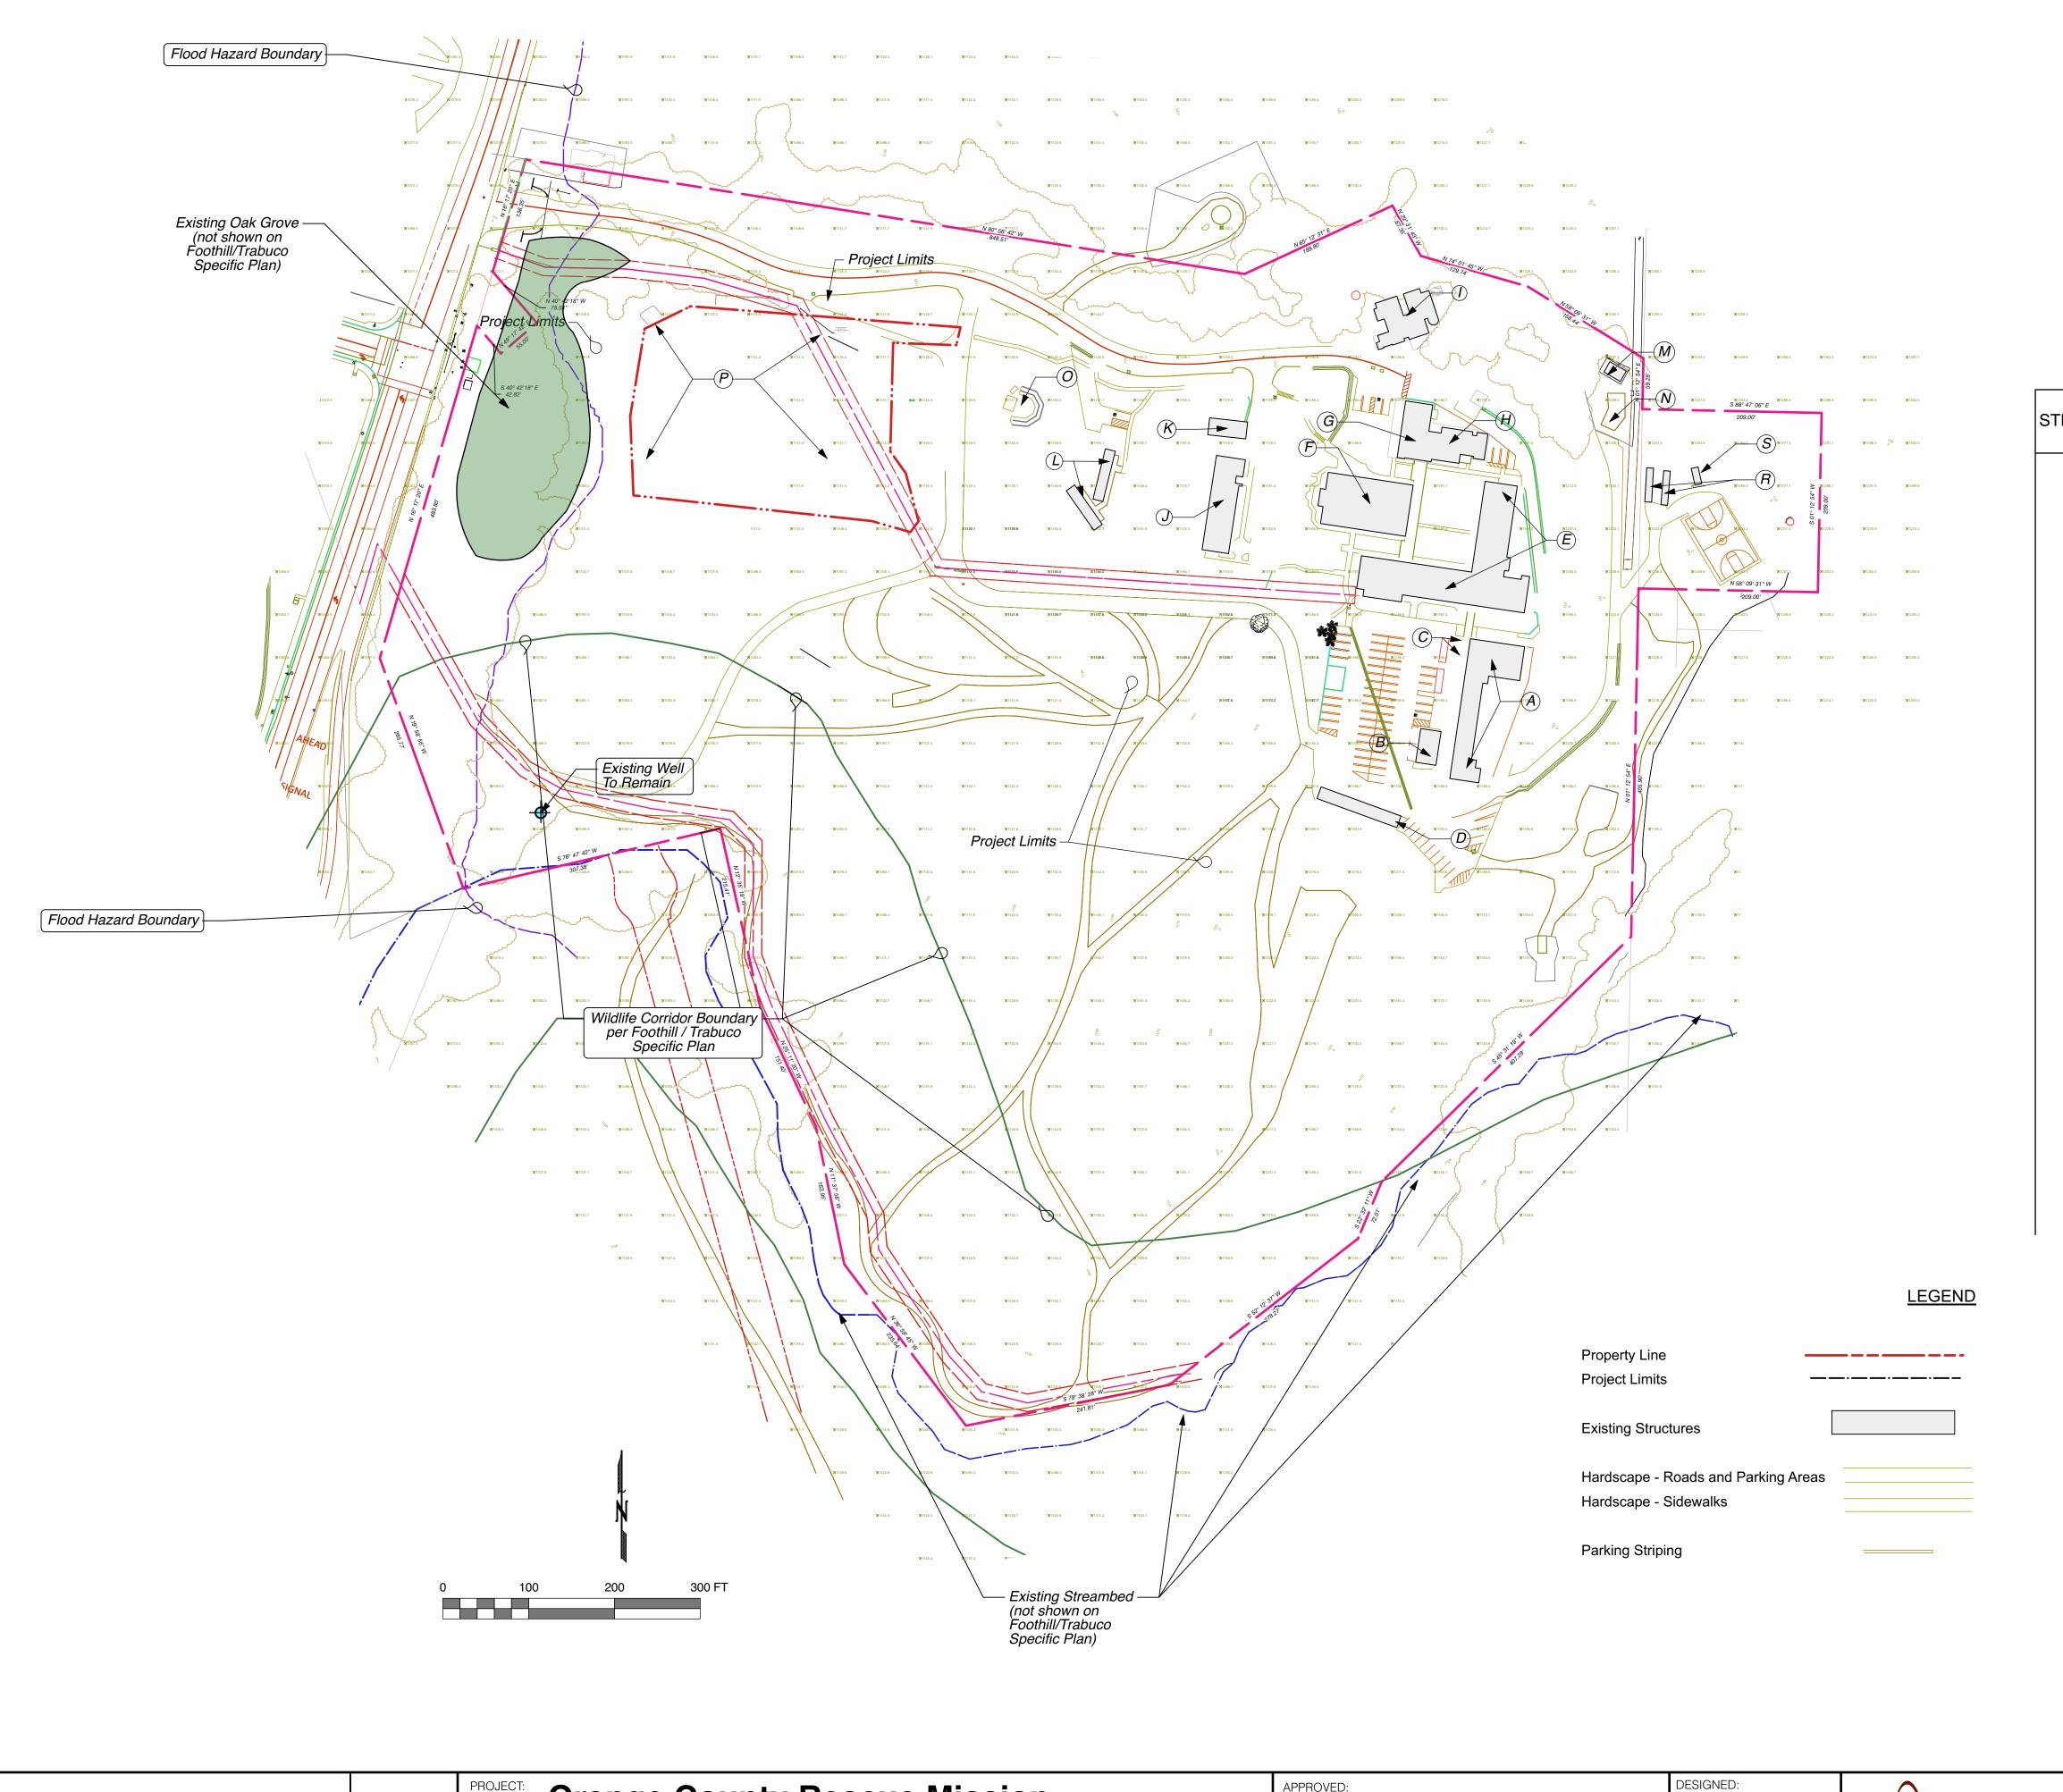

STRUCTURE	BUILDING USE	BUILDING PERMIT DATE	BUILDING PERMIT NO.
А	Prep School with Dormitory & Classrooms	01/23/74 11/08/76	89558 66790
В	Prep School Modular Classroom #1	11/08/76	66790
С	Prep School Modular Classroom #2 & #3	REMOVED	
D	Carport / Maintenance Storage Area	07/12/78	80689
E	Abbey: Dormitory + Library	11/08/76 01/17/80 09/10/85	66790 93879 79848
F	Church + Sacristy	12/21/83	59006
G	Dining Room and Kitchen	09/10/85	79847
Н	Kitchen: Storage House	09/10/85	79847
I	Convent	11/08/76	66790
J	Seminarian-Novitiate Formation House	03/05/64	11272Z
К	Seminarian-Modular Classroom #4	11/08/76	66790
L	Seminarian-Modular Dormitory #5 & #6	11/08/76	66790
М	Pool Building	05/31/63	5539/5927 /4834/8111
N	Outdoor Swimming Pool	(EXISTING)	66790
О	Camp Fire Ring	10/15//86	
Р	Athletic Field	(EXISTING)	
Q	Basketball Court	(EXISTING)	
R	Storage	(EXISTING)	
S	Trash	(EXISTING)	

ASSESSORS PARCEL NUMBERS

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19292 El Toro Road

Trabuco Canyon, CA 92676

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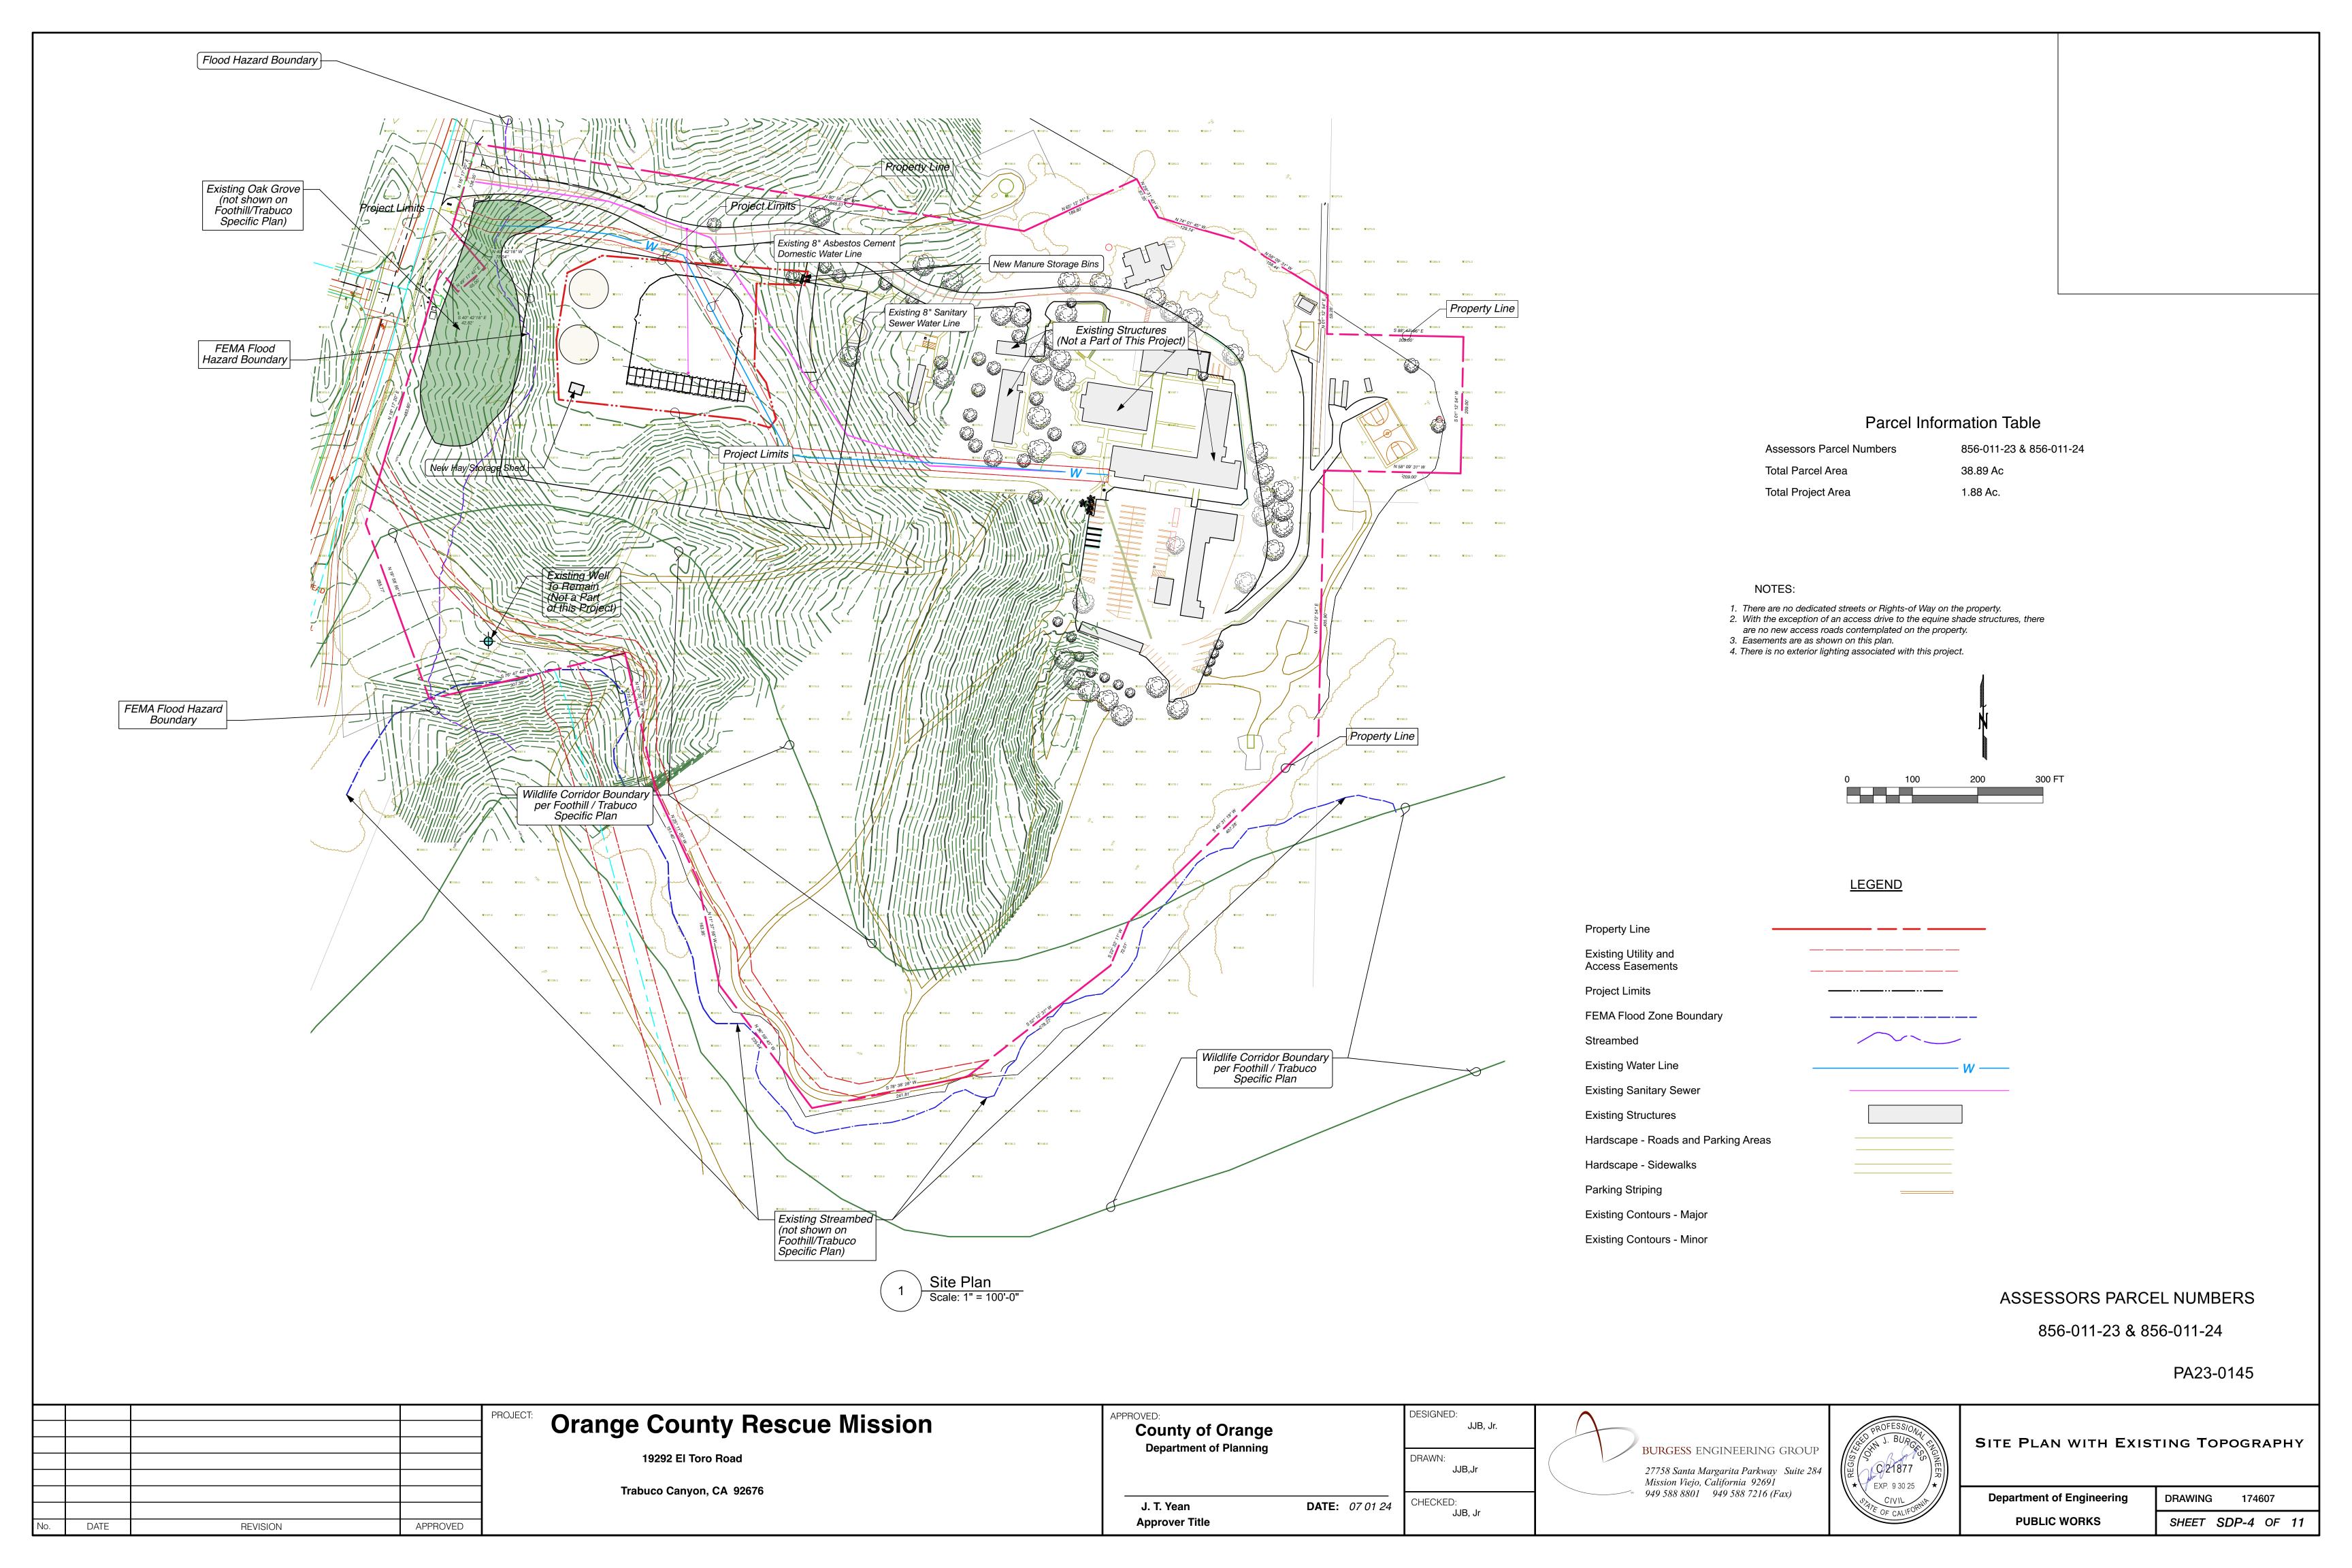
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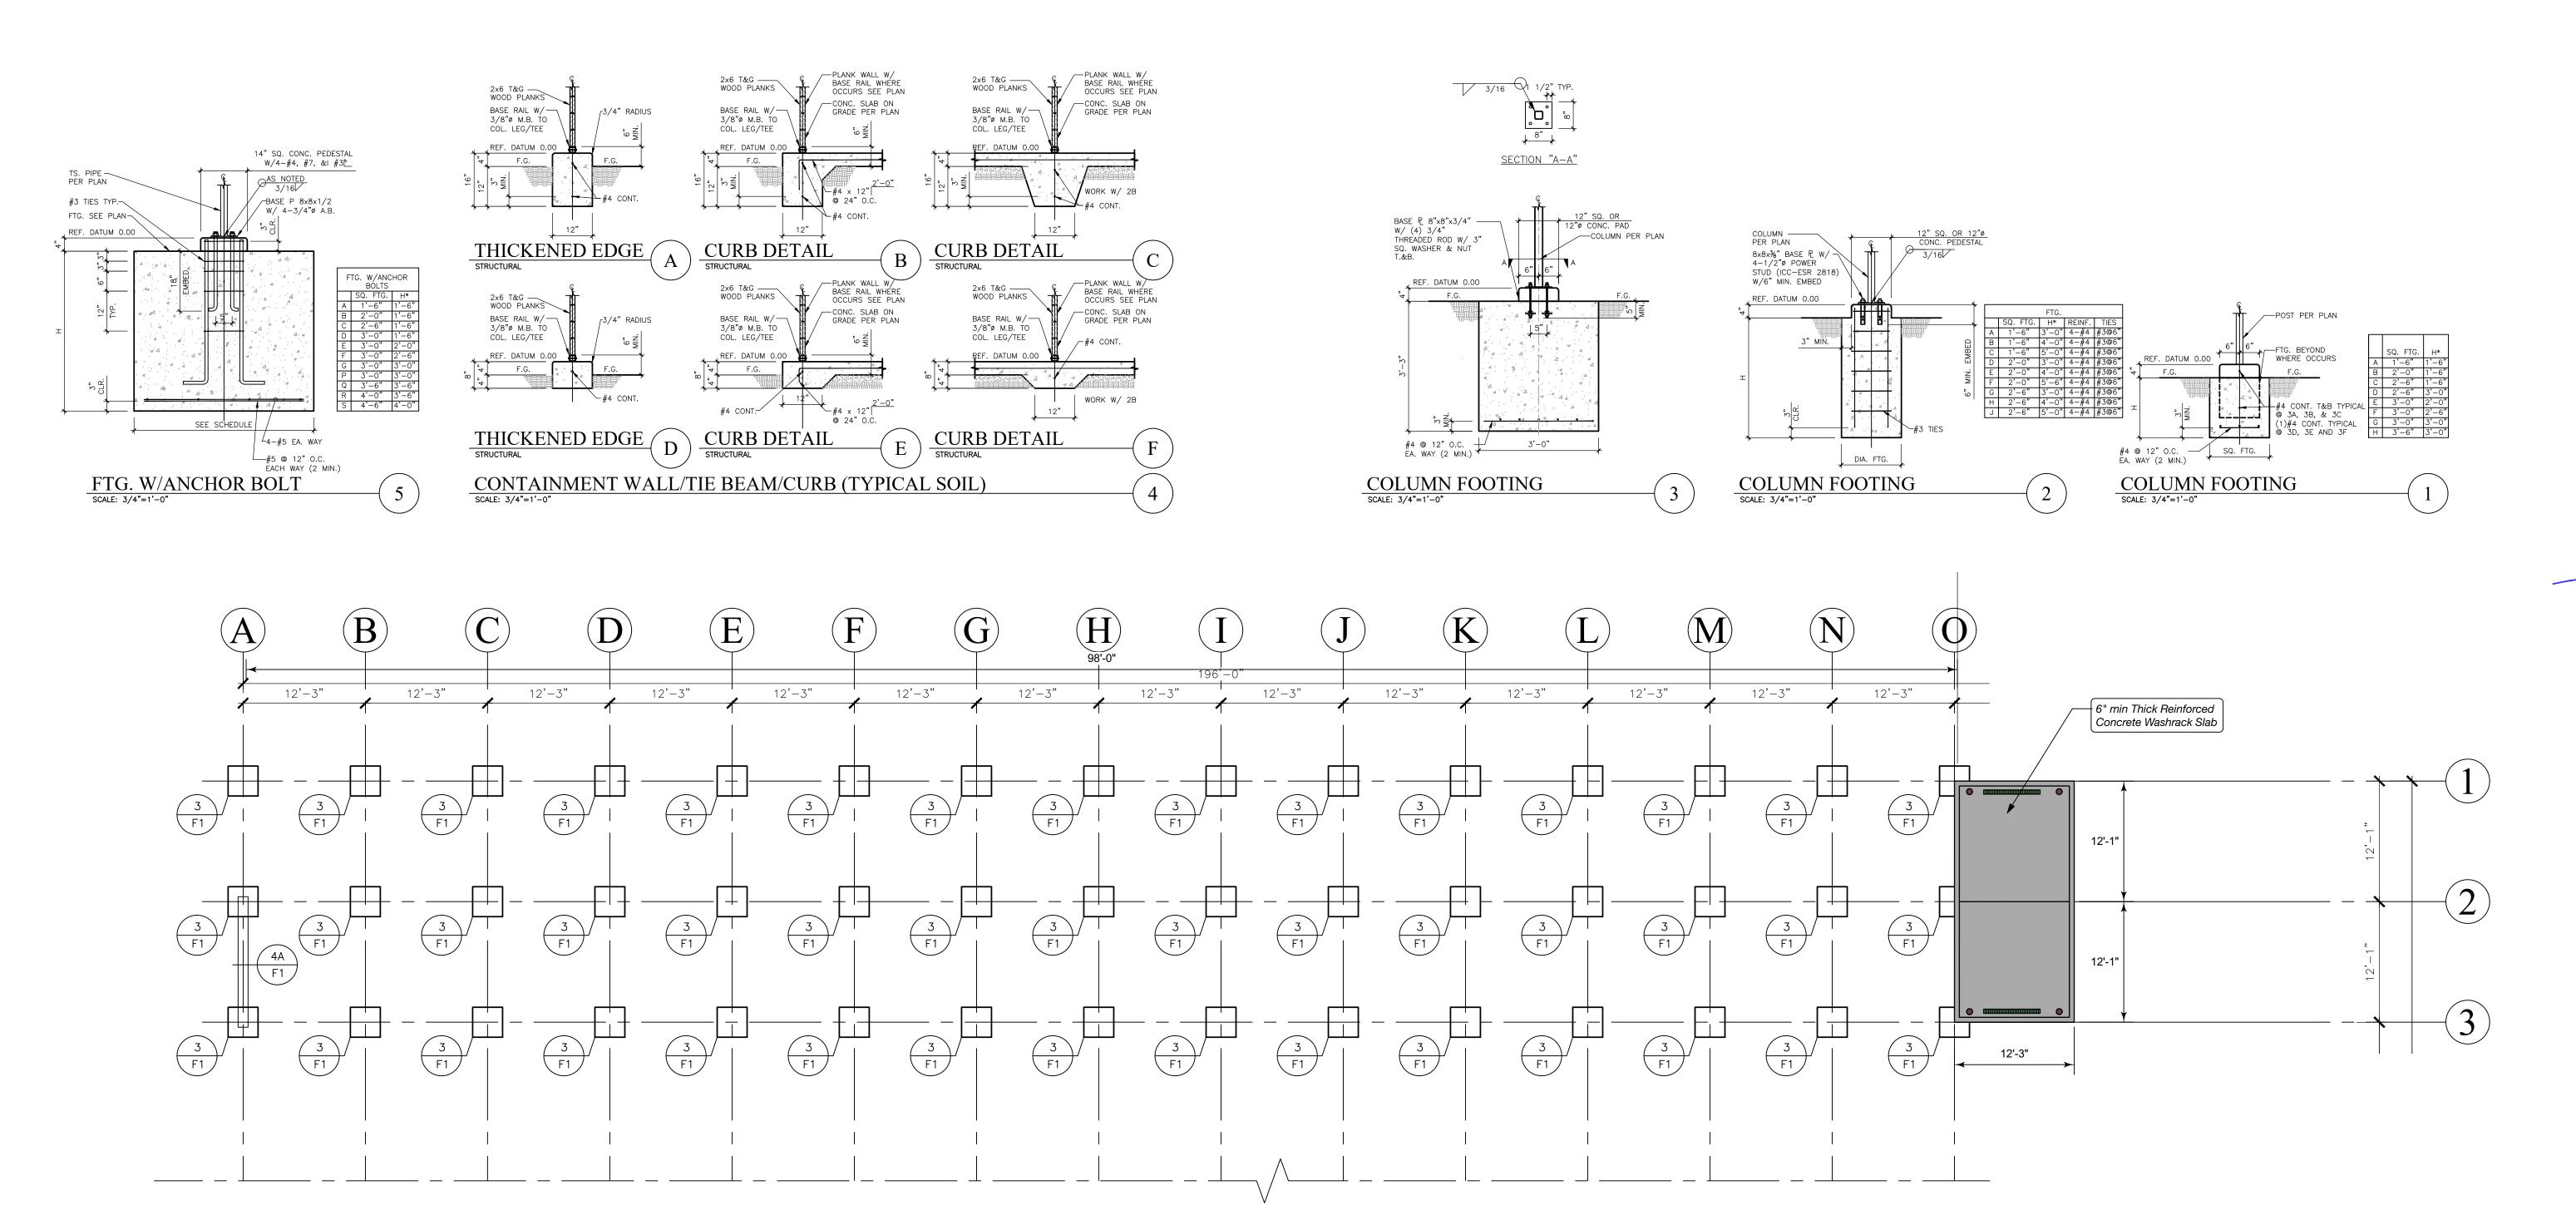



PROFESSIONAL PLANTS OF CALIFORNIA TE OF CALIFORNIA
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EXISTING FACILITIES INVENTORY


Department of Engineering	DRAWING 174607		
PUBLIC WORKS	SHEET S	SDP-3 OF	11





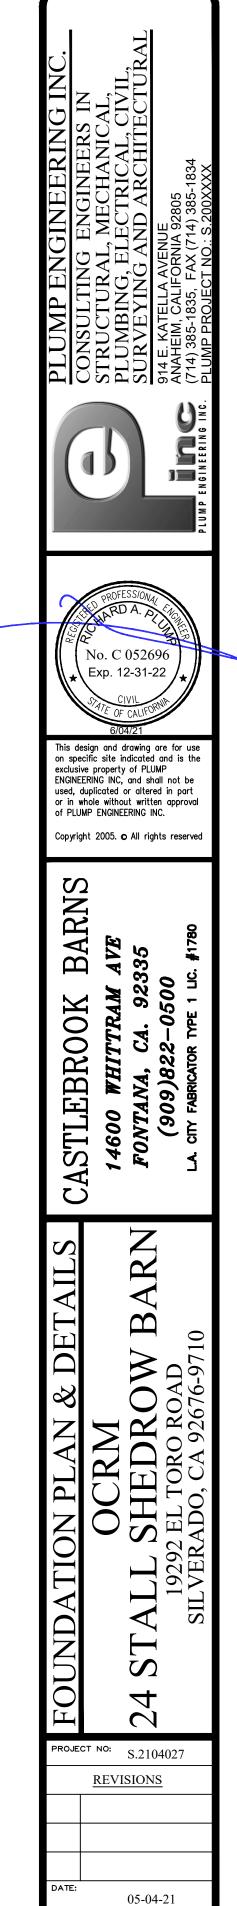

R. PLUMP

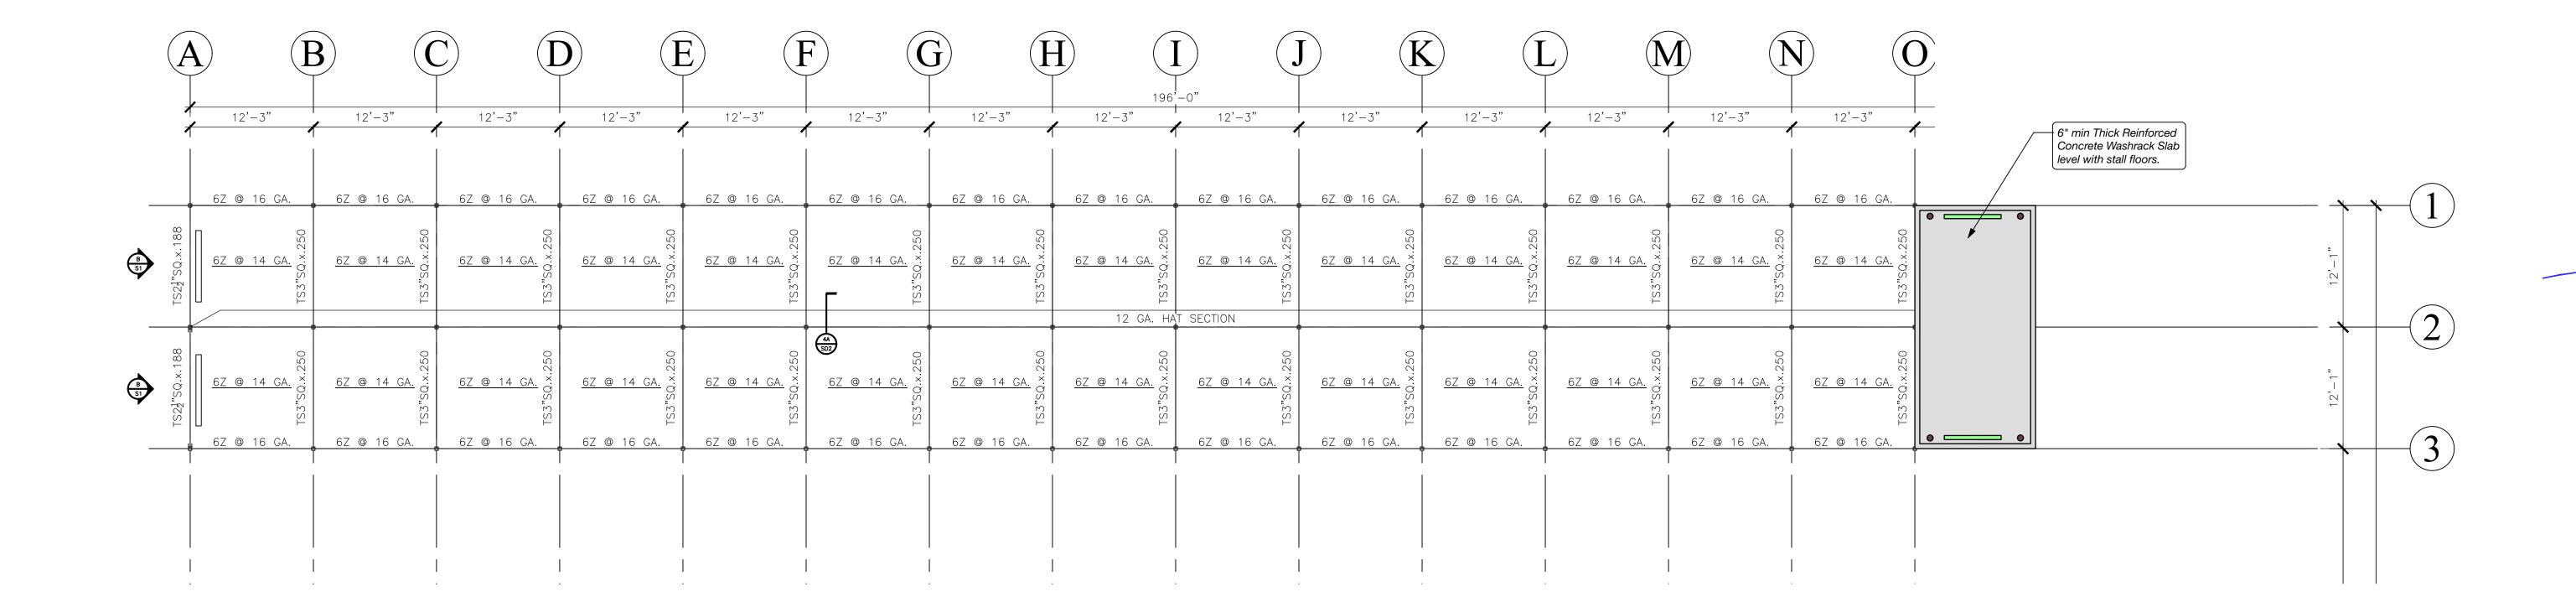

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ASSESSORS PARCEL NUMBERS 856-011-23 & 856-011-24

05-04-21

R. PLUMP

SHEET NO:

CODE: COMPLY WITH CALIFORNIA BUILDING CODE 2019 THESE PLANS HAVE BEEN DESIGNED AND COMPLY WITH THE BUILDING CODE SHOWN BELOW AS IT PERTAINS TO DESIGN CRITERIA. ROOF LOADS, SNOW LOADS AND WIND LOADS ARE BASED UPON INFORMATION SUPPLIED BY THE CUSTOMER AND HAVE NOT BEEN VERIFIED AS CORRECT BY THE ENGINEER AND MAY BE SUBJECT TO CHANGE PER BUILDING DEPARTMENT REQUIREMENTS. PLEASE VERIFY THAT THE CORRECT LOADS ARE BEING USED PRIOR TO PERMIT APPROVAL. STRUCTURE- WIND ULTIMATE 110 M.P.H. DESIGN LOADS: FOUNDATIONS— WIND ULTIMATE 110 M.P.H.

ROOF DEAD LOAD = 2.5 PSF, ROOF SNOW LOAD = 20.0 PSF

SITE CLASS D, SEISMIC DESIGN CATEGORY D BOTTOMS OF ALL FOOTINGS SHALL BEAR ON UNDISTURBED SOIL 1'-0" BELOW NATURAL GRADE, U.N.O. DESIGN SOIL PRESSURE 1,500 PSF TOTAL LOAD. FROST HEAVE: BOTTOMS OF ALL FOOTINGS SHALL BEAR ON UNDISTURBED SOIL 1'-6" BELOW NATURAL GRADE, U.N.O. VERIFY W/ LOCAL BLDG. DEPT. WHERE DEEPER FTG'S. MAY BE REQ'D. TO PREVENT FROST HEAVE. DESIGN SOIL PRESSURE 1,500 PSF TOTAL LOAD. SHOULD SOIL PRESSURE NOT MEET 1,500 PSF, VERIFY W/ LOCAL BLDG. DEPT. AS TO THE ACTUAL SOIL PRESSURE SHALL MEET ALL THE REQUIREMENTS OF CHAPTER 19 OF CONCRETE: CBC TYPE V CEMENT. MINIMUM 28 DAYS STRENGTH OF 2,500 PSI. MECHANICALLY VIBRATE ALL CONCRÉTE WHEN PLACED, EXCEPT SLABS ON GRADE. MAXIMUM SLUMP 3 1/2" TO 5". SLAB-ON-GRADE: PROVIDE MIN. REINFORCING FOR ALL SLAB ON GRADE 6x6-W1.4xW1.4 WELDED WIRE FABRIC OR #3 REBAR @ 24" O.C. - DESIGNATES STEM WALL STRUCTURAL STEEL: 1. ALL STRUCTURAL STEEL MATERIALS AND CONSTRUCTION SHALL CONFORM TO THE REQUIREMENTS SPECIFIED IN 2. STRUCTURAL STEEL SHALL CONFORM TO A.S.T.M. A-36 SPECIFICATIONS AND AS THE A.I.S.C. SPECIFICATIONS FOR FABRICATION AND ERECTION, U.N.O. ALL STEEL TUBES SHALL CONFORM TO A.S.T.M. A-500 GRADE "B", ALL STEEL PIPE SHALL CONFORM TO A.S.T.M. A-53 GRADE "B". 4. ALL BOLTS SHALL CONFORM TO A.S.T.M. (A-307) FOR UNFINISHED BOLTS, EXCEPT WHERE SPECIFICALLY NOTED AS SAE J492 GRADE 5 BOLTS IN DETAIL 1/SD2 SEE NOTES IN 1/SD2 FOR INSPECTION. 5. EXPANSIONS ANCHORS SHALL CONFORM AS FOLLOWS TO MFGR.
A. POWERS WEDGE BOLT ANCHOR ... ICC-ESR 2818
B. SIMPSON STRONG BOLT ... ICC-ESR 3037. REINFORCING STEEL: ALL REINFORCING STEEL SHALL CONFORM TO ASTM A-615, GRADE 60 EXCEPT TIES & STIRRUPS No. 3 AND 4 MAY BE GRADE 40. MIN. LAP, UNLESS NOTED OTHERWISE ON PLANS, SHALL BE 40 DIAMETERS. SPLICES IN HORIZONTAL REBAR IN STEM WALLS & FOOTING SHALL BE STAGGER 4'-0" MINIMUM. REINFORCING FABRIC SHALL CONFORM TO ASTM A-185. FASTENERS: VS BRAND SELF-DRILLING, SELF-TAPPING SCREWS ... ICC-ESR 5617 COLD FORMED PAINTED STEEL - 12, 14 AND 16 GA. SHALL CONFORM TO ASTM A570 GRADE 50, OR A.S.T.M. A678 GRADE 50 GALVANIZED STEEL: - 12, 14 AND 16 GA. SHALL CONFORM TO ASTM A446 GRADE D. PLYWOOD FOR WALL AND ROOF SHEATHING SHALL BE CD EXPOSURE I STRUCTURAL I USE EXTERIOR TYPE, MIN. C—C GRADE, LUMBER: WHERE PLYWOOD IS EXPOSED TO WEATHER. ALL PLYWOOD SHALL BE GLUED WITH EXTERIOR TYPE GLUE. ALL PLYWOOD SHALL CONFORM TO U.S. PRODUCT STANDARDS PS-1-83. PLYWOOD FOR FLOOR AND ROOF SHEATHING SHALL BE 5 PLY MIN. ALL 2x6 EXTERIOR LUMBER SIDING TO BE FIRE RETARDANT TREATED BY MFG. HOOVER TREATED WOOD PRODUCTS INC. 154 WIRE ROAD, THOMPSON, GA 30824 NO FIELD WELDING SHALL BE DONE. WELDING: FABRICATION: ALL STEEL FABRICATION SHALL BE DONE IN A CERTIFIED SHOP PROJECT SAFETY IS THE RESPONSIBILITY OF THE CONTRACTOR PLOR PERSONS IN CHARGE OF THE DAY-TO-DAY CONSTRUCTION. UNSECURED ROOF OR FLOOR JOISTS ARE SUBJECT TO ROLL OVER AND THEREFORE SHOULD NOT BE USED AS A WALKING SURFACE UNTIL THEY ARE SECURED AT BOTH SUPPORTS AND SPECIAL INSPECTION MAY BE REQUIRED PRIOR AND, OR DURING THE INSTALLATION OF THIS STRUCTURE. IT IS THE CUSTOMER'S RESPONSIBILITY TO PROVIDE FOR THESE INSPECTIONS AS APPLICABLE, AND TO HAVE ANY INSPECTOR REQUIRED ON SITE SO AS NOT TO INTERRUPT INSTALLATION OF THE STRUCTURE. SPECIAL INSPECTION: IF FOR <u>ANY</u> REASON THE DETAILS AND INFORMATION CONTAINED ON THESE PLANS DO NOT CONFORM TO THE CONSTRUCTION SITE NOTE TO CONTRACTOR: CONDITIONS, IT SHALL BE THE SOLE RESPONSIBILITY OF THE CONTRACTOR TO PROMPTLY NOTIFY
CASTLEBROOK BARNS. THERE IS NO
ACCEPTABLE EXCUSE FOR UNAUTHORIZED FIELD THE CONTRACTOR SHALL PROVIDE ALL TEMPORARY BRACING, SHORING, GUYING OR OTHER MEANS TO AVOID EXCESSIVE STRESSES AND TO HOLD STRUCTURAL ELEMENTS IN PLACE DURING ERECTION. ESTABLISH AND VERIFY ALL OPENINGS AND INSERTS FOR MECHANICAL, ELECTRICAL AND PLUMBING WITH APPROPRIATE TRADES, DRAWINGS AND SUBCONTRACTORS PRIOR TO CONSTRUCTION.
CONTRACTOR SHALL VERIFY IN FIELD ALL EXISTING
CONDITIONS SHOWN IN DRAWINGS. ANY ENGINEERING DESIGN PROVIDED BY OTHERS AND SUBMITTED FOR REVIEW SHALL BEAR THE SEAL OF AN ENGINEER REGISTERED IN CALIFORNIA. IT IS THE CONTRACTOR'S RESPONSIBILITY TO OBSERVE AISC-13TH EDITION CODE OF STANDARD PRACTICE ALL DIMENSIONS SHOWN ON PLANS ARE CENTER LINE DIMENSIONS. CONCRETE ESTIMATES ARE BASED ON \$85.00 PER YARD. SHOP YOUR CONCRETE PRIOR TO CONTRACTING FOR YOUR BEST PRICE. OWNER SHALL PAY ENGINEER TO PERFORM STRUCTURAL OBSERVATIONS IF REQUIRED BY BUILDING DEPT. OBSERVATION: NOTE: ALL Z PURLINS ARE MANUF. BY McELROY SEE SD1 FOR PROPERTIES WORK W/ SD1 FOR METAL DECK ROOF ATTACHMENT

OCCUPANCY TYPE AND CONSTRUCTION:


OPEN AREA = 39,200 SQ. FT

CLOSED AREA = 7105 SQ. FT

TOTAL AREA = 46305 SQ. FT

OCCUPANCY U-1
OCCUPANCY U-3

CONSTRUCTION II-B CONSTRUCTION II-B

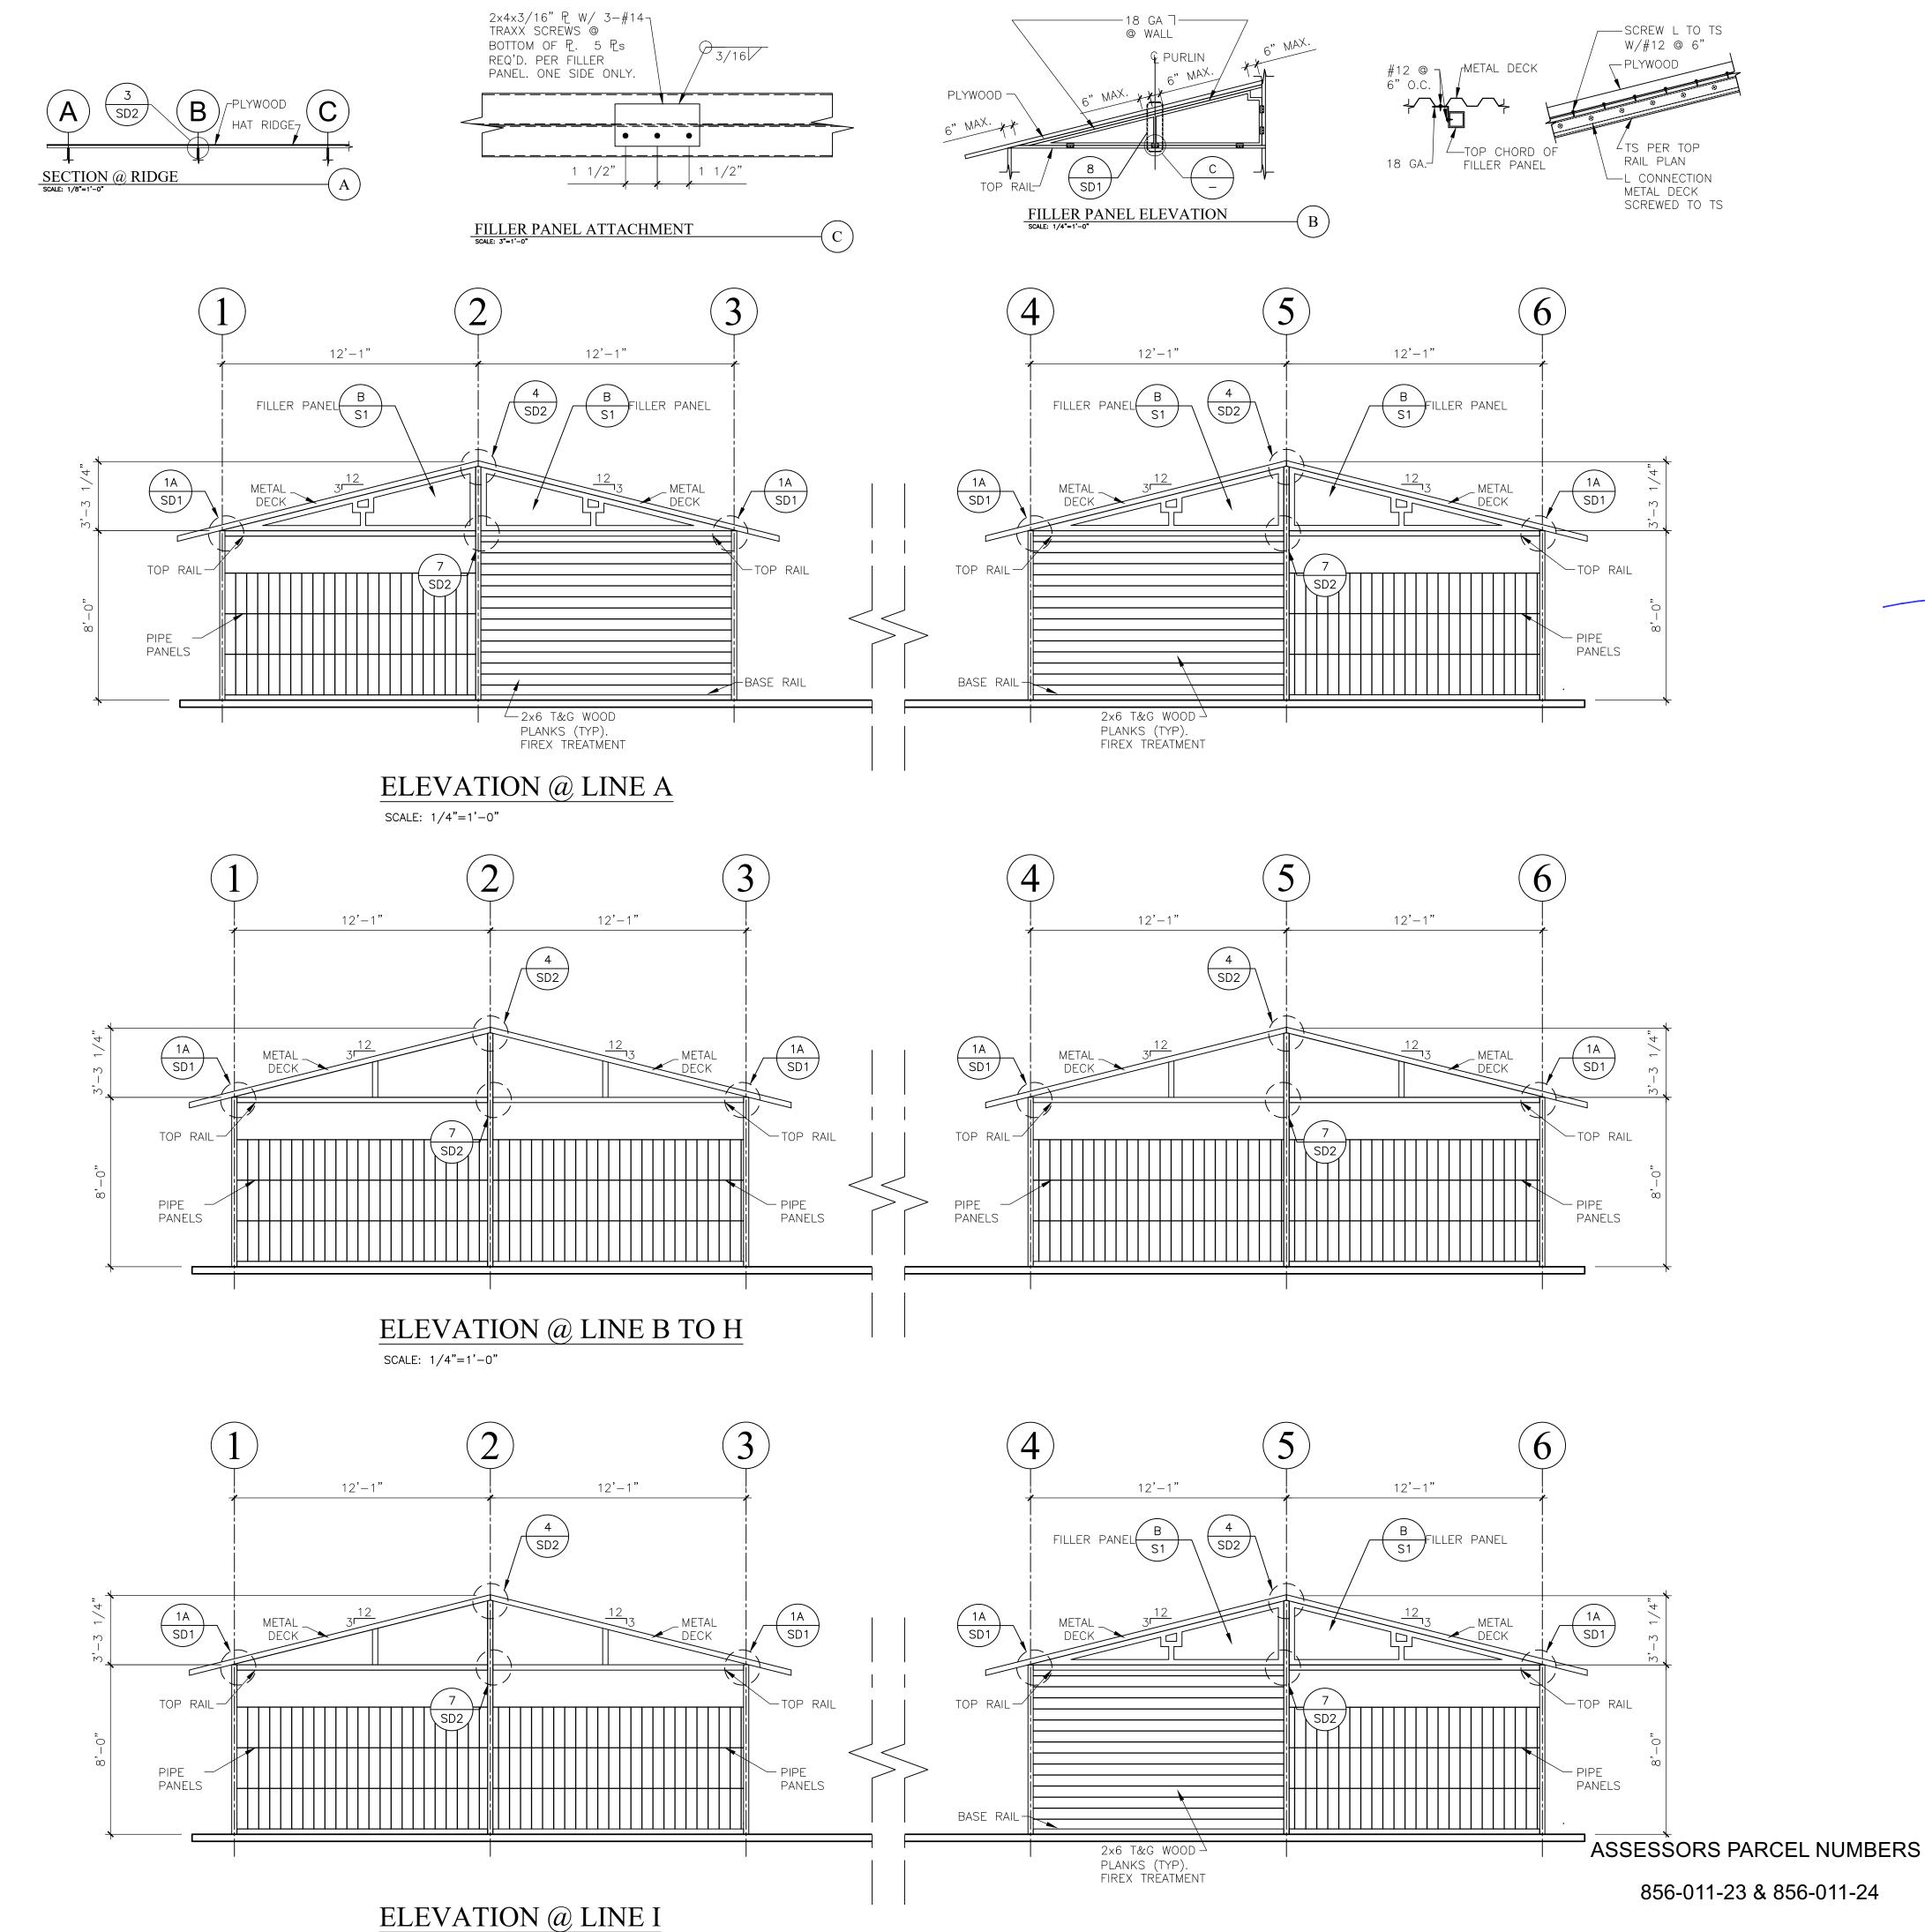

SCALE: 1/4"=1'-0"

SHEET NO:

PROJECT NO: S.2104027

REVISIONS

05-04-21

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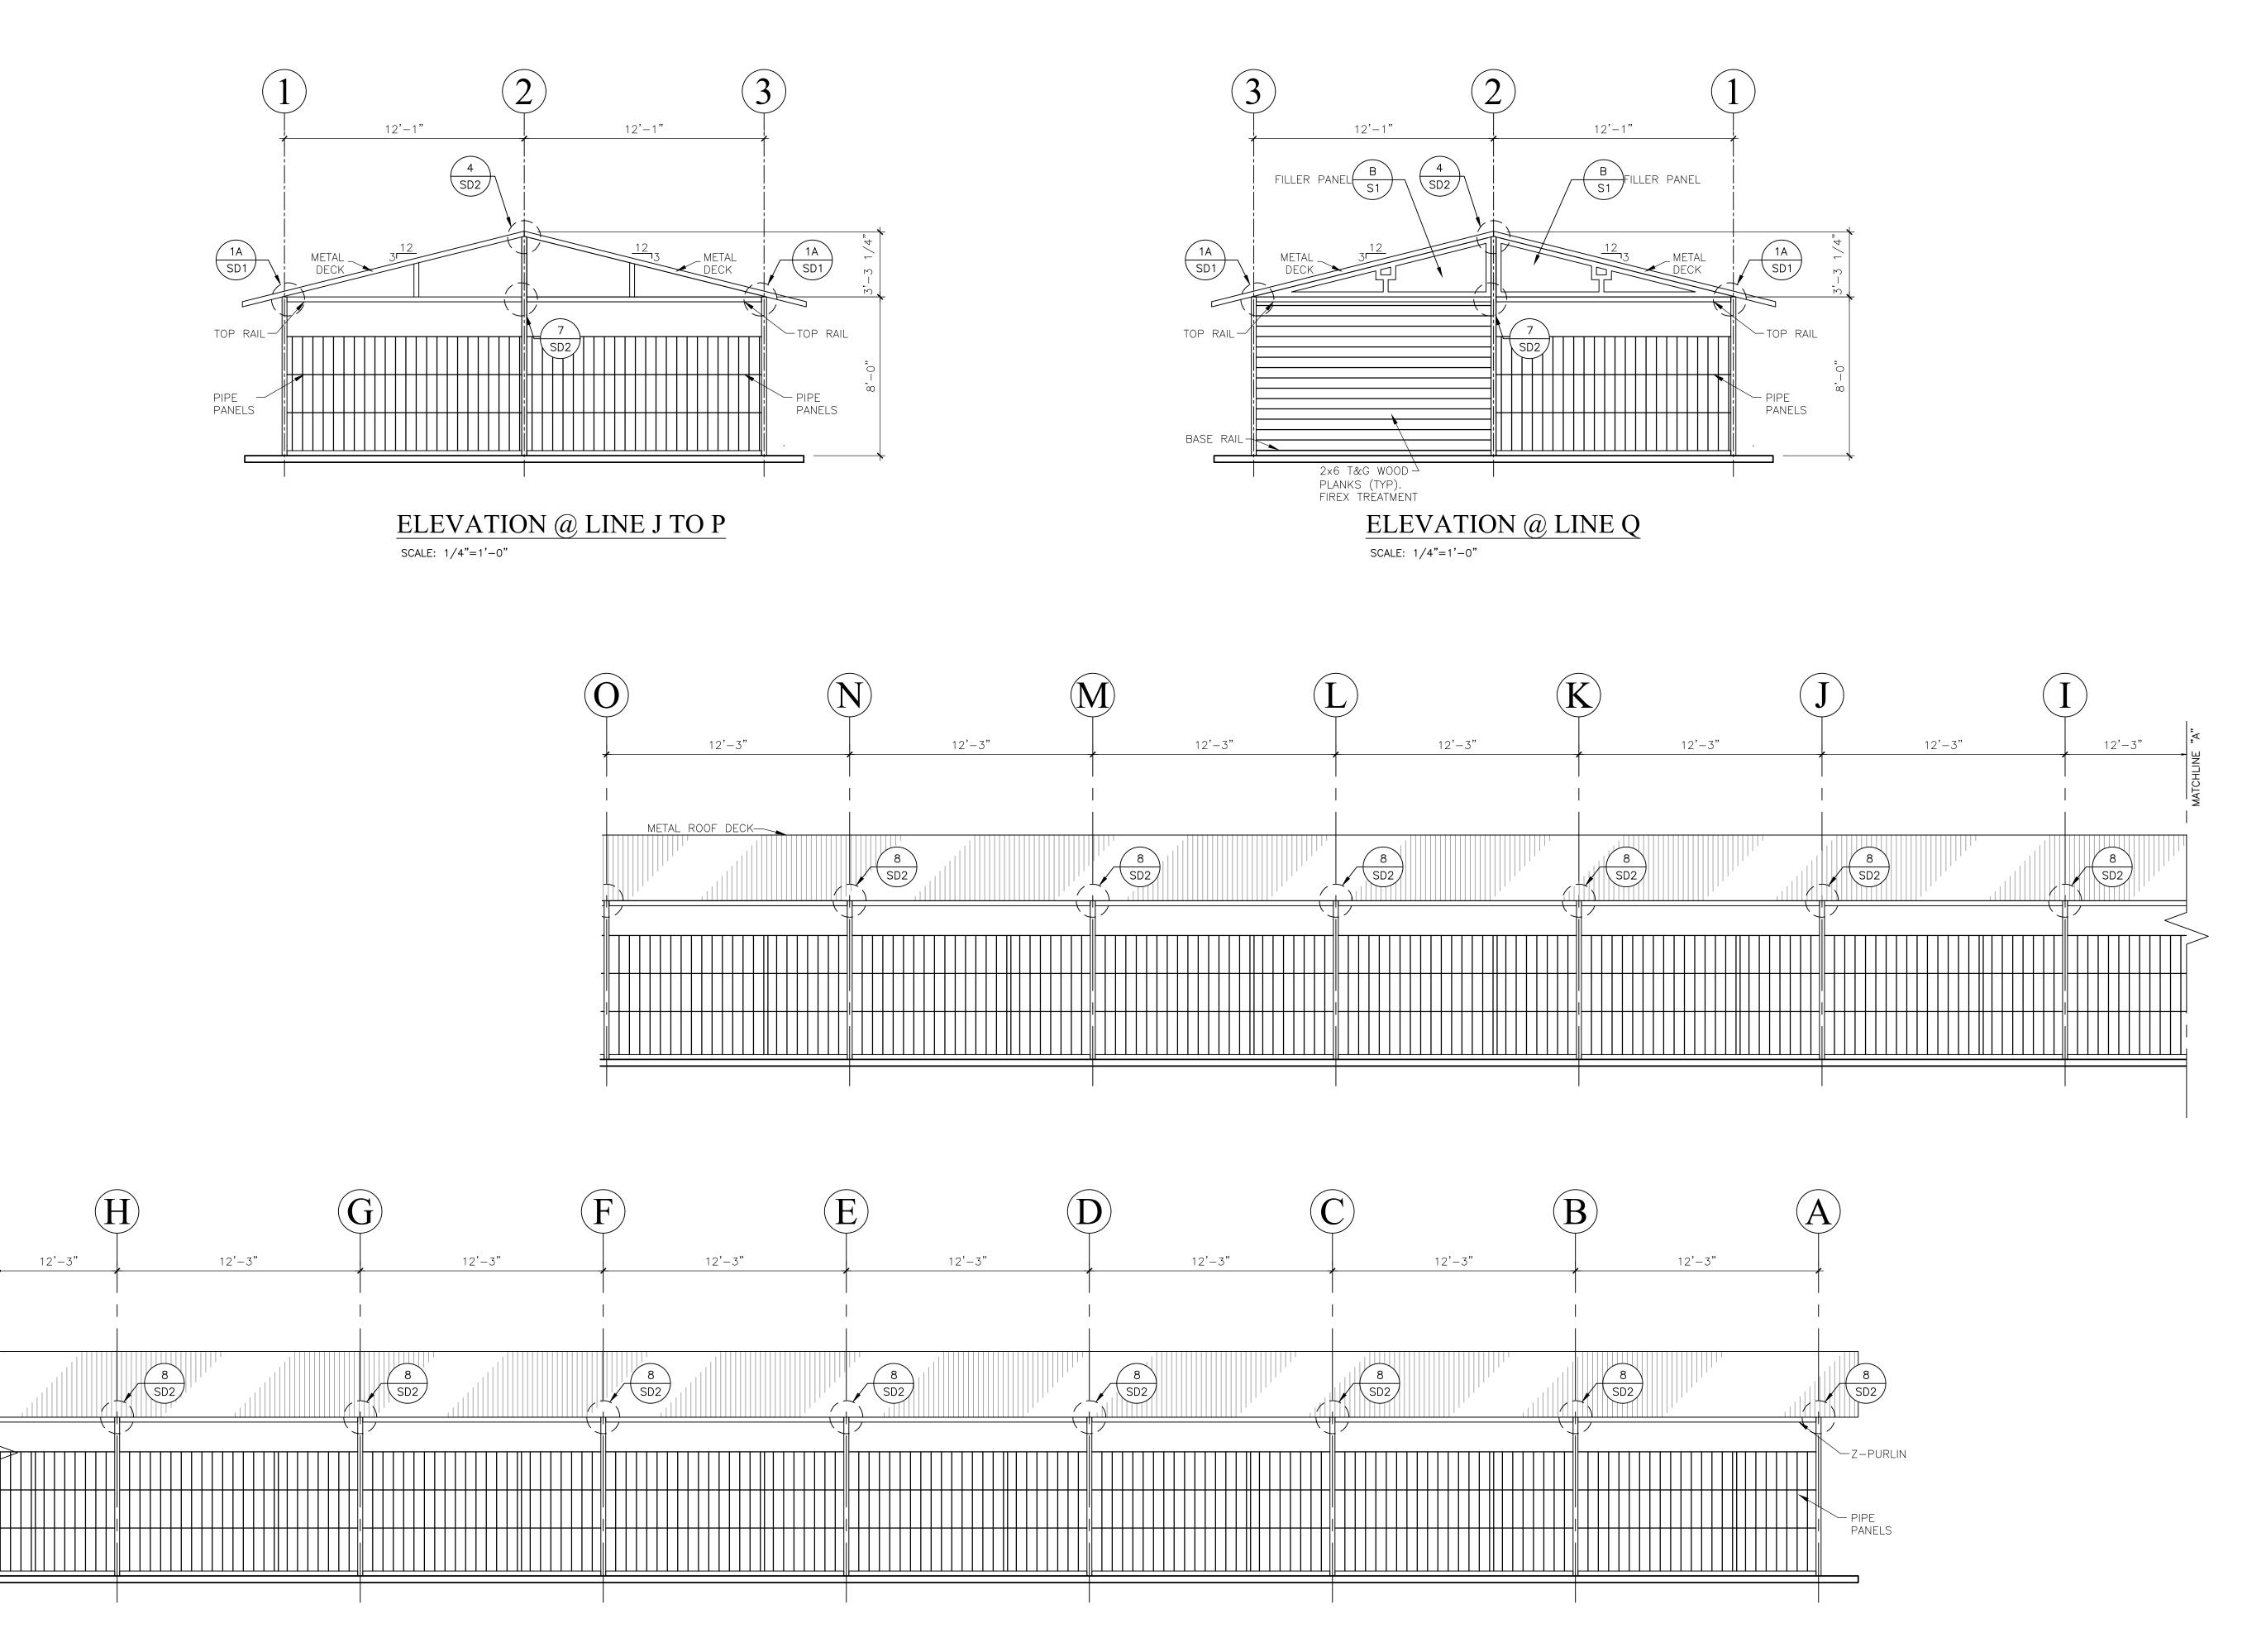
AR

or in whole without written approval of PLUMP ENGINEERING INC.

BARN

ASTLEBROOK

PA23-0145



ASSESSORS PARCEL NUMBERS 856-011-23 & 856-011-24

PA23-0145

SHEET NO:

PROJECT NO: S.2104027

CHECKED BY:


REVISIONS

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CASTI 1460 FONT






that all design criteria meets the requirements

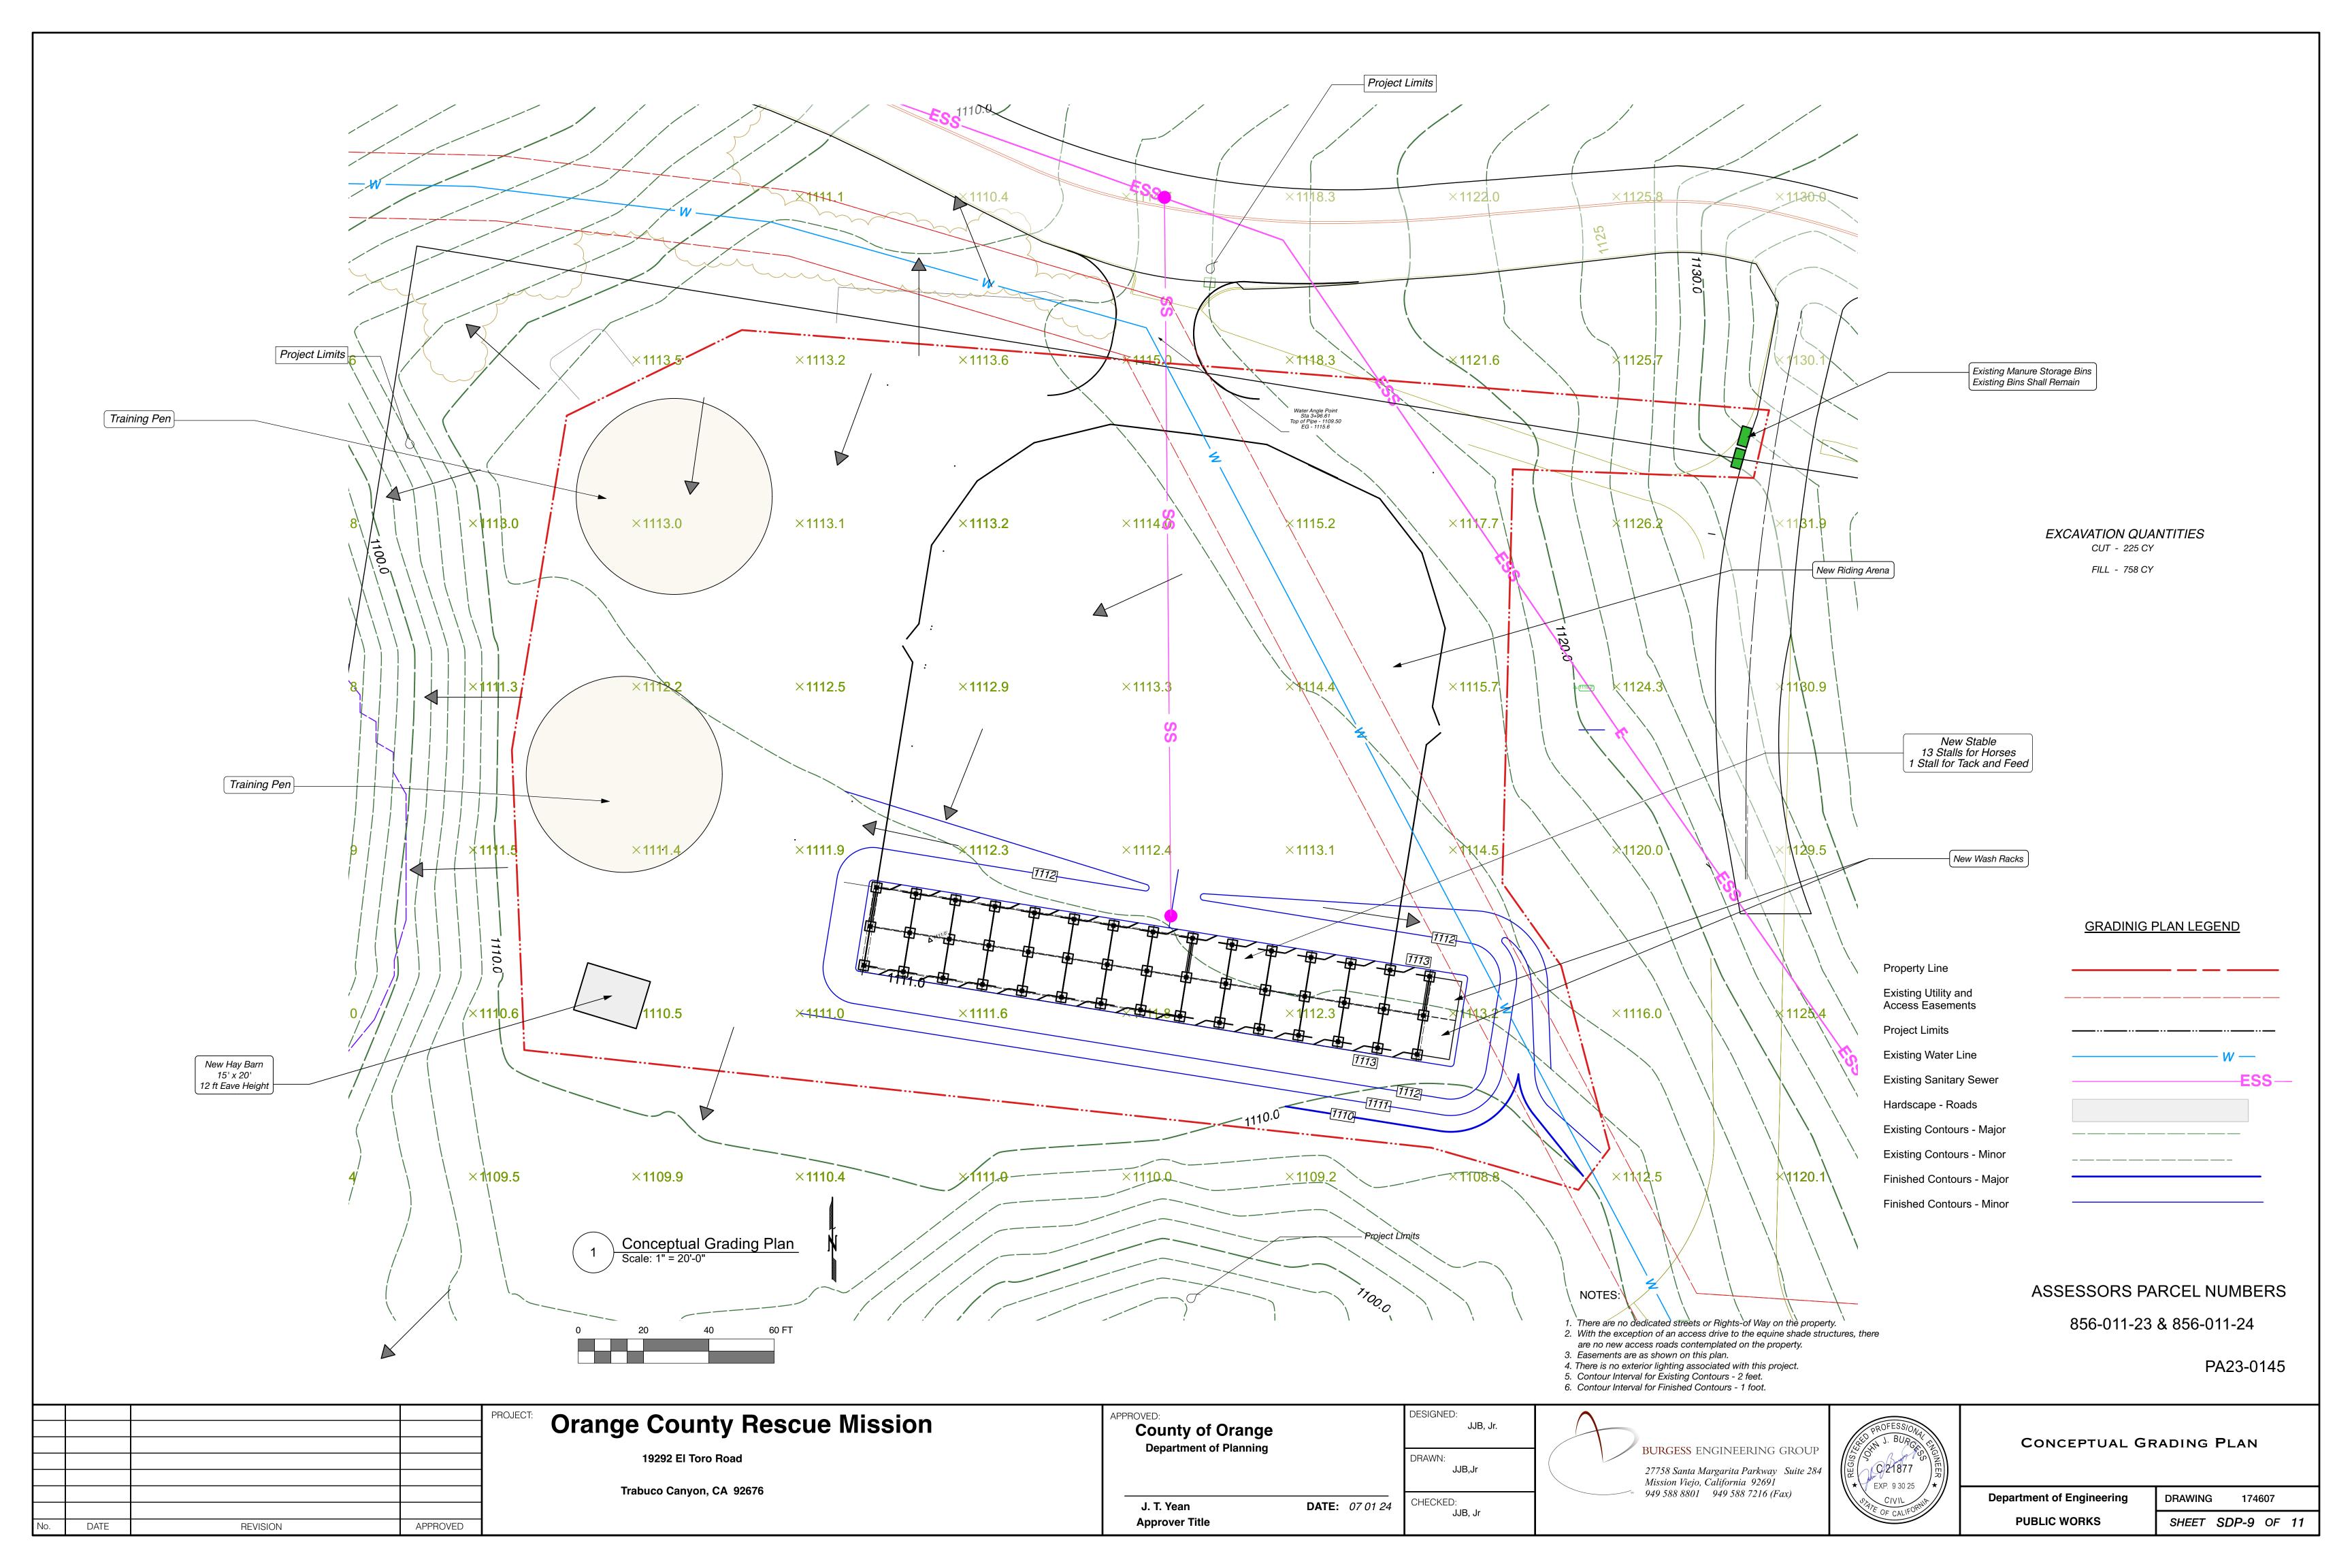for all local agencies, HOA, etc...

Prepared for: ___ *O.C.R.M.* CO#____(if applicable)

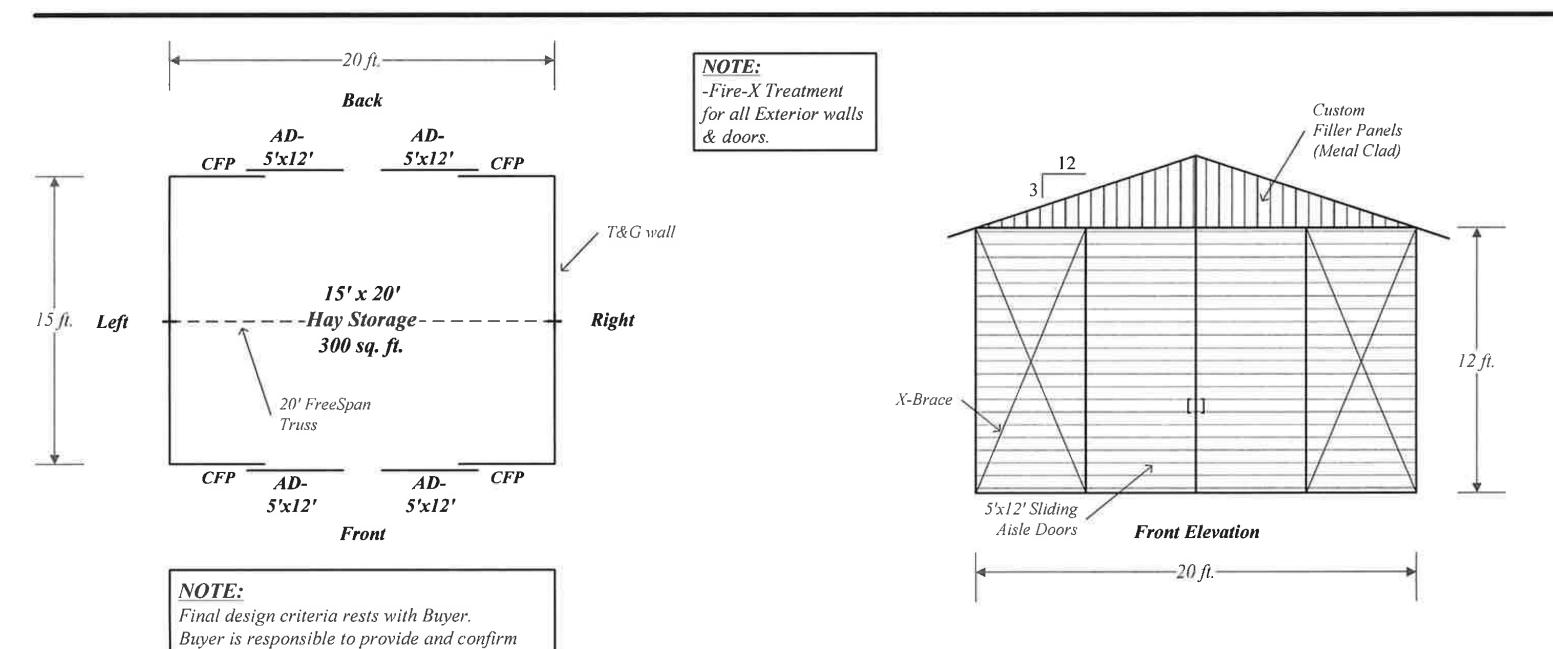

Design Notes

- Not For Construction
- All dimensions are Nominal. • Pictorial representations are for general design only.
- Actual design may vary per structure.
- X Bracing for lateral support is part of CB's standard design. The location and quantity of X Brace will be determined once CB's production commences. Final X Brace locations may affect window, grill or barwork, and accessory placement. Therefore the customer should make special note of this when determining window or accessory placement.
- Unless specifically dimensioned on this drawing, all framed openings, doors and windows shall be located against the nearest post with the height to be set by the installer.
- Upper and lower RCA roof pitches vary slightly. Shedrow overhang roof pitch vary slightly from the roof pitch over the stall depending on overhang size.

Design Criteria

CB's standard will meet or exceed the following:

Design Code CBC 2022 Wind Load Exposure C 20# Foundation 90 MPH 3 Sec. Gust Structural 110 MPH 3 Sec. Gust Seismic Zone 4

Unless specifically denoted to the contrary on the contract these design values shall be used. SSD-6 = 6' Solid Sliding Door DC/T&G = Drop Ceiling/ Tongue and Groove SDD = Solid Dutch Door GD GSD = Grilled Sliding Door WR

GDD = Grilled Dutch Door HP GYD = Grilled Yoke Door HFW BSD = Barred Sliding Door FVW BDD = Barred Dutch Door FP

MD = Man Door AD = Aisle Way Door FW = Feed Window

BYD = Barred Yoke Door FP/T&G

XXX = Grilled Front/Divider BWS (((= Barred Front/Divider FM SFD = Solid Feed Door GFD = Grilled Feed Door BFD = Barred Feed Door

Key
SSD = Solid Sliding Door DC/T-1-11 = Drop Ceiling/T-1-11 = Groom Stall Divider

> = Wash Rack = Hitching Post = Hinged Foaling Wall = Foal Viewing Window = Filler Panel/Metal

> > = 3X3 Glass Window

= Filler Panel/Tongue and Groove = Open Window/Shutter = Grilled Window/Shutter = Barred Window/Shutter = Feed Manger

= Automatic Waterer = Post





Hay Storage Shed
Scale: Not To Scale

ASSESSORS PARCEL NUMBERS

856-011-23 & 856-011-24

PA23-0145

APPROVED DATE REVISION

Orange County Rescue Mission

19292 El Toro Road

Trabuco Canyon, CA 92676

County of Orange Department of Planning

DATE: 07 01 24 J. T. Yean **Approver Title**

DESIGNED:

DRAWN:


JJB, Jr.

JJB,Jr

JJB, Jr





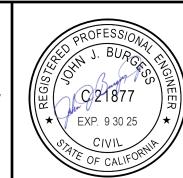

HAY STORAGE - MANURE STORAGE

Department of Engineering DRAWING 174607 **PUBLIC WORKS** SHEET SDP-10 OF 11

