Attachment 3

PROJECT INFORMATION:

<u>EXISTING</u>	
APN: CARRIER CODE: LOT NUMBER LAND USE CATEGORY LAND USE CODE: LEGAL DESCRIPTION:	502–283–09 C004 3 RESIDENTIAL(SINGLE FAMILY RESIDENTIAL) 122 N TR 4846 BLK LOT 3
(PROJECT ZONE:	125–E4–20000–"SMALL ESTATES"
EXISTING	

NUMBER OF STORIES: CONSTRUCTION TYPE OCCUPANCY GROUP SPRINKLERS FLOOD ZONE	ONE (1) V–B RESIDENTIAL(SINGLE FA NO NO	MILY RESIDENTIAL)
<u>EXISTING</u> LOT SIZE:	20,018	SF
(E) MAIN RESIDENCE (E) ATTACHED GARAGE	4,100 483	
<u>NEW</u> LOT SIZE:	20,018	SF
 (E) MAIN RESIDENCE (E) ATTACHED GARAGE (N) 10 FEET HIGH FENCE (N) POOL (3'-1/2" TO 6'-1 	4,100 483 86	SF

75 SF

BASKETBALL COURT FENCE & POOLS ADDITION HOME IMPROVEMENT PROJECT

PLOT PLAN:	SCALE:	1/16"	=	1'-0"

(E) LOT = 20,018 SQ. FT.

PROJECT DIRECTORY:

<u>OWNER</u> NAME:

CONTACT ADDRESS:

(N) SPA POLL (18" DEEP)

PHONE: EMAIL:

<u>DESIGNER</u> NAME: CONTACT:

ADDRESS:

PHONE: EMAIL:

STRUCTURAL ENGINEER NAME: CONTACT: ADDRESS:

ENGINEER LICENSE NO .: PHONE: EMAIL:

POOL DESIGN ENGINEER CONTACT: ADDRESS: ENGINEER

LICENSE NO .: > PHONE: EMAIL:

<u>CONTRACTOR</u> NAME: CONTACT: ADDRESS: LICENSE NO .: PHONE: EMAIL:

EDON KAGASOFF 1386 GALAXY DR., NEWPORT BEACH, CA 92660 949-939-2063 edon20@gmail.com

CRE8 DESIGN + ELEAZAR GRAHAM 4160 TEMECAL CANYON RD STE.410 CORONA, CA 92883 951-278-5609 eleazar@cre8designplus.com

DENMARK ENGINEERING DESIGN CLIFFORD T. DENMARK P.E. 6101 FOXCROFT AVENUE, LAS VEGAS, NV 89108 CLIFFORD T. DENMARK P.E. No. 24651 619-565-5942 cliff@dedlv.com

CWPP 150 HOLGATE LA HABRA, CA 90631 1012751 C-53 714-512-1372

"TBD"

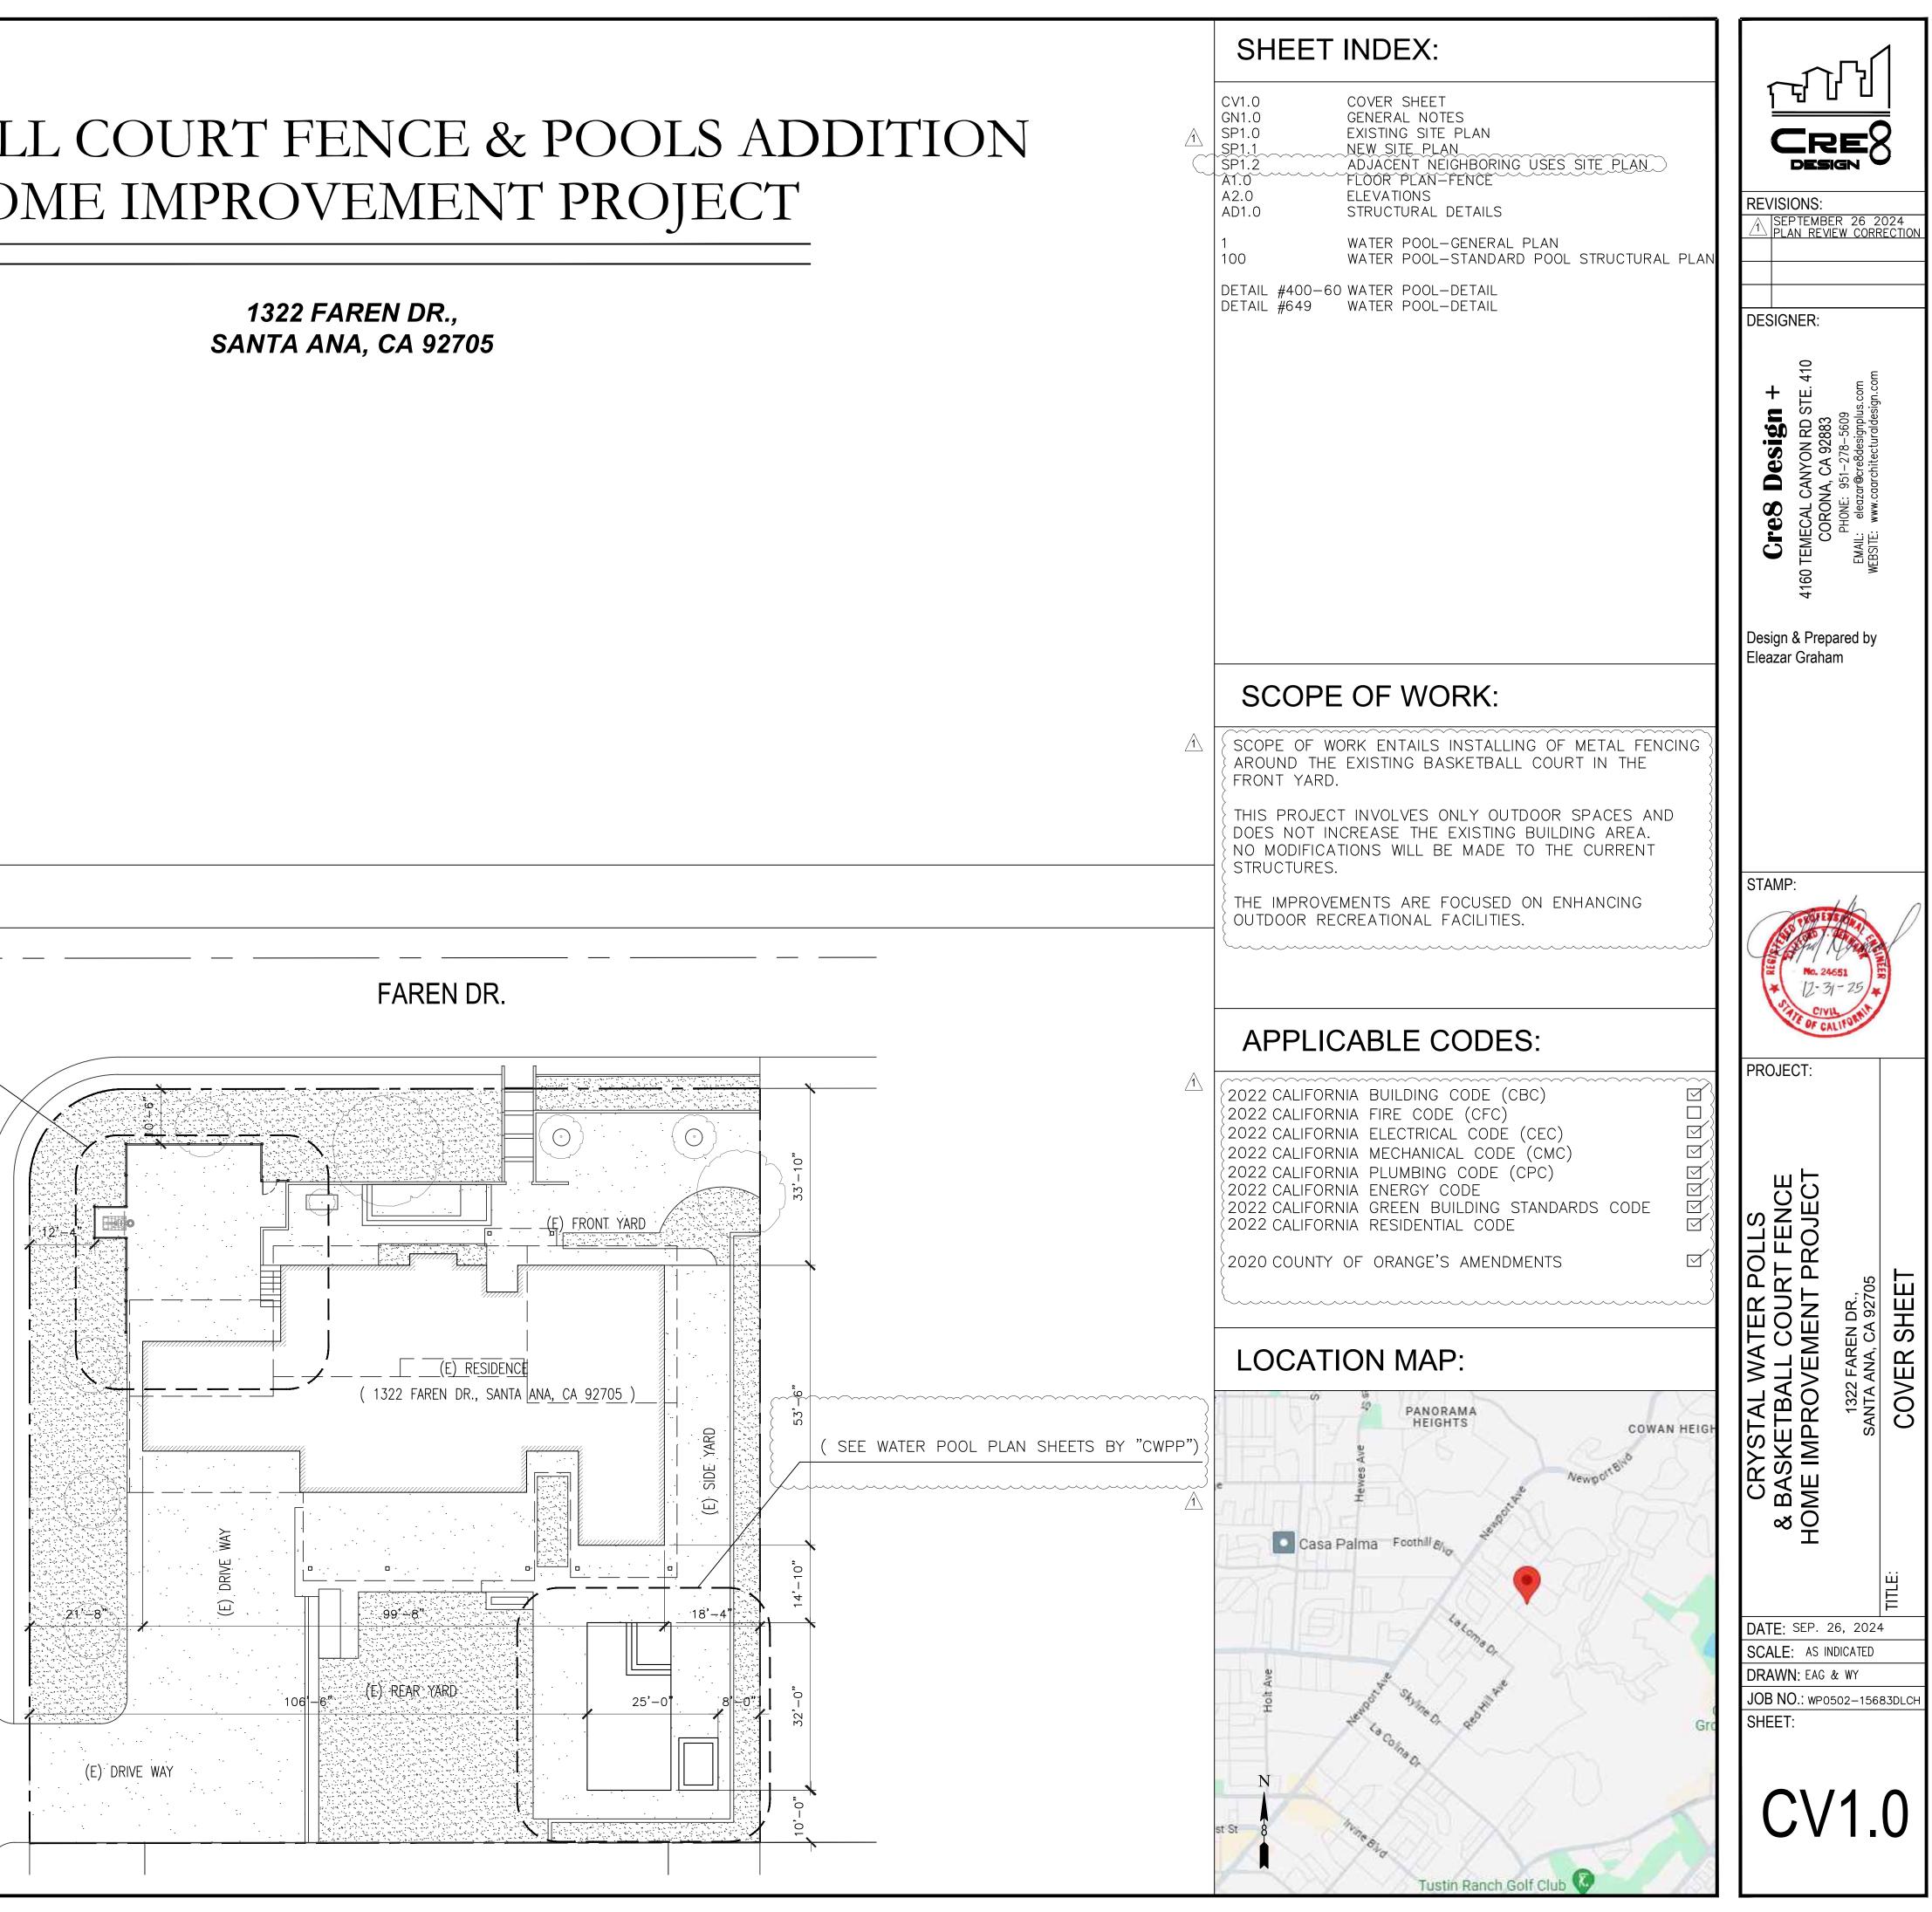
SCOPE OF WORK

(PROPOS A NEW IRON FENCE)

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CIELO

1322 FAREN DR.,



DIVISION 01 - GENERAL NOTES

- 1.1 It shall be the General Contractor (and/or) the sub-contractor's responsibility to verify all dimensions, details, and job site conditions prior to proceeding with the work, and report any discrepancies to the Architect before starting construction.
- 1.2 All information shown on the drawings relative to existing conditions is given as the best present knowledge, but without guarantee of accuracy. Where actual conditions conflict with the drawings, they shall be reported to the Architect so that the proper revisions may be made.
- 1.3 The Contract drawings and Specifications represent the finished structure and do not indicate the method of construction. The Contractor shall supervise and direct the work and shall be solely responsible for construction means, methods, techniques, sequences, and procedures, including, but not limited to, bracing and shoring. Observation visits to the site by field representatives of the Architect / Engineer shall not include inspections of the protective measures or the construction procedures. Any support services performed by the Architect / Engineer during the construction shall be distinguished from Contract and detailed inspection services which is furnished by others. These supportservices performed by the Architect/Engineer, whether of material or work, and whether performed prior to, during, or after completion of construction, are performed solely for thepurpose of assisting in quality control and in achieving conformance with Contract documents, but do not guarantee Contractor's performance and shall not be construed as supervision of construction.
- 1.4 All materials and workmanship shall conform to the requirements of the 2022 CBC and COUNTY OF ORANGE 2022 Amendments and all other applicable codes, regulations and laws.
- 1.5 In no case shall working dimensions be scaled from plan or details. Figures on drawings govern scaled measurements and larger scale governs smaller scaled drawings.
- 1.6 Contractors and sub-contractor's shall coordinate with representatives of water, electric, gas, telephone and cable T.V. companies to verify available facilities.
- 1.7 If due to the nature of material or method of construction, details or dimensions as shown on drawings or specified cannot be satisfactorily achieved, the contractor or sub-contractor shall immediately advise the Architect and request any adjustment he considers necessary for the proper execution of the work, this request shall be made before any material is ordered or fabricated. Any unsatisfactory work that develops during fabrication or installation shall be corrected at the Contractor's expense, if the Architect has not been notified.
- 1.8 The Contractor and his sub-contractors shall coordinate their work with adjacent work and cooperate with each other so as to facilitate general progress of work. Each trade shall afford other trades every reasonable opportunity for installation of their work and for storage of their materials. The Contractor shall coordinate all work at the site. All discrepancies shall be called to the attention of the Architect and be resolved before proceeding with the work.
- 1.9 General Notes and Typical Details shall apply to all parts of the job except where they may conflict with Details and Notes on other sheets. Where conditions are not specifically indicated, but are of similar character to Details shown, similar Details of construction shall be used subject to review by the Architect.
- 1.10 Each sub-contractor shall verify and check all dimensions, conditions, grade elevations, and recipient surfaces to determine their suitability to receive required additional construction and finishes. Report immediately any defects in any recipient surfaces or conditions to the Owner in writing.Commencing work indicates acceptance of conditions and surfaces as being satisfactory.
- 1.11 The General Contractor shall be responsible for obtaining and paying for all permits and fees required, not normally covered by the general building permit.
- 1.12 Typical Details shall be used where applicable, and only when no specific detail is shown.
- 1.13 Any proposed substitutions to the materials or equipment specified by manufacturer's name or trade name, shall be equal or superior to the original or contract in all respects. Architect must be notified in writing. At the Architect's option, detailed specifications, performance data, or samples may be required to be submitted to substantiate the claims of equality.
- 1.14 Bidder's attention is directed to the requirements of the State of California Business and Professional Code, Division 3, Chapter 9, known as, and ordinarily cited as the "Contractor's License Law". Contractors and sub-contractors, at the time of submission of the Bid, must have the appropriate licenses for the work to be performed under the Contract.
- 1.15 Each bidder shall include all costs of maintaining insurance in compliance with the provisions in the Conditions of the Contract. No successful bidder shall commence work until a Certificate of Worker's Compensation Insurance and Liability Insurance naming General Contractor and Owner as additional insured is delivered to General Contractor.
- 1.16 Sub-contractor shall guarantee all work and material for a period of one year from the date of completion.
- 1.17 Omissions of conflicts between the various elements of the Working drawings and/or Specs. shall be brought to the attention of the Architect prior to proceeding with any work involved.
- 1.18 Definition of similar: Nearly, but not exactly the same, having a resemblance.
- 1.19 A pre-construction meeting with the Architect is required prior to building these plans.
- 1.20 Inspections are required by the architect during all phases of construction. No walls shall be covered up without the Architects approval.
- Building permits shall be presumed to incorporate the provision that the 1.21 contractors shall carry out the proposed work in accordance with the approved plans and with all requirements of the code and any other laws or regulations applicable thereto, whether specified or not. No approval shall relieve or exonerate any person from the responsibility of complying with the provisions and intent of the code.

SUBDIVISION 6800 - FINISH CARPENTRY See schedules and interior elevations. 25 lineal feet of exterior wall, with one opening with

- 6800.1 Provide all materials, tools, appurtenances, and equineers ary to complete all Wood Finish, Cabinet Work, as indicated on the drawings and/or described in the Work shall consists of but not necessarily be limited
 - Schedule Of Work To Be Included:
 - Visiting the site prior to bidding. Studying the complete bid documents. Interior trim including, but not limited to the foll Base
 - Casing Handrails at all stairs
 - Doors
 - Wood shelvina Field measurements and instructions
 - Cooperation with others Laminate plastic counter and splash at back bar Apron under all bar tops as needed.
- 6800.2 Grading Plywood
 - A. For general purposes, shall be Douglas Fir, Grade Cabinet doors shall be Grade Birch B or better.
- B. For general shelving purposes, shall be Douglas Fir edge banded with "B" or better Douglas Fir, with su 3'-0" o.c. Ó.C.
- 6800.3 Grading Cabinets and Case Work A. Drawers shall be provided with Garcy No 393 ball
 - self-closing drawer glides. B. Clothes poles shall be 1-1/4" round chrome rods, intermediate supports for spans longer than 4'. No hardware allowa'n'ce.
 - C. Submit shop drawings for all cabinet work for appl

6400.4 Grading – Sliding Door Hardware Furnish and installed by General Contractor. Hardw sliding doors between Living Room and Den shall be Hardware 7000 or equal. Complete with interlockin sliding of each pair into side pockets.

6800.5 Trim

- A. Door trim -1-5/8" doubled casing, finger joi
- B. Base trim -2-1/4" reversible, finger joint pin

C. Window trim — 2—11/16" with round edge apro finger joint pine.

6800.6 Handrails

2-1/4" oval flat bottom d.f. stained. Required at

DIVISION 07 – THERMAL & MOISTURE PROTECT SUBDIVISION 7100 - Insulation Shop drawing submittal required

7100.1 Mineral fiber type, conforming to Federal Specificat Type II or III and meets CEC quality standards.

7100.2 Each batt shall be marked with the "R" value of only — not the installed "R".

7100.3 Furnish and install mineral wool insulation batts as Johns-Manville. Owens-Corning Fiberglass, or approv accordance with manufacturer's printed instructions. of "R" values as follows:

Roof/ceiling R-30 Stud-exterior R-13 Interior- wall R-11

Eloor (over unheated) R-19 Floor (over exterior space) R-19

7100.4 Upon completion of the installation of the insulatio and the insulation applicator shall execute a card constalled in conformance with Art chapter 1, Chapter 1, Title 25, of the California Admi The card must be posted in a conspicuous location of building prior to find insuration

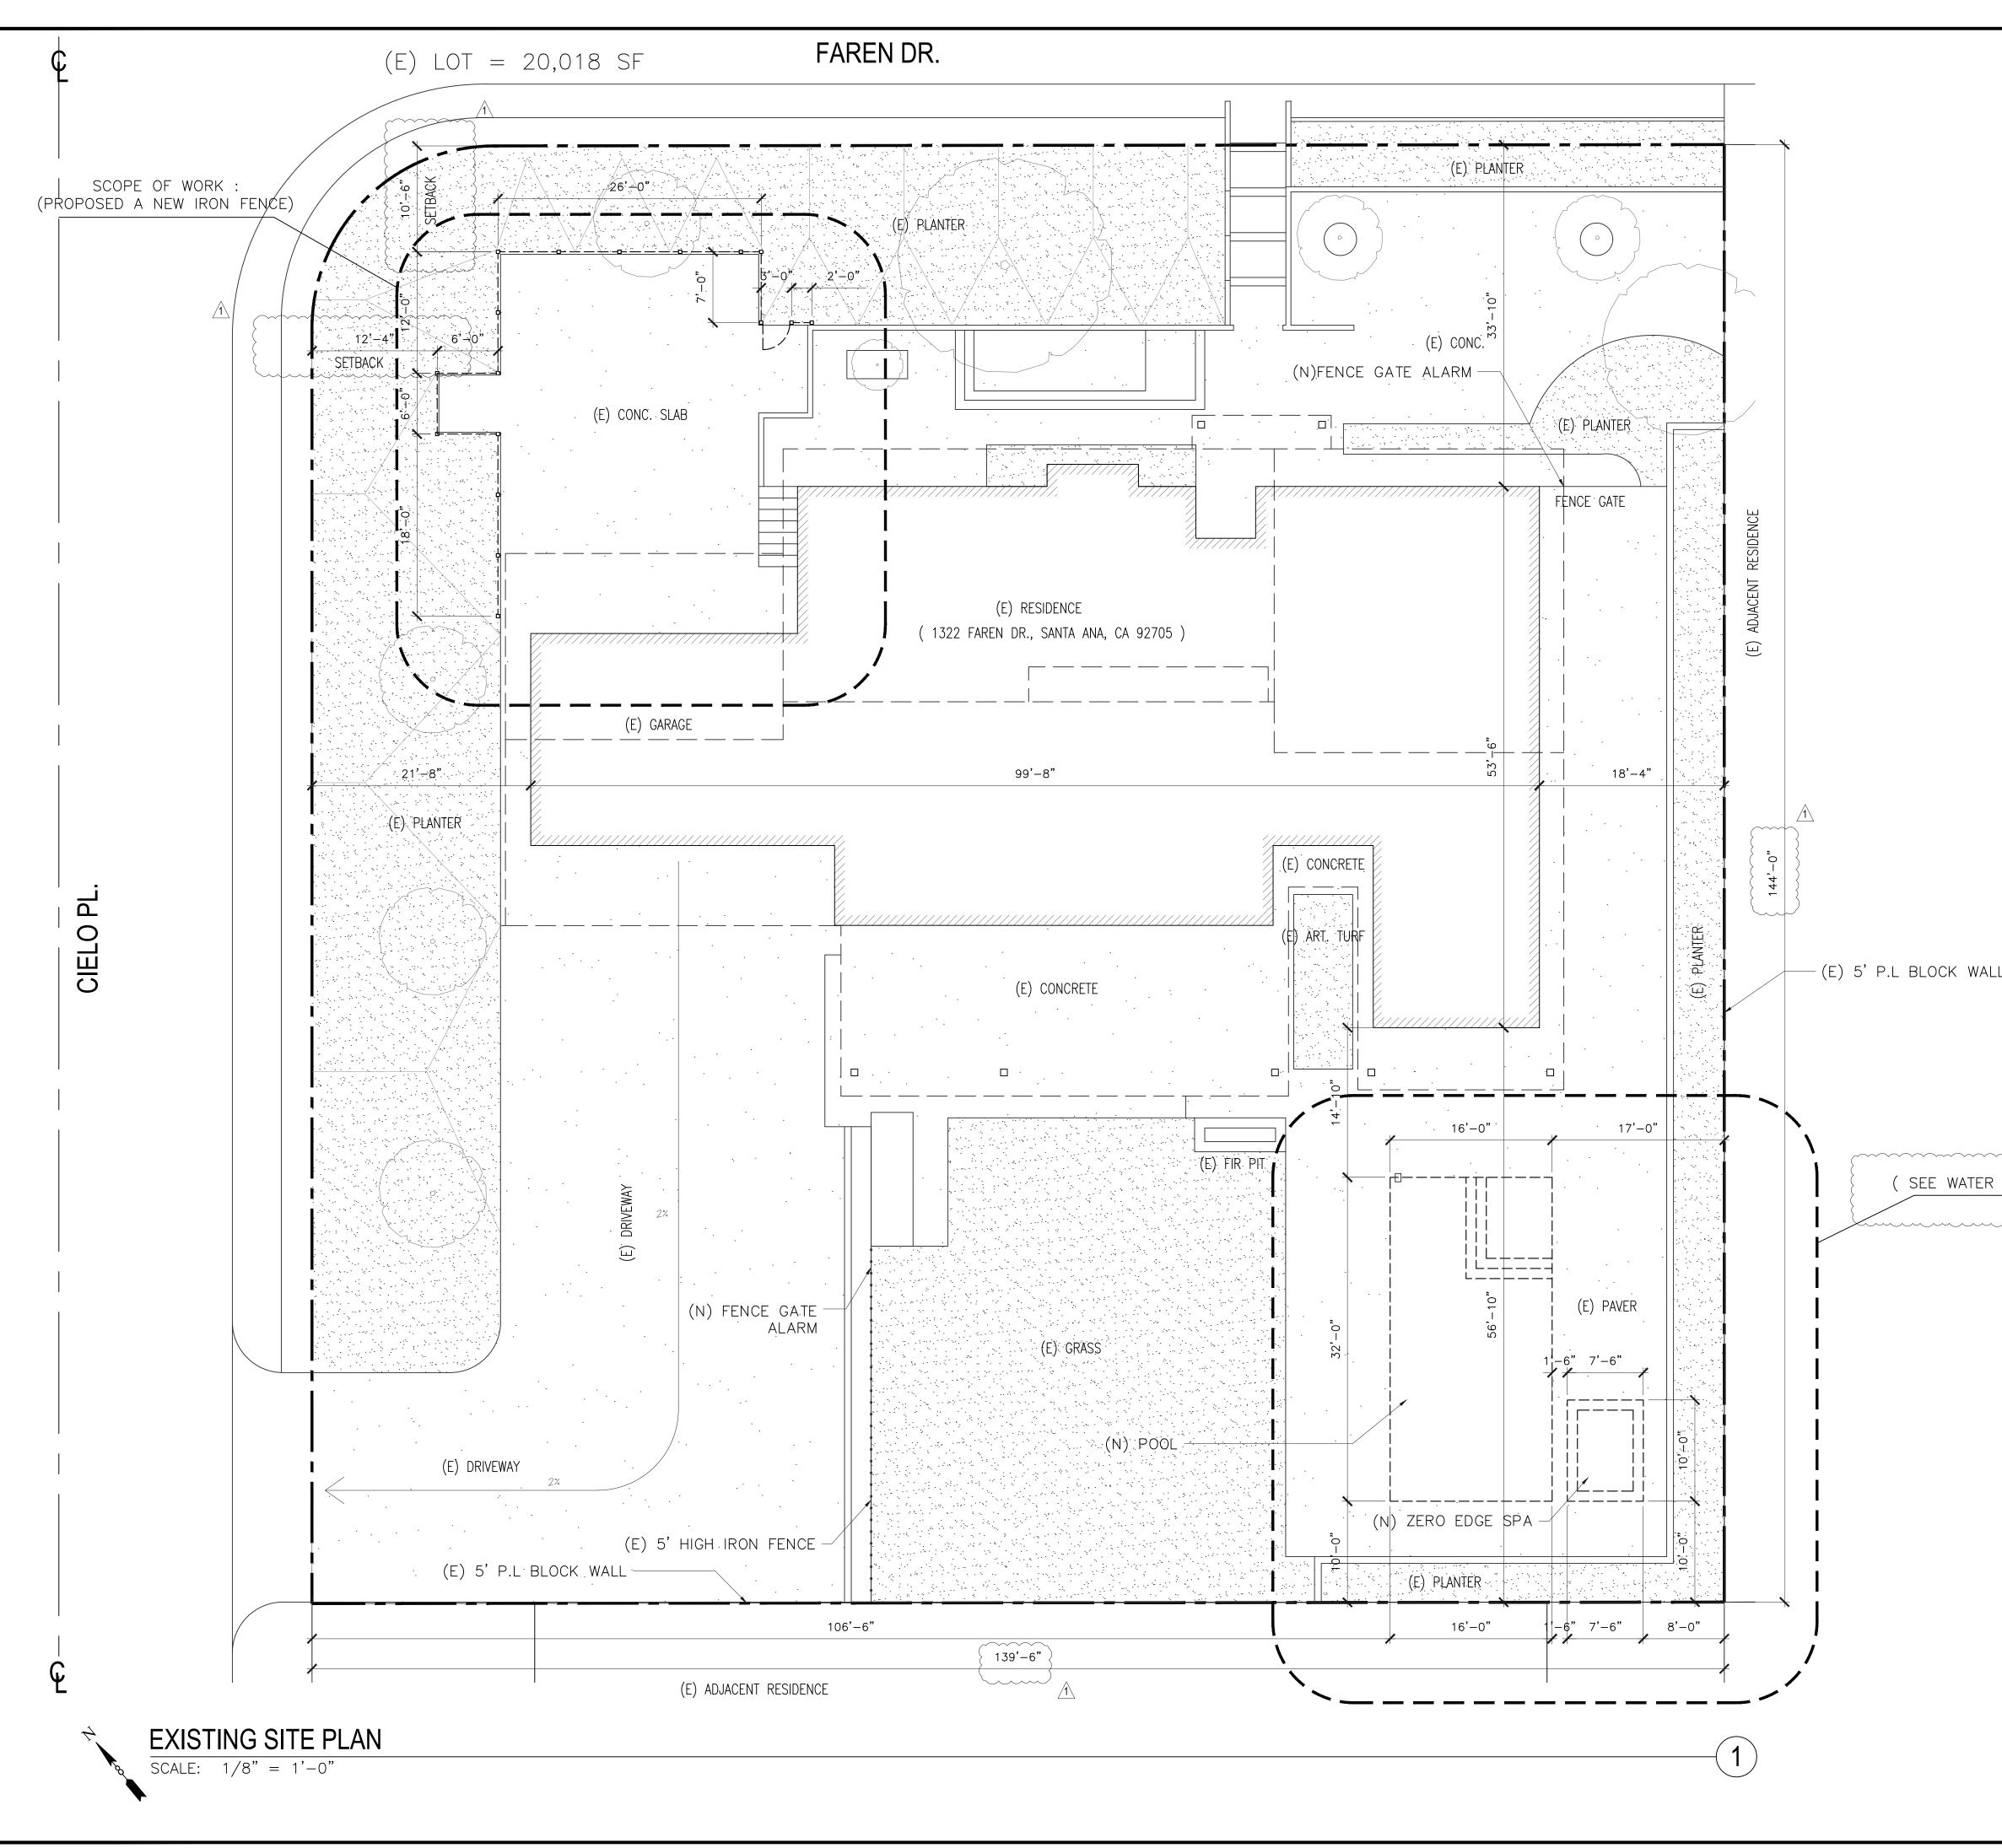
building, prior to final inspection. 7100.5 At plumbing walls, with waste lines only, stud space

insulated.

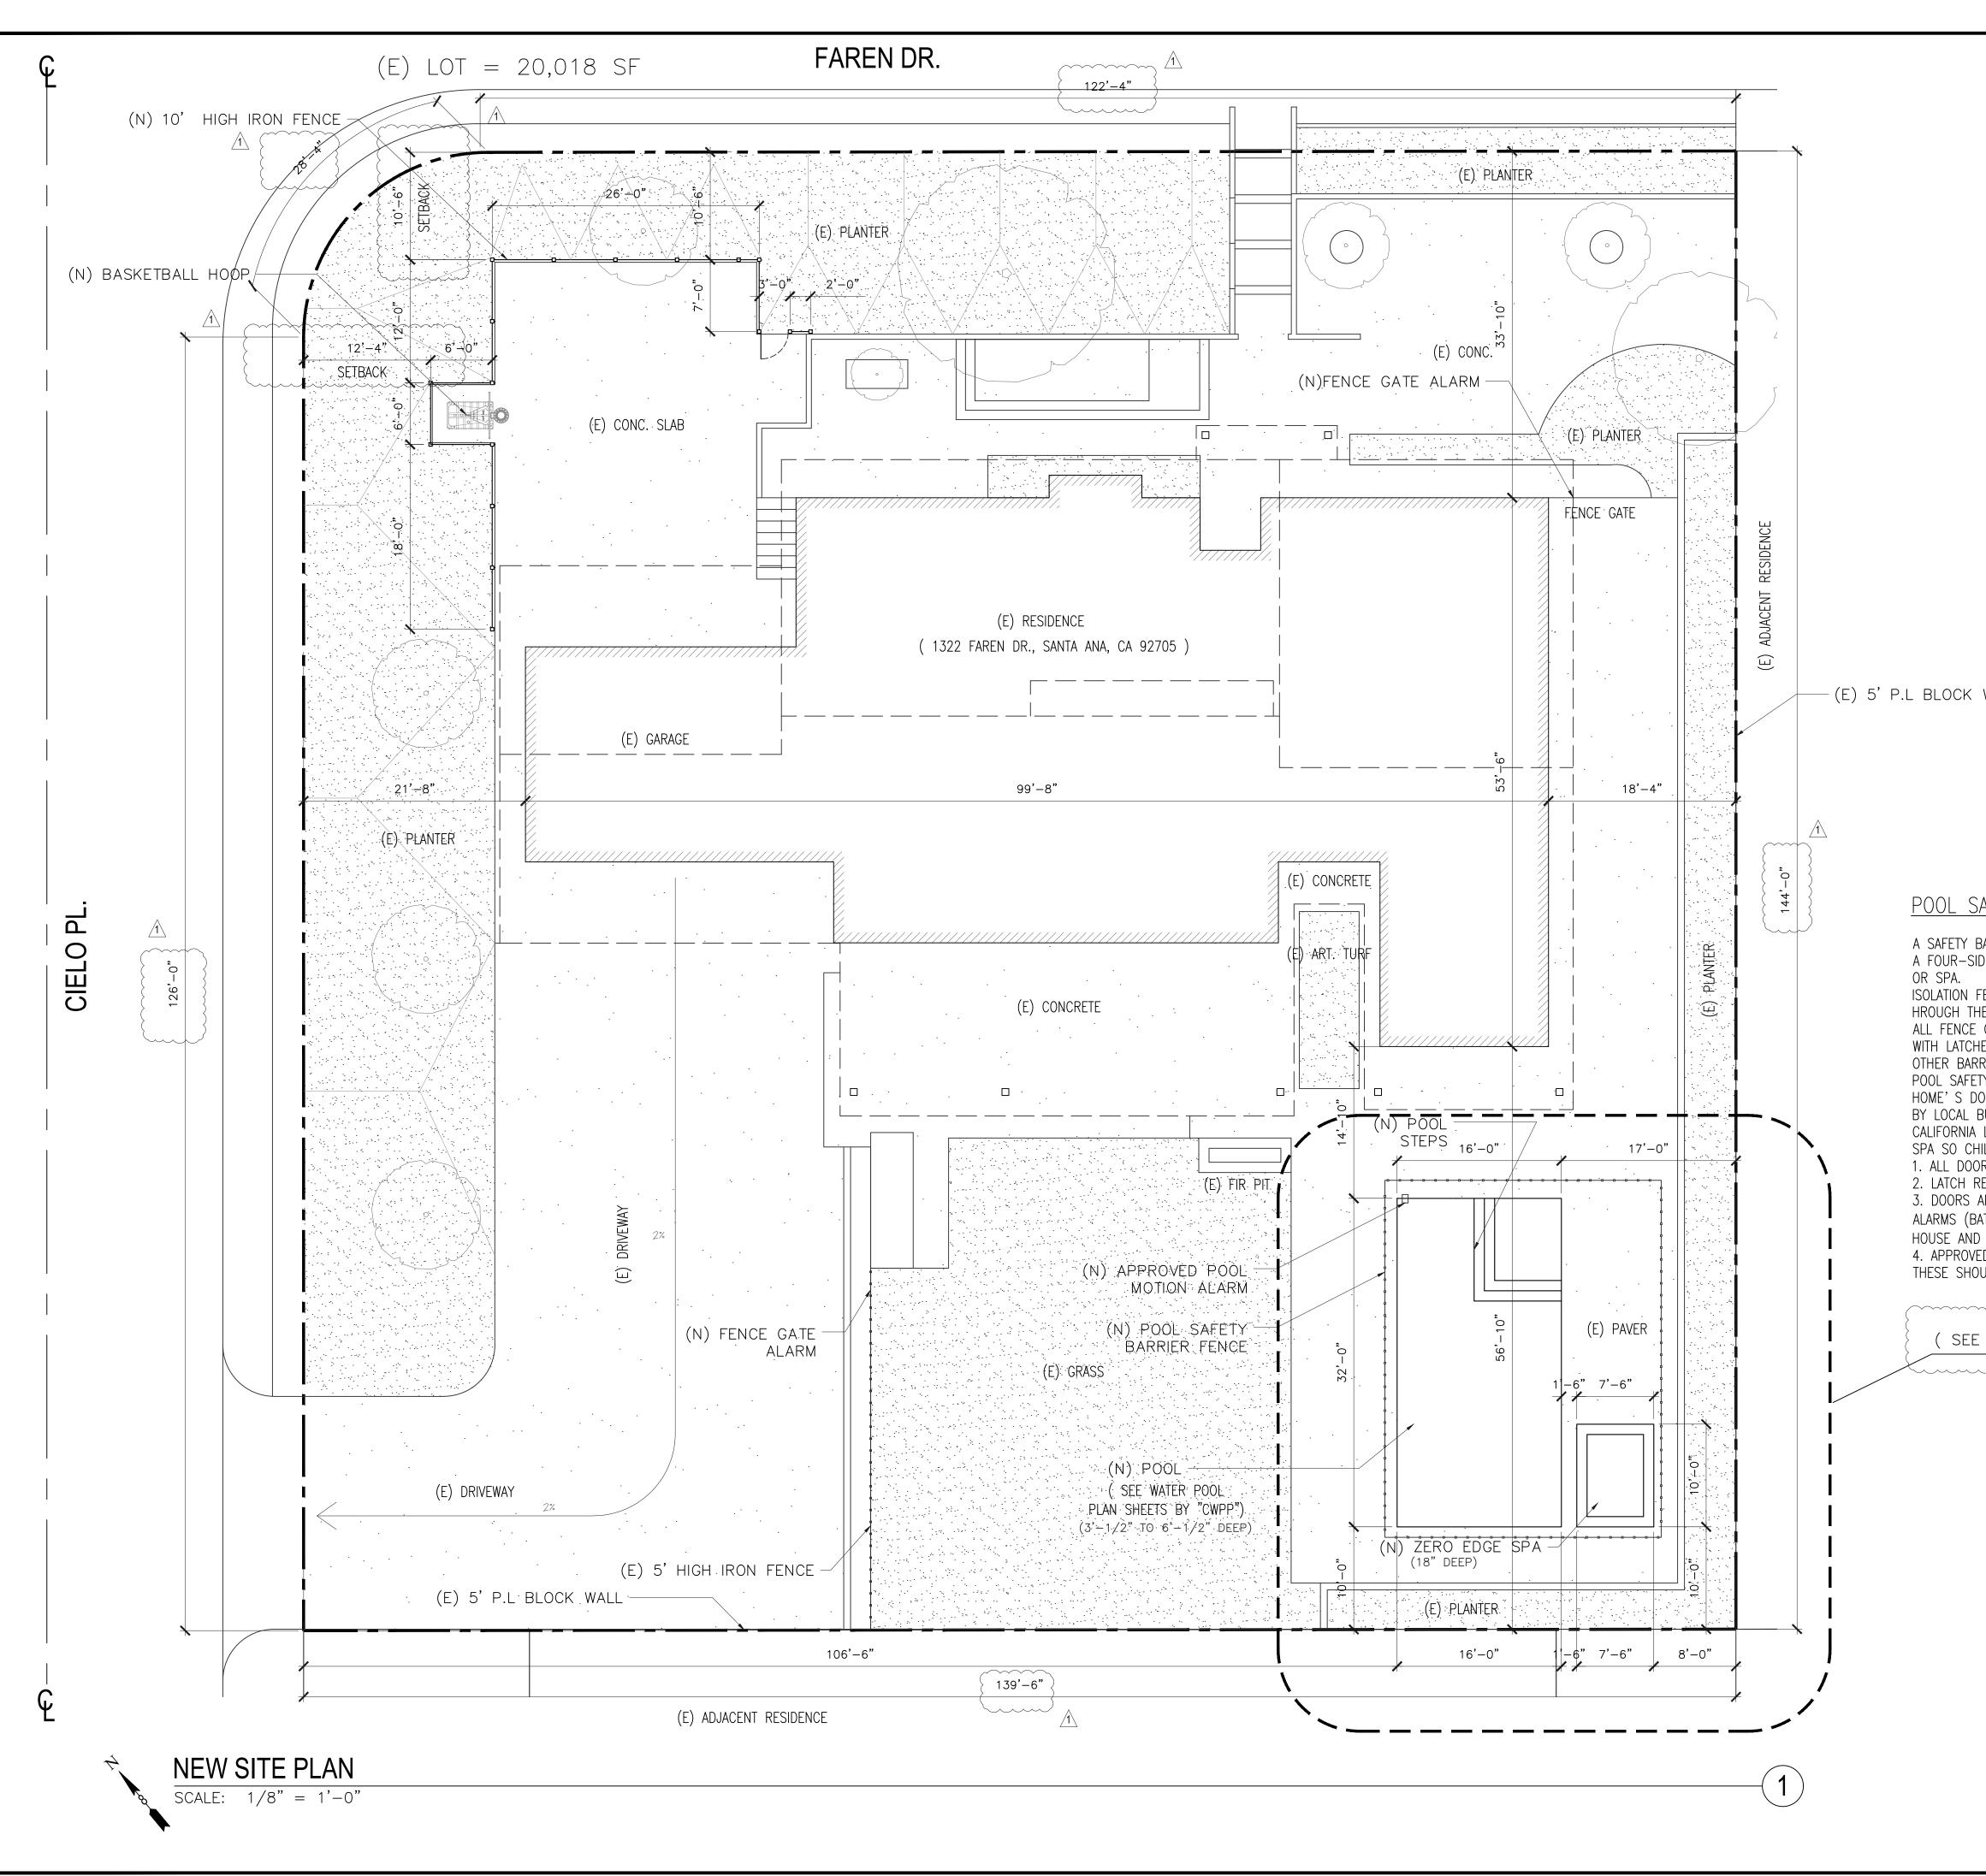
7110.6 Insulation used in sound control assemblies may b or mineral wool, but the material should have at lea to provide proper acoustical absorption.

	SUBDIVISION 7200 - Roofing	8800.1
in 3 feet of end	All work to conform to 2022 CBC and COUNTY OF ORANGE amendments. Also, see structural notes and specifications. Shop drawing submittal required.	8800.2
quipment , and Millwork jese Specification.	Installation as per manufacturer?s recommendations. For additional info see Spec—1 for Ice & Water shield.	8800.
to:	7200.1 Guarantee — Contractor shall guarantee all material and workmanship for a period of two years from the date of completion. Material awareness as specified.	
llowing:	7200.2 Independent roof inspection is required during and at the completion of work to certify approved certification.	
	7200.3 Underpayment to be minimum of 30 lb. typical. 7200.4 Hips and Ridges — Should be fabricated to attain harmonious appearance. Use strip of 30# felt about 12" wide over the crown of	
r.	all'hips and ridges. ' " 7200.5 Valley and Flashing — All valleys to be under laid with a strip of 30# felt applied over sheathing and extend at least 10" on each side of center line. Roof valley flashing to be not less than 24 gauge galvanized metal extending at least 18" each way from centerline, and have a splash diverter at least 1" high at the flow line section of flashing to overlap a minimum of 6".	8800.
A-C,	galvanized metal extending at least 18 each way from centerline, and have a splash diverter at least 1" high at the flow line section of flashing to overlap a minimum of 6". 7200.6 Sloped Roof—See plans for specifications	
r supports	7200.0 Sloped Root-See plans for specifications 7200.7 Supply all roofing sheet metal or coordinate with sheet metal sub-contractor	8800.
-bearing,	All work to conform to 2022 CBC and COUNTY OF ORANGE Amendments and SMACNA. Also, see details and specifications. Shop drawing submittal required.	
, with t a part of	7400.1 Sub-contractor shall furnish all material, labor, equipment, services, and competent supervision to install the sheet metal work.	8800.
proval.	7400.2 Sheet metal contractor shall fabricate and install ALL FLASHING REQUIRED FOR WATERTIGHT JOB, and not be limited to the following:	8800.
	 A. Scuppers and flashing for all balconies and entries. B. Copings and gravel guards, when gravel roof. 	
lware for double	C. All attic vents, see Attic ventilation calc. On roof plan.	
be Grant Sliding ing hardware for	D. Drip flashings — hemmed exposed edges ? 1 piece. E. Flashings at roofs and planters and pot shelves.	
int pine.	7400.3 Supply and install mechanical exhaust fan ducts, Z-bar flashing, roof to wall flashing, coping on all parapets, gravel slops, downspouts, leader heads and gutters, and plaster base screeds.	8800. 8800.
ne. on	7400.4 Supply and install Z-bar flashing, roof to wall flashing, coping on all parapets, gravel stops, downspouts, scuppers, leader heads and gutters, and plaster base screed. Coordinate with roofing sub-contractor.	8800.
t all stairs.	7400.5 All sheet metal shall be 26 gauge bonderized unless otherwise specifically noted.	8800.
TION	SUBDIVISION 7900 - Weather-stripping	
	All work to conform to 2022 CBC AND COUNTY OF ORANGE Amendments. Also, see structural notes and specifications. Shop drawing submittal required.	8800.
tion HH— 1—521e, the insulating fiber	7900.1 All exterior doors to receive 4" bronze anodized interlocking thresholds with spring type jamb and head weather—strip. Provide a rain strip on all doors exposed to weather. Provide a matching aluminum sill cover on all concrete slabs.	DIVIS
s manufactured by	7900.2 Install thresholds prior to carpet and subsequent to finish decking and/or all hard surface materials.	SUBDI
ove equal, in Install in areas	7900.3 All pairs of doors, if shown on plans, to receive matching door	9100.1
	T-astragal at center of opening. ' 7900.4 Caulk all exterior door thresholds with clear flexiseal sealant prior to	9100.2
	installation. 7900.5 All exterior doors and windows shall be fully weather stripped.	
on, both the Builder certifying that the ticle 5, Sub-	7900.6 Caulk all exterior joints around windows and door frames, between wall panels.	9100.3
ninistrative Code. within the	7900.7 Caulk openings for all electrical and plumbing penetrations. 7900.8 Flash all exterior openings with Moistop. all tape shall be tight.	9100.4
ce to be fully		9100.
be either fiberglass ast one open face	DIVISION 08 - DOORS AND WINDOWS Also see Door and Window Schedules	9100.0 9100.1
	Comply with The City Security Requirements	9100.8
	SUBDIVISION 8700 — Security — Finish Hardware 8700.1 All openings at ground floor are security opening and the following notes shall apply:	
	A. Swinging Doors: 1. All exterior in—swinging doors shall have one piece	9100.9
	rabbetted jamb. 2. All pin-type hinges which are accessible from	
	outside the secure area when the door is closed shall have non removable hinge pins.	9100.1 9100.1
	 The strike plate for latches and the holding device for projecting deadbolts in wood construction shall be secured to the jamb and wall framing with screws not less than 2-1/2" in length. 	SUBDI
	4. Deadbolts shall contain hardened inserts.	
	 Straight deadbolts shall have a minimum throw of 1" and an embedment of not less than 5/8". A book obspace on an averanding lug deadbolt shall 	9200.
	 A hook shaped or an expanding lug deadbolt shall have a minimum throw of 3/4". Wood flush type doors shall be 1-3/4' thick minimum 	
	 7. Wood flush type doors shall be 1-3/4' thick minimum with a solid core of wood or particle board of 25 pcf density. 8. Wood panel type doors shall be 1-3/8" thick 	9200.
	8. Wood panel type doors shall be 1-3/8" thick minimum with all panels fabricated from material not less than 3/8" in thickness provided all shaped portions of the panels are minimum 1/4" thick.	9200.
	B. Cylinder guards shall be installed on all cylinder locks whenever the cylinder projects beyond the face of the door or is otherwise accessible to gripping tools.	
	8700.2 Panic hardware required on all exit doors.	

ALUM SLIDING GLASS DOOR, WINDOWS & FIXED GLASS (See also - 8700 & 7900) To comply with The COUNTY OF ORANGE Code	
8800.1 Furnish all metal sash and pertinent hardware complete.	
8800.2 All windows and doors shall be of the size indicated on the drawings. 8800.3 Horizontal sliding aluminum window sash shall conform to	
8800.3 Horizontal sliding aluminum window sash shall conform to Specifications HS-A2 of the Architectural Aluminum Manufacturers Association and shall be: Fleetwood Westwood series 250 White Anodized, minimum guarantee of one year.	REVISIONS:
A Minimum depth of active and inactive panels shall be 1/3". B. Fixed sash units shall have names of the manufacturer's	A SEPTEMBER 26 2024 PLAN REVIEW CORRECTION
stock type as recommended for purpose shown on drawings. Sight lines for the fixed units shall line up with ventilator sections when adjacent to or in combination with sliding windows.	
C. Windows shall be constructed to allow either shop or field glazing with aluminum glazing beads. Provide extruded aluminum glazing beads of the window manufacturer's standard design, cut to proper length.	DESIGNER:
8800.4 Windows and doors shall be equipped with aluminum insect screens, complete with frames and hardware. Screen frames shall be of extruded aluminum sections, fixed type for mounting on the outside, fitted with continuous removable plastic or aluminum splines permitting replacement of the wire cloth. Corners shall be reinforced. The finished screens shall be square, flat in one plane and not distorted by stretching of wire. Screen cloth shall be standard fiberglass of 18 x 14 mesh.	com +
outside, fitted with continuous removable plastic or aluminum splines permitting replacement of the wire cloth. Corners shall be reinforced. The finished screens shall be square, flat in one plane and not distorted by stretching of wire. Screen cloth shall be	BD + BD STE 383 5609 anplus.cor aldesign.co
	Besign VYON RD S CA 92883 1-278-5609 cre8designplus chitecturaldesi
8800.5 All windows shall be certified and labeled to show conformance with Air Infiltration Standards of 1972 American National Standards Institute (A134.1, A134.3, and A134.4) when tested in accordance with ASTME 283-73 with a pressure differential of 1.57 ob./s.f. (See Security Notes for additional requirements.)	B D AL CAN RONA, (ONE: 951 eleazar@c ww.caarc
8800.6 If painted aluminum windows are installed, no solvents may be used for clean-up.	CDE EMEC COF COF BSITE: WAIL:
8800.7 All windows and operators shall be installed by the manufacturer or his authorized representative, and shall be set plumb, square, level and true within their respective openings. Like units of each window	Cres Design + 4160 TEMECAL CANYON RD STE. 410 CORONA, CA 92883 PHONE: 951–278–5609 EMAIL: eleazar@cre8designplus.com WEBSITE: www.caarchitecturaldesign.com
his authorized representative, and shall be set plumb, square, level and true within their respective openings. Like units of each window or battery of windows shall finish in the same plane and with like members accurately aligned. Aluminum in contact with plaster, concrete, or steel shall be separated from the similar material with self-adhering, plastic or synthetic rubber tape, 50 mils minimum thickness. Screws, rivets, bolts, and other fastening devices shall be of aluminum, non-magnetic stainless steel or other non-corrosive materials compatible with aluminum: cadmium plated fasteners are not acceptable. Aluminum window and door supplier shall furnish	Design & Prepared by
thickness. Screws, rivets, bolts, and other fastening devices shall be of aluminum, non-magnetic stainless steel or other non-corrosive materials compatible with aluminum: cadmium plated fasteners are	Eleazar Graham
not acceptable. Aluminum window and door supplier shall furnish "rough—in" dimensions to framer. If openings are not plumb and square or properly sized, framer must be notified.	
8800.8 Glass glazing and skylights shall conform to U.B.C. A.A.G.C. 8800.9 Fully tempered glass shall be used at all sliding glass doors and windows.	
8800.10 Glass and glazing shall conform to local codes and meet Federal and State requirements. Glazing subject to human impact to meet requirements of U.B.C. 5406.	
8800.11 Glass for glazing purposes shall be standard brand complying with Federal Specification for Glass Flat, for Glazing".	
 A. Tempered glass 1/8" thick. B. Mirrors shall be 1/4" silvering — quality, copper backed polished plate glass. 	STAMP:
8800.12 Manufactured doors and windows to be certified as required by California Energy Commission (CEC).	Carl How
DIVISION 09 - FINISHES	₩ No. 24651 ₩ 12-31-25 ₩
SUBDIVISION 9100 - Lath & Plaster - Exterior Plaster All work to conform to 2022 CBC AND COUNTY OF ORANGE Amendments. Also, Shop drawing submittal required.	OF CALIFORNIA
Also, Shop drawing submittal required. 9100.1 Lath and plaster shall comply to the Uniform Building Code or to local code.	PROJECT:
9100.2 All exterior walls and soffits shown to be stucco finished shall receive a full 7/8" three coats (rough scratch, rough brown and brush color) of stucco plaster with 3/4# metal lath over 15# felt, or K-lath type backing shall be applied over wood studs.	
9100.3 Apply color coat with complete coverage in a textured finish and color selected by the Architect.	m E
9100.4 Supply all material, including lath, metal trim, sand, cement, plastic cement, color coat, lime and scaffolding, in quantities as required to maintain a production rate consistent with the project progress schedule.	
9100.5 Flash all exterior openings with 15# felt. All laps to be tight. 9100.6 Excess materials, bags, boxes to be removed by subcontractor.	POL PPR(FES
9100.7 The Contractor shall provide his own scaffolding. 9100.8 Adjacent surfaces of other materials shall be protected from damage	
by water or plaster materials. Plaster surfaces, cut out to install work of other trades, shall be neatly patched. Damaaed or defective	
work shall be made good. During work, all rubbish, droppings, and waste materials shall be promptly cleaned up and removed. At completion, the building and premises shall be left clean and free of all plaster and other materials coincident to this work.	
9100.9 Metal lath, typically, shall be diamond mesh expanded, copper bearing steel, weighting not less than 3.4 lbs. per square yard. Metal shall be shop coated after fabrication with a rust— resisting paint for interior use and be galvanized for exterior use.	
9100.10 All windows shall be fully masked and protected prior to plastering. 9100.11 All tops of pot shelves, parapets, projected ledges, shall have one layer of W.R. Grace ?Ice & Water Sheild? under stucco backing.	CR BAS ME I
Also see details and sheet Spec-1. SUBDIVISION 9200 - Gypsum Drywall Construction All work to conform to CBC 2022 and ORANGE COUNTY Amendments. Also, see structural notes and specifications.	T ∞ T
Shop drawing submittal required. 9200.1 All installation shall be in accordance with U.B.C. requirements. Install Gypsum drywall on all interior walls and ceilings as follows: Walls and ceilings—Typical—1 layer 5/8" type ?x? I walls except bathroom, walls and showers. 5/8" green board.	
Walls and ceilings-Typical-1 layer 5/8° type ?x? I walls except bathroom, walls and showers. 5/8° green board. 9200.4 Apply taping and joint treatment (mudding) sufficient number of times on all drywall joints, corners (inside and out) and nail sets to prevent any flashing or irregularities. Provide metal corner aids (Milcor) at all interior walls as required.	DATE: SEP. 26, 2024 SCALE: AS INDICATED DRAWN: EAG & WY
9200.5 Gypsum Wallboard:	JOB NO.: wp0502-15683DLCH SHEET:
 A. Joint Filler — factory mixed compound as recommended by wallboard manufacturer. B. Joint reinforcement — cross fibered paper, tapered edge as 	
C. Use water resistant board in restroom/shower areas.	GN1.0
D. Protect all windows and surfaces from texture over spray.	



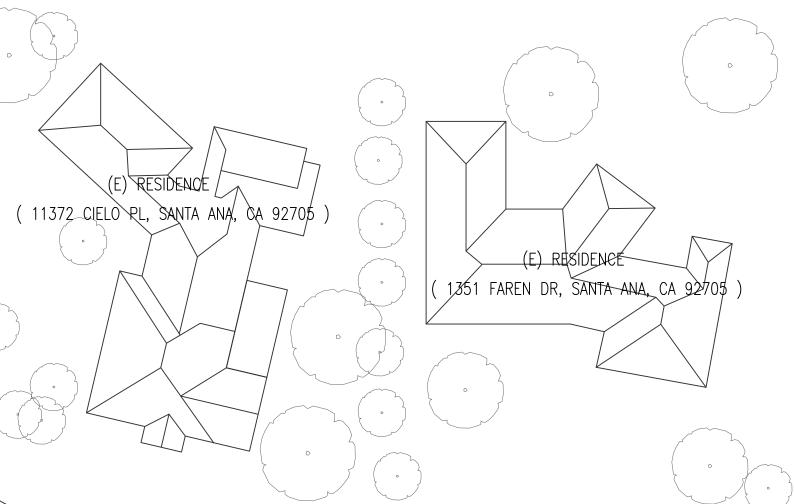
	<u>legend: site pla</u>	<u>N</u>	
	PROPERTY LINE		
	(E) LINE OF STRUCTURE	7//////////////////////////////////////	
	(E) LINE OF ROOF		REVISIONS:
	(N) LINE OF PROPOSED FENCE & POOLS		
	(E) PLANTER		DESIGNER:
	(E) CONC. SLAB		Besign + Cal CaNYON RD STE. 410 RONA, CA 92883 HONE: 951–278–5609 eleazar@cre8designplus.com www.coarchitecturaldesign.com
	MIN SLOPE	2%	CreS D 4160 TEMECAL CAN CORONA, C PHONE: 951 EMAIL: eleazar@c WEBSITE: www.caarc
	(E) TREES		Design & Prepared by Eleazar Graham
	<u>general notes:</u>		
	(E) – EXISTING (N) – NEW		
VALL	STRUCTURES.	L BE MADE TO THE CURRENT RE FOCUSED ON ENHANCING IAL FACILITIES.	PROJECT:
ER POOL F	PLAN SHEETS BY "CWPP")		CRYSTAL WATER POLLS & BASKETBALL COURT FENCE & BASKETBALL COURT FENCE HOME IMPROVEMENT PROJECT 1322 FAREN DR., 1322 FAREN DR.,
			DATE: SEP. 26, 2024 SCALE: AS INDICATED DRAWN: EAG & WY JOB NO.: WP0502-15683DLCH SHEET:
			SP1.0



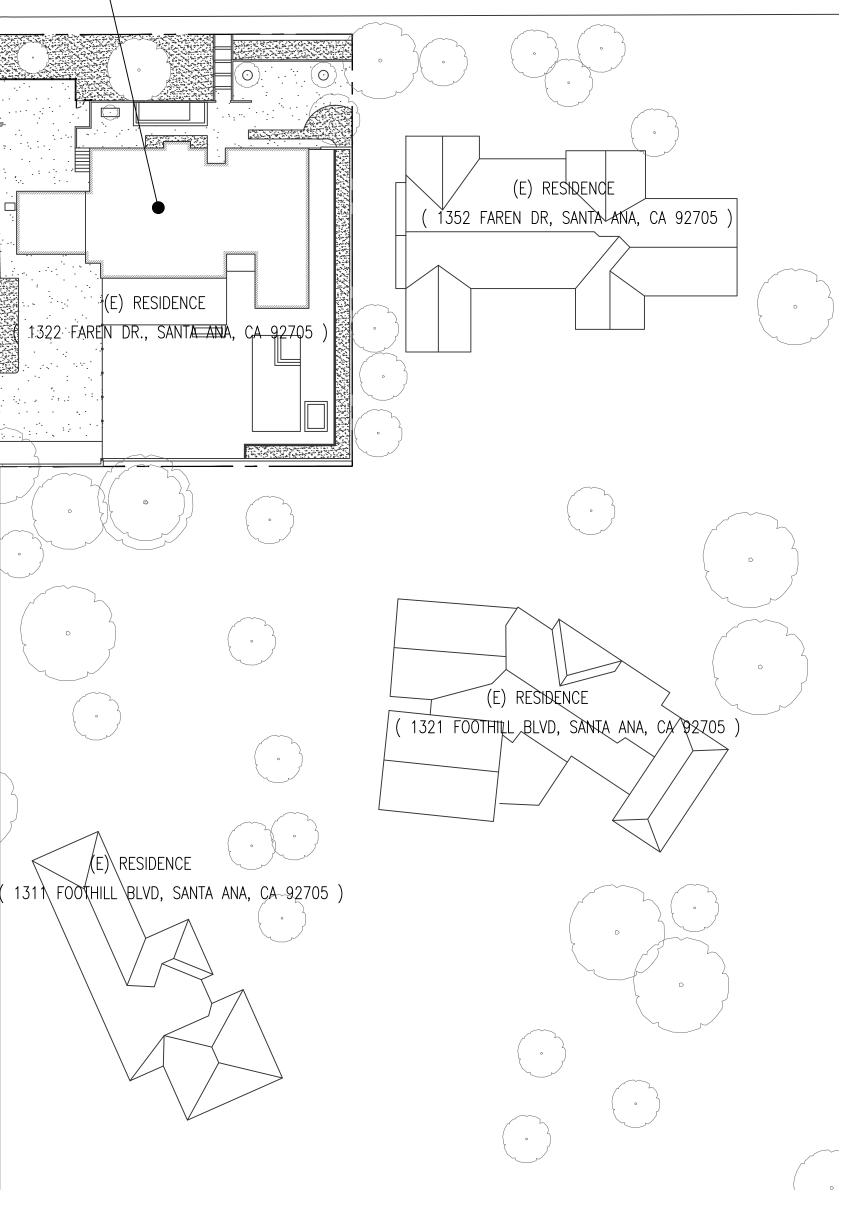
	<u>LEGEND: SITE P</u>	LAN	
	PROPERTY LINE		
	(E) LINE OFSTRUCTURE	<i></i>	REVISIONS:
	(E) LINE OF ROOF		SEPTEMBER 26 2024 PLAN REVIEW CORRECTION
	(N) LINE OF FENCE & POOLS		
	(E) PLANTER		DESIGNER:
	(E) CONC. SLAB		Cre8 Design + TEMECAL CANYON RD STE. 41 CORONA, CA 92883 PHONE: 951–278–5609 EMAL: eleazar@cre8designplus.com EBSITE: www.caarchitecturaldesign.com
	MIN SLOPE	>	
	(N) IRON FENCE	o	4160
	(N) POOL FENCE (4 FEET HIGH)		Design & Prepared by Eleazar Graham
WALL	(E) TREES		
BARRIER HELPS IDED ISOLATION FENCES ARE SF HEM. GATES AND LA HES ABOVE THE RRIERS APPROVE	PECIALLY DESIGNED SO THAT CHILDR ADDERS LEADING TO A POOL OR SP CHILD' S REACH. ED BY CALIFORNIA LAW FOR USE WI	GETTING TO THE WATER. I COMPLETELY SURROUNDS THE POOL REN CANNOT EASILY GET OVER, UNDER OR A ARE SELF-CLOSING AND SELF-LATCHING, TH NEW OR REMODELED HOME POOLS INCLUDE LF-CLOSING AND LATCHING DEVICES ON THE	STAMP:
OOORS, EXIT ALA BUILDING OFFIC LAW APPROVES HILDREN CANNO ORS OPENING IN RELEASES SHOU AND WINDOWS ATTERY OR WIR D HAVE A TEMP ED SWIMMING P OULD NOT BE U	ARMS ON DOORS, SWIMMING POOL A IALS. S ONLY CERTIFIED SAFETY COVERS. T FALL INTO THE WATER. NTO POOL OR SPA AREAS SHOULD ILD BE CHILD-RESISTANT OR OUT C LEADING TO THE POOL OR SPA ARE ED TO HOME ELECTRICAL SYSTEM) ORARY BYPASS SWITCH LOCATED OU	ALARMS, OR ANY OTHER BARRIER APPROVED THEY MUST COMPLETELY COVER THE POOL OR CLOSE AND LATCH AUTOMATICALLY. OF THE REACH OF CHILDREN. EA SHOULD BE EQUIPPED WITH APPROVED EXIT THAT MAKE A LOUD SOUND THROUGHOUT THE JT OF A CHILD'S REACH. N THE WATER TO DETECT MOVEMENT. CAUTION: AL BARRIER.	CRYSTAL WATER POLLS & BASKETBALL COURT FENCE & BASKETBALL COURT FENCE HOME IMPROVEMENT PROJECT 1322 FAREN DR., 1322 FAREN DR.,
			DATE: SEP. 26, 2024 SCALE: AS INDICATED DRAWN: EAG & WY JOB NO.: WP0502–15683DLCH SHEET:
			SP1.1

TREASURELN (E) RESIDENCE (1135) CIELO PL, NORTH TUSTIN, CA 92/05) (· (E) RESIDENCE (11371 CIELO PL, SANTA ANA, CA 92705) Ď THE SITE OF PROJECT Ч(E) RESIDENCE (11401 CIELO PL, SANTA ANA, CA 92705)) CIELO PL e Agenda de Alexander , ····· (E) RESIDENCE · (11431 CIELO PL, SANTA ANA, CA 92705) D \cdot D

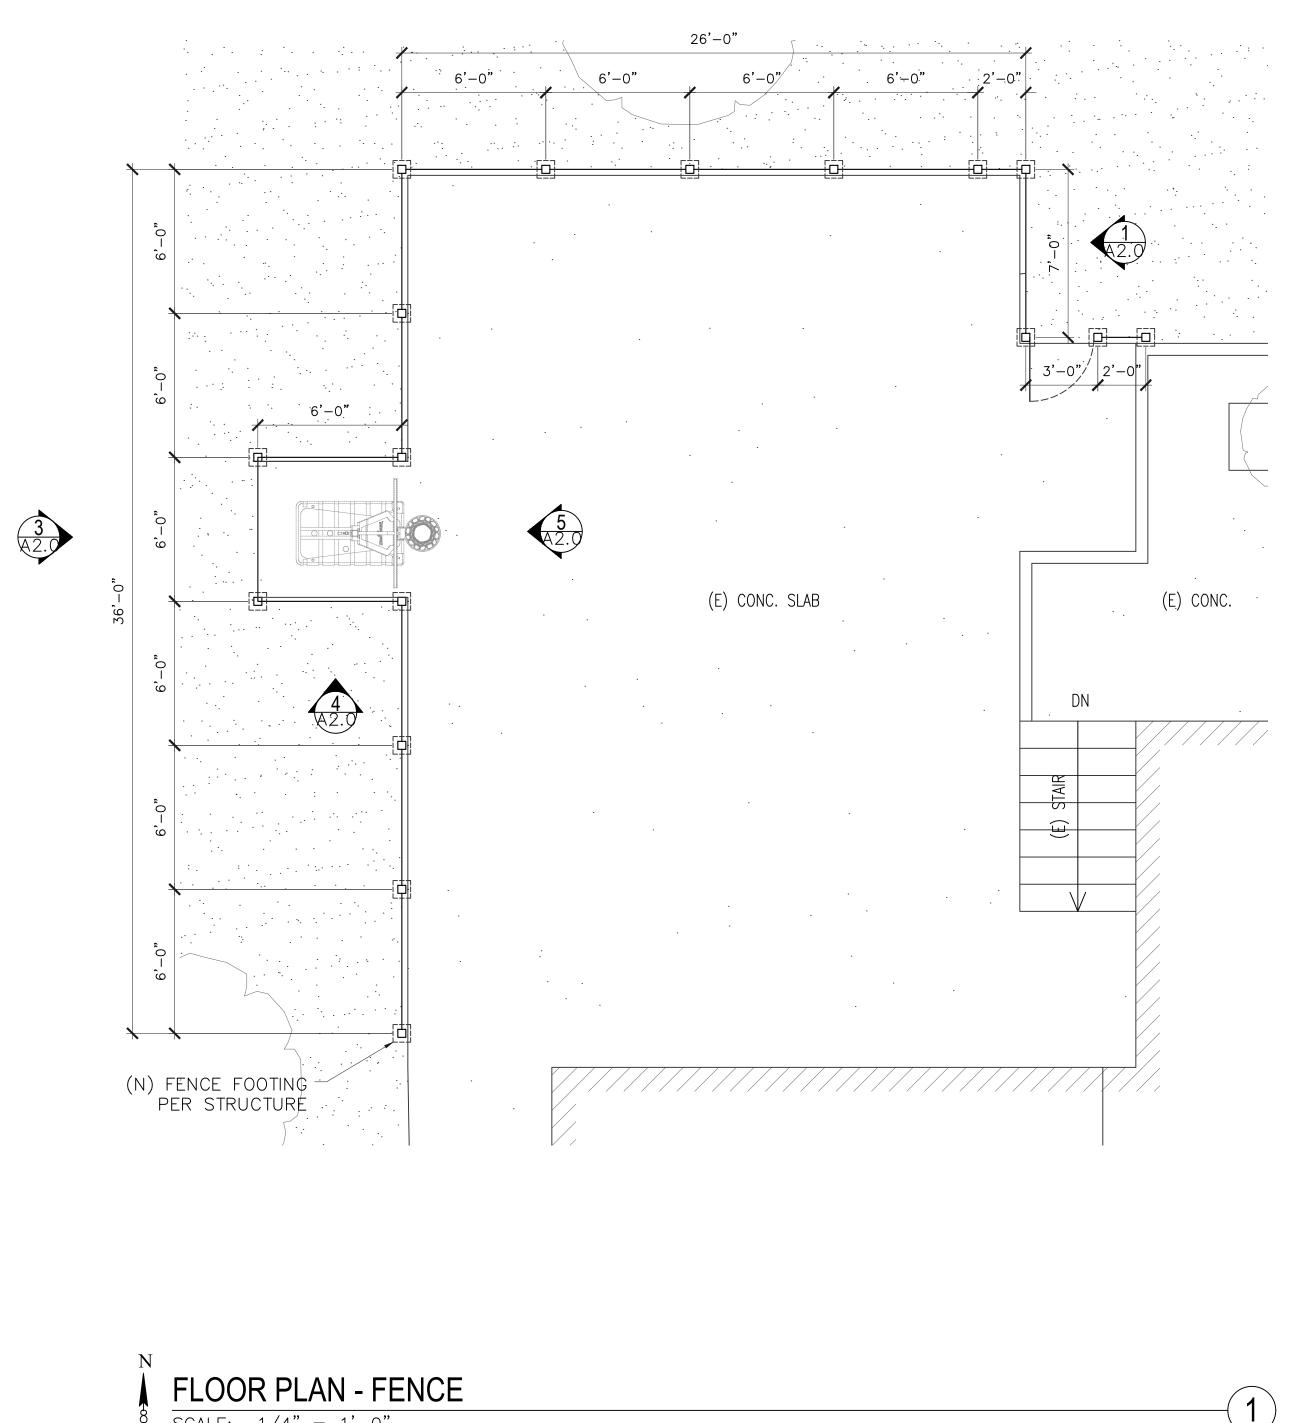
ADJACENT NEIGHBORING USES SITE PLAN SCALE: 1/8" = 1'-0"



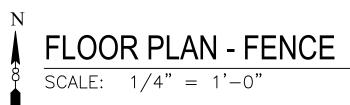
FAREN DR



<u>LEGEND: SITE PLAN</u>		
PROPERTY LINE OF PROJECT		
(E) LINE OFSTRUCTURE	<i></i>	DESIGN
		REVISIONS:
(E) PLANTER		
	<u> 동네 사용하지 않는 것 같아. 가지 않는 것은 유전</u>	DESIGNER:
(E) CONC. SLAB		9
		S Design + AL CANYON RD STE. 410 RONA, CA 92883 HONE: 951-278-5609 eleazar@cre8designplus.com www.coarchitecturaldesign.com
		S Design + AL CANYON RD STE. ⁴ RONA, CA 92883 ONE: 951-278-5609 eleazar@cre8designplus.com www.caarchitecturaldesign.co
(E) TREES		DC: DC: DC: DC: DC: DC: DC: DC: DC: DC:
<u>general notes:</u>		
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		Design & Prepared by Eleazar Graham
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		PROJECT:
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		CRYSTAL WATER POLLS & BASKETBALL COURT FENCE HOME IMPROVEMENT PROJECT 1322 FAREN DR., SANTA ANA, CA 92705 JACENT NEIGHBORING USES SITE
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		CRYSTAL WATER POLLS & BASKETBALL COURT FENCE & BASKETBALL COURT FENCE HOME IMPROVEMENT PROJECT 1322 FAREN DR., 1322 FAREN DR.,
		DATE: SEP. 26, 2024 SCALE: AS INDICATED
		DRAWN: EAG & WY JOB NO.: WP0502-15683DLCH
		SHEET:
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### <u>LEGEND: FLOOR PLAN</u>

- (E) LINE OFSTRUCTURE
- (E) PLANTER
- (N) IRON FENCE
- (N) FOOTING

[_]

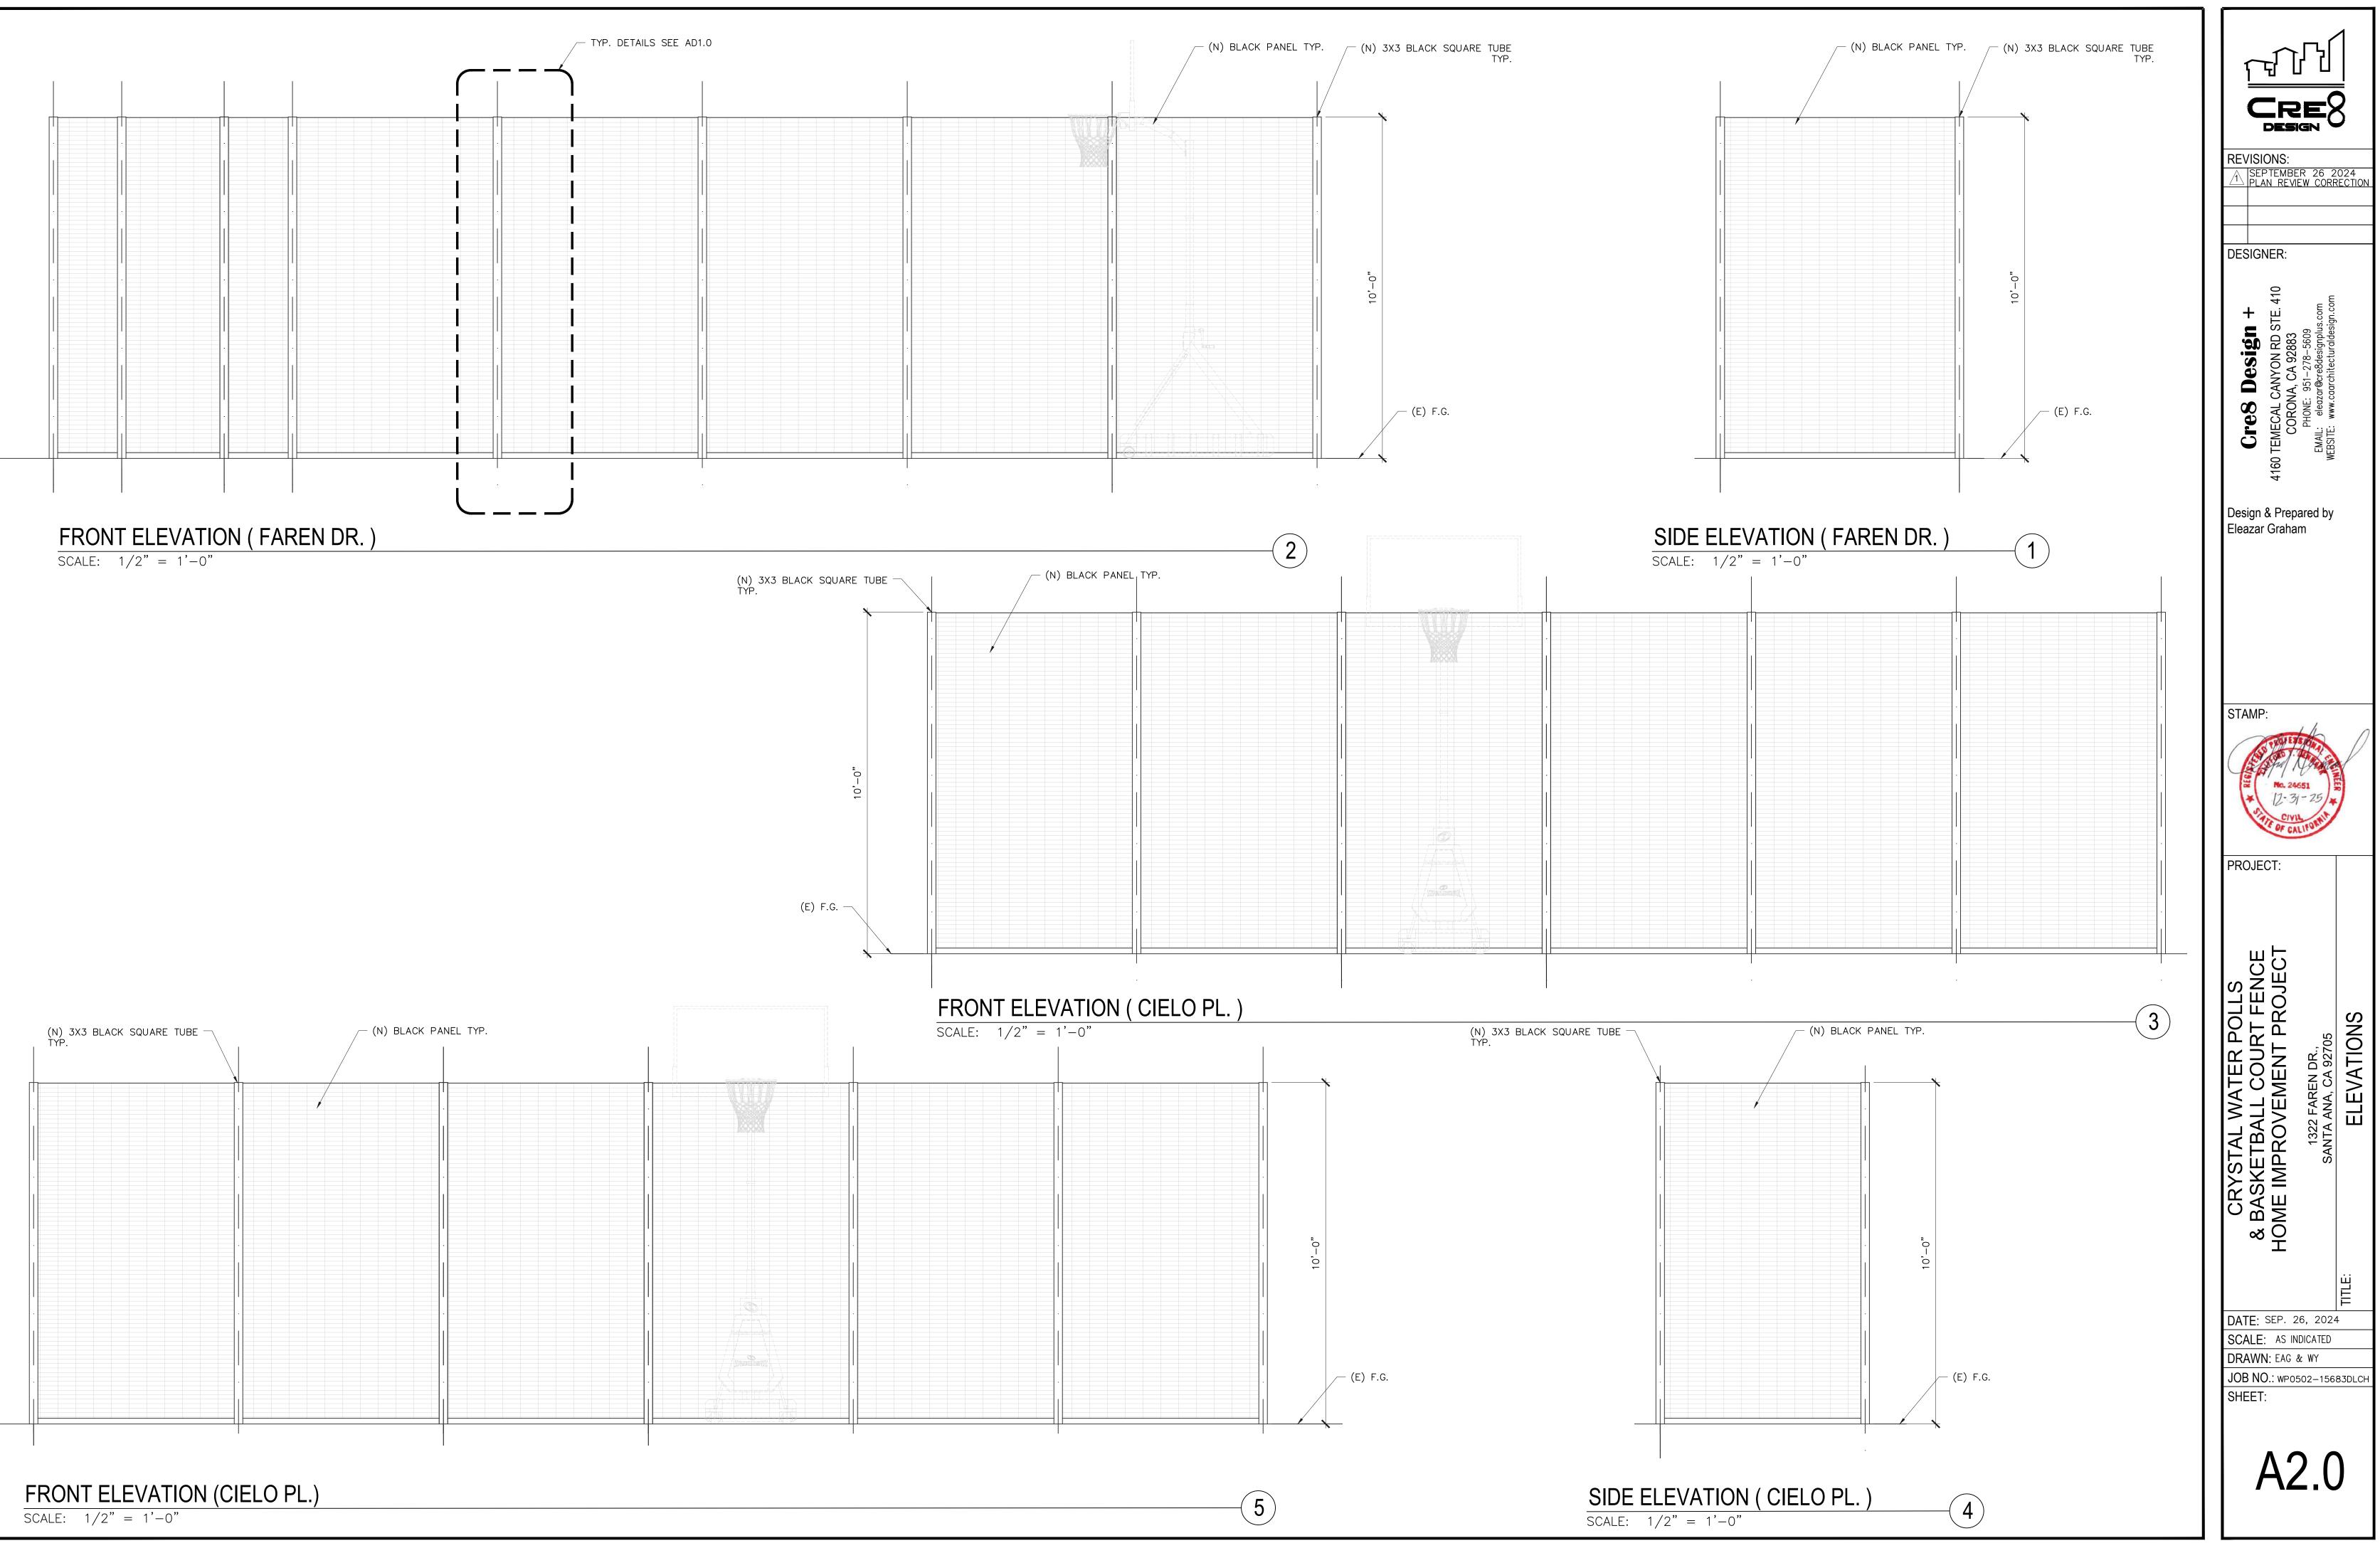
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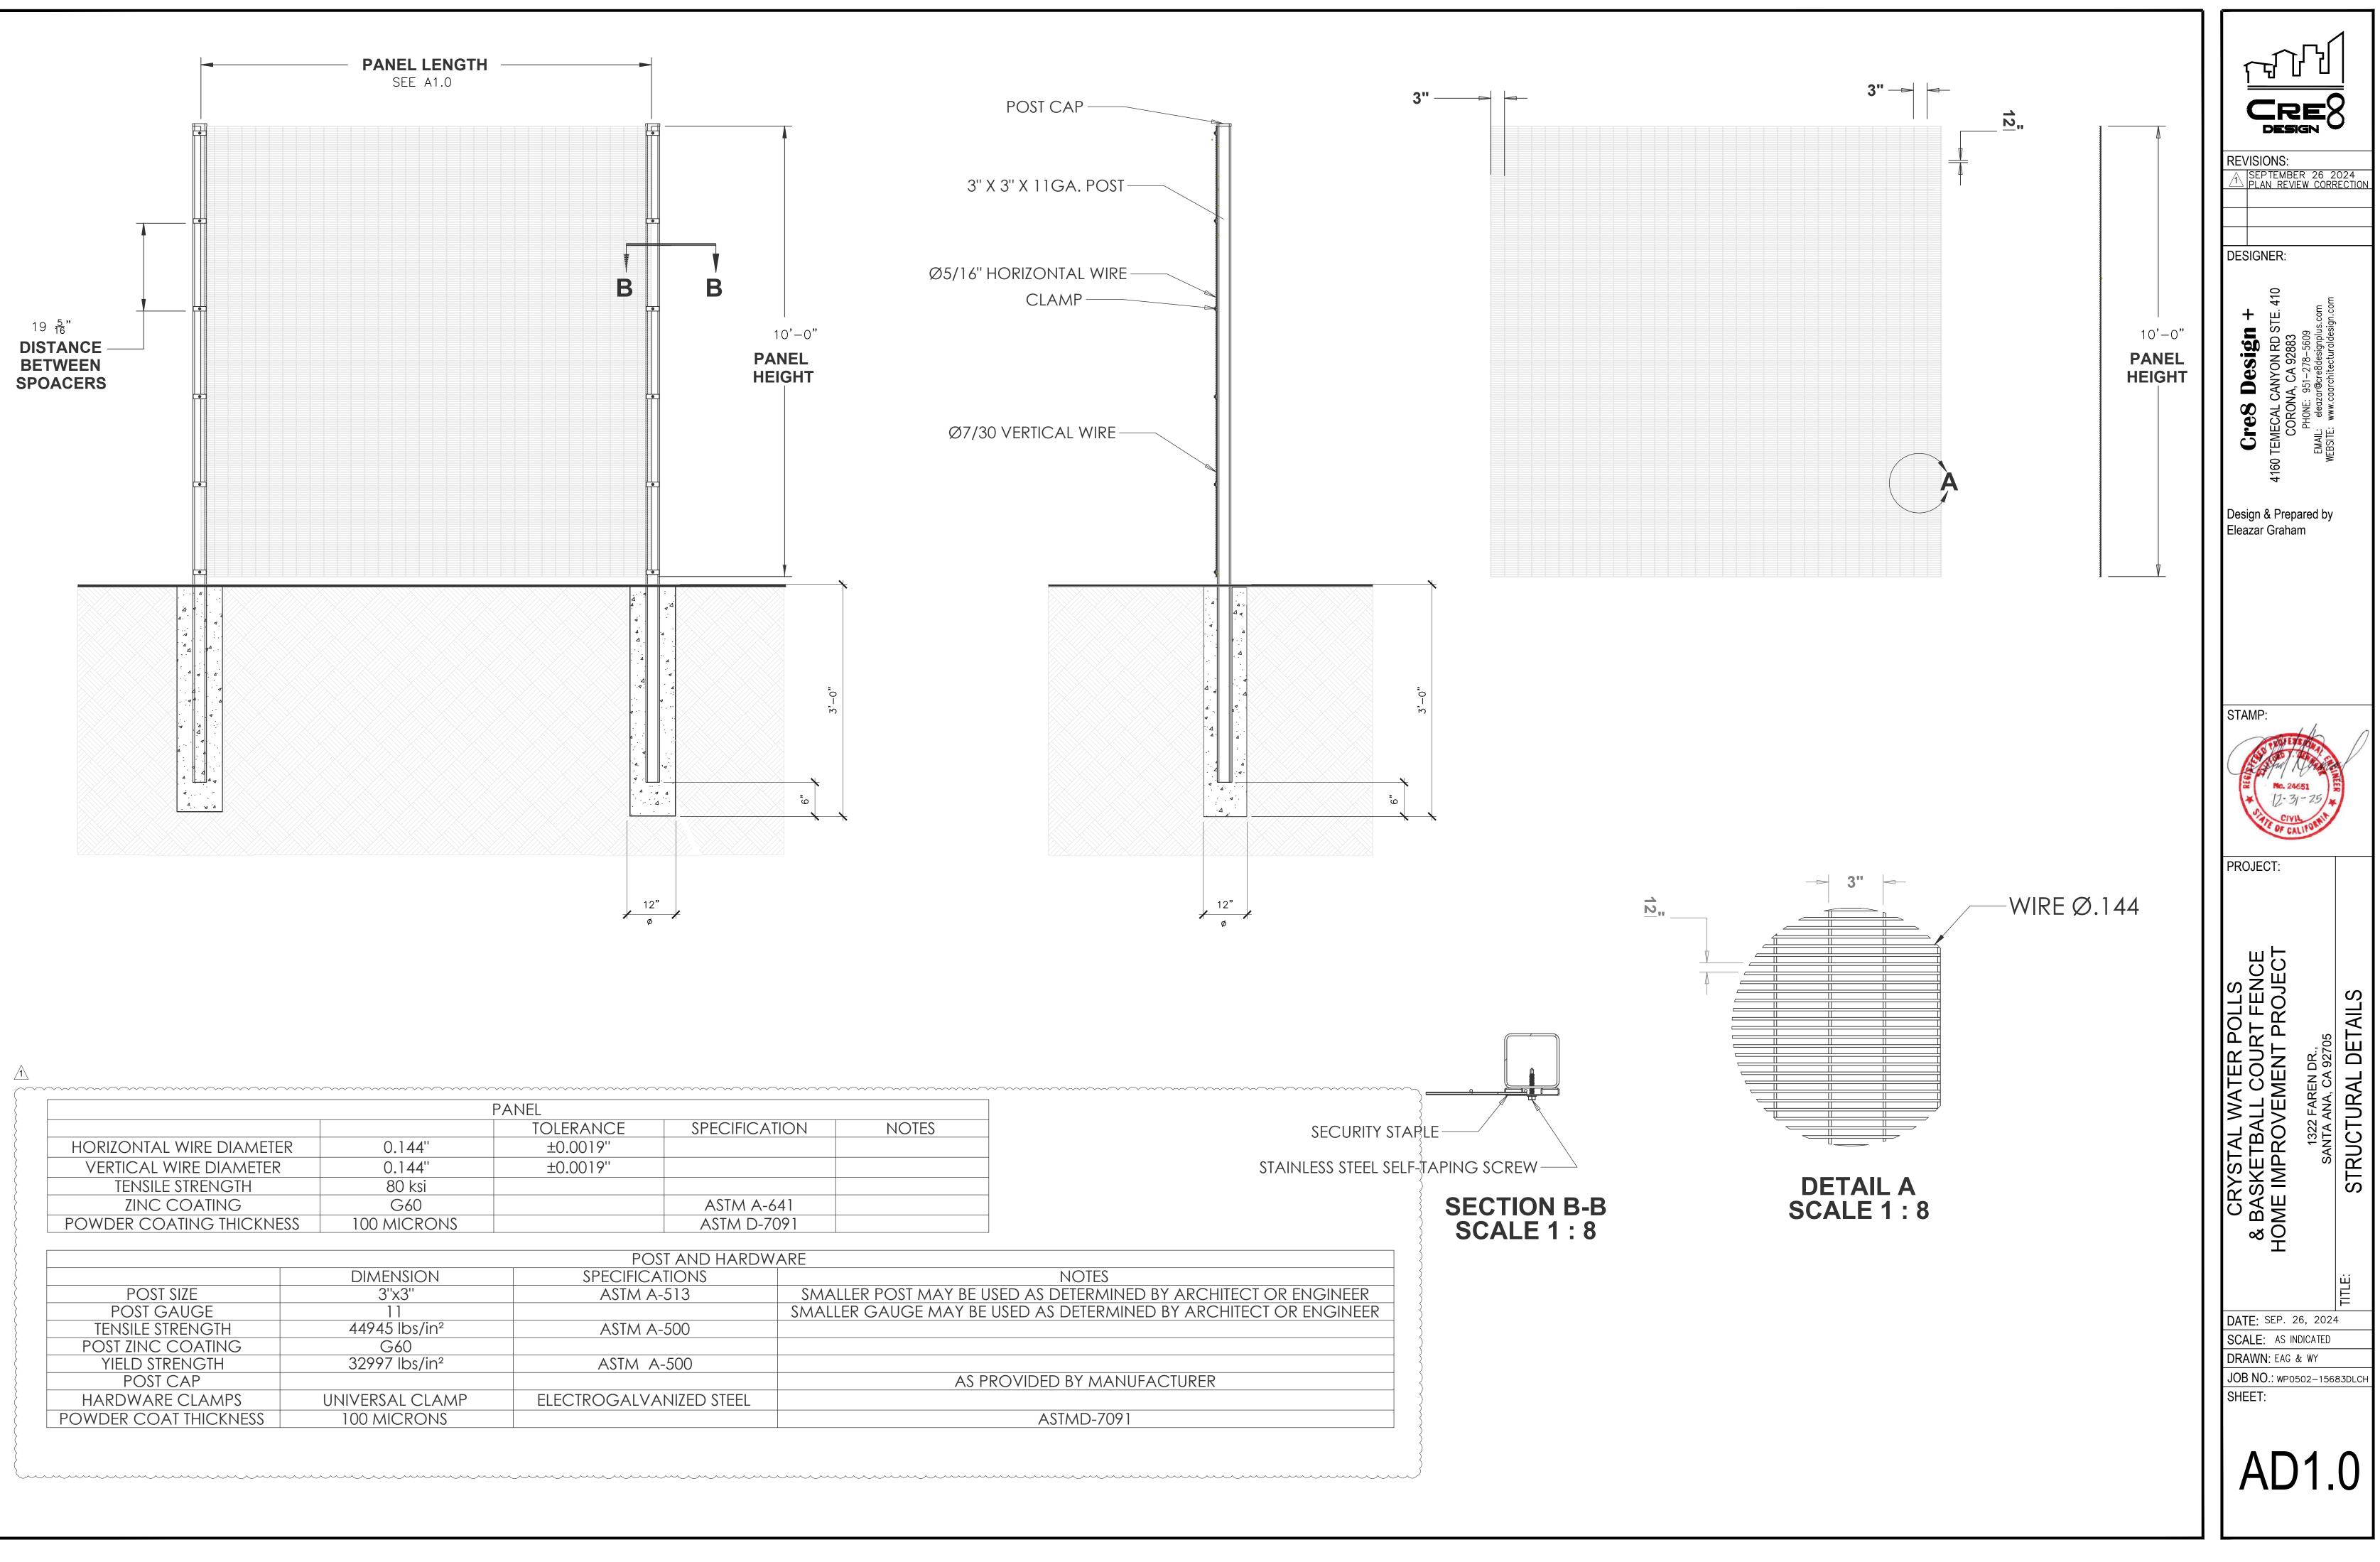
<u>general notes:</u>

(E) – EXISTING

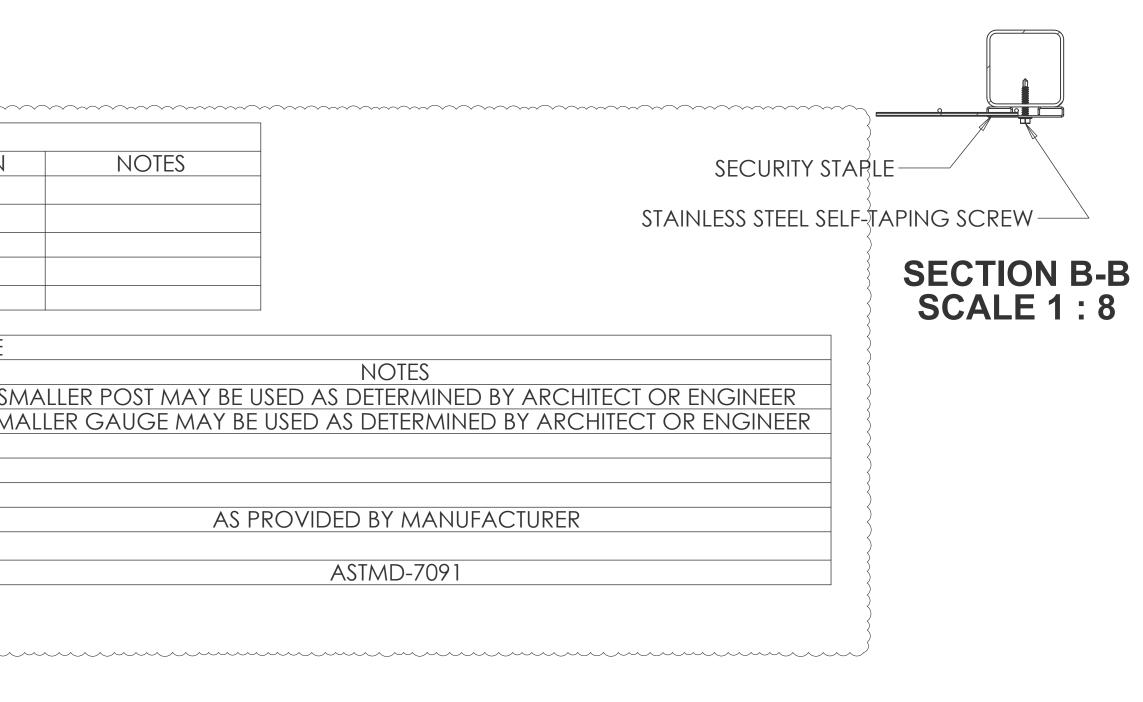
(N) — NEW

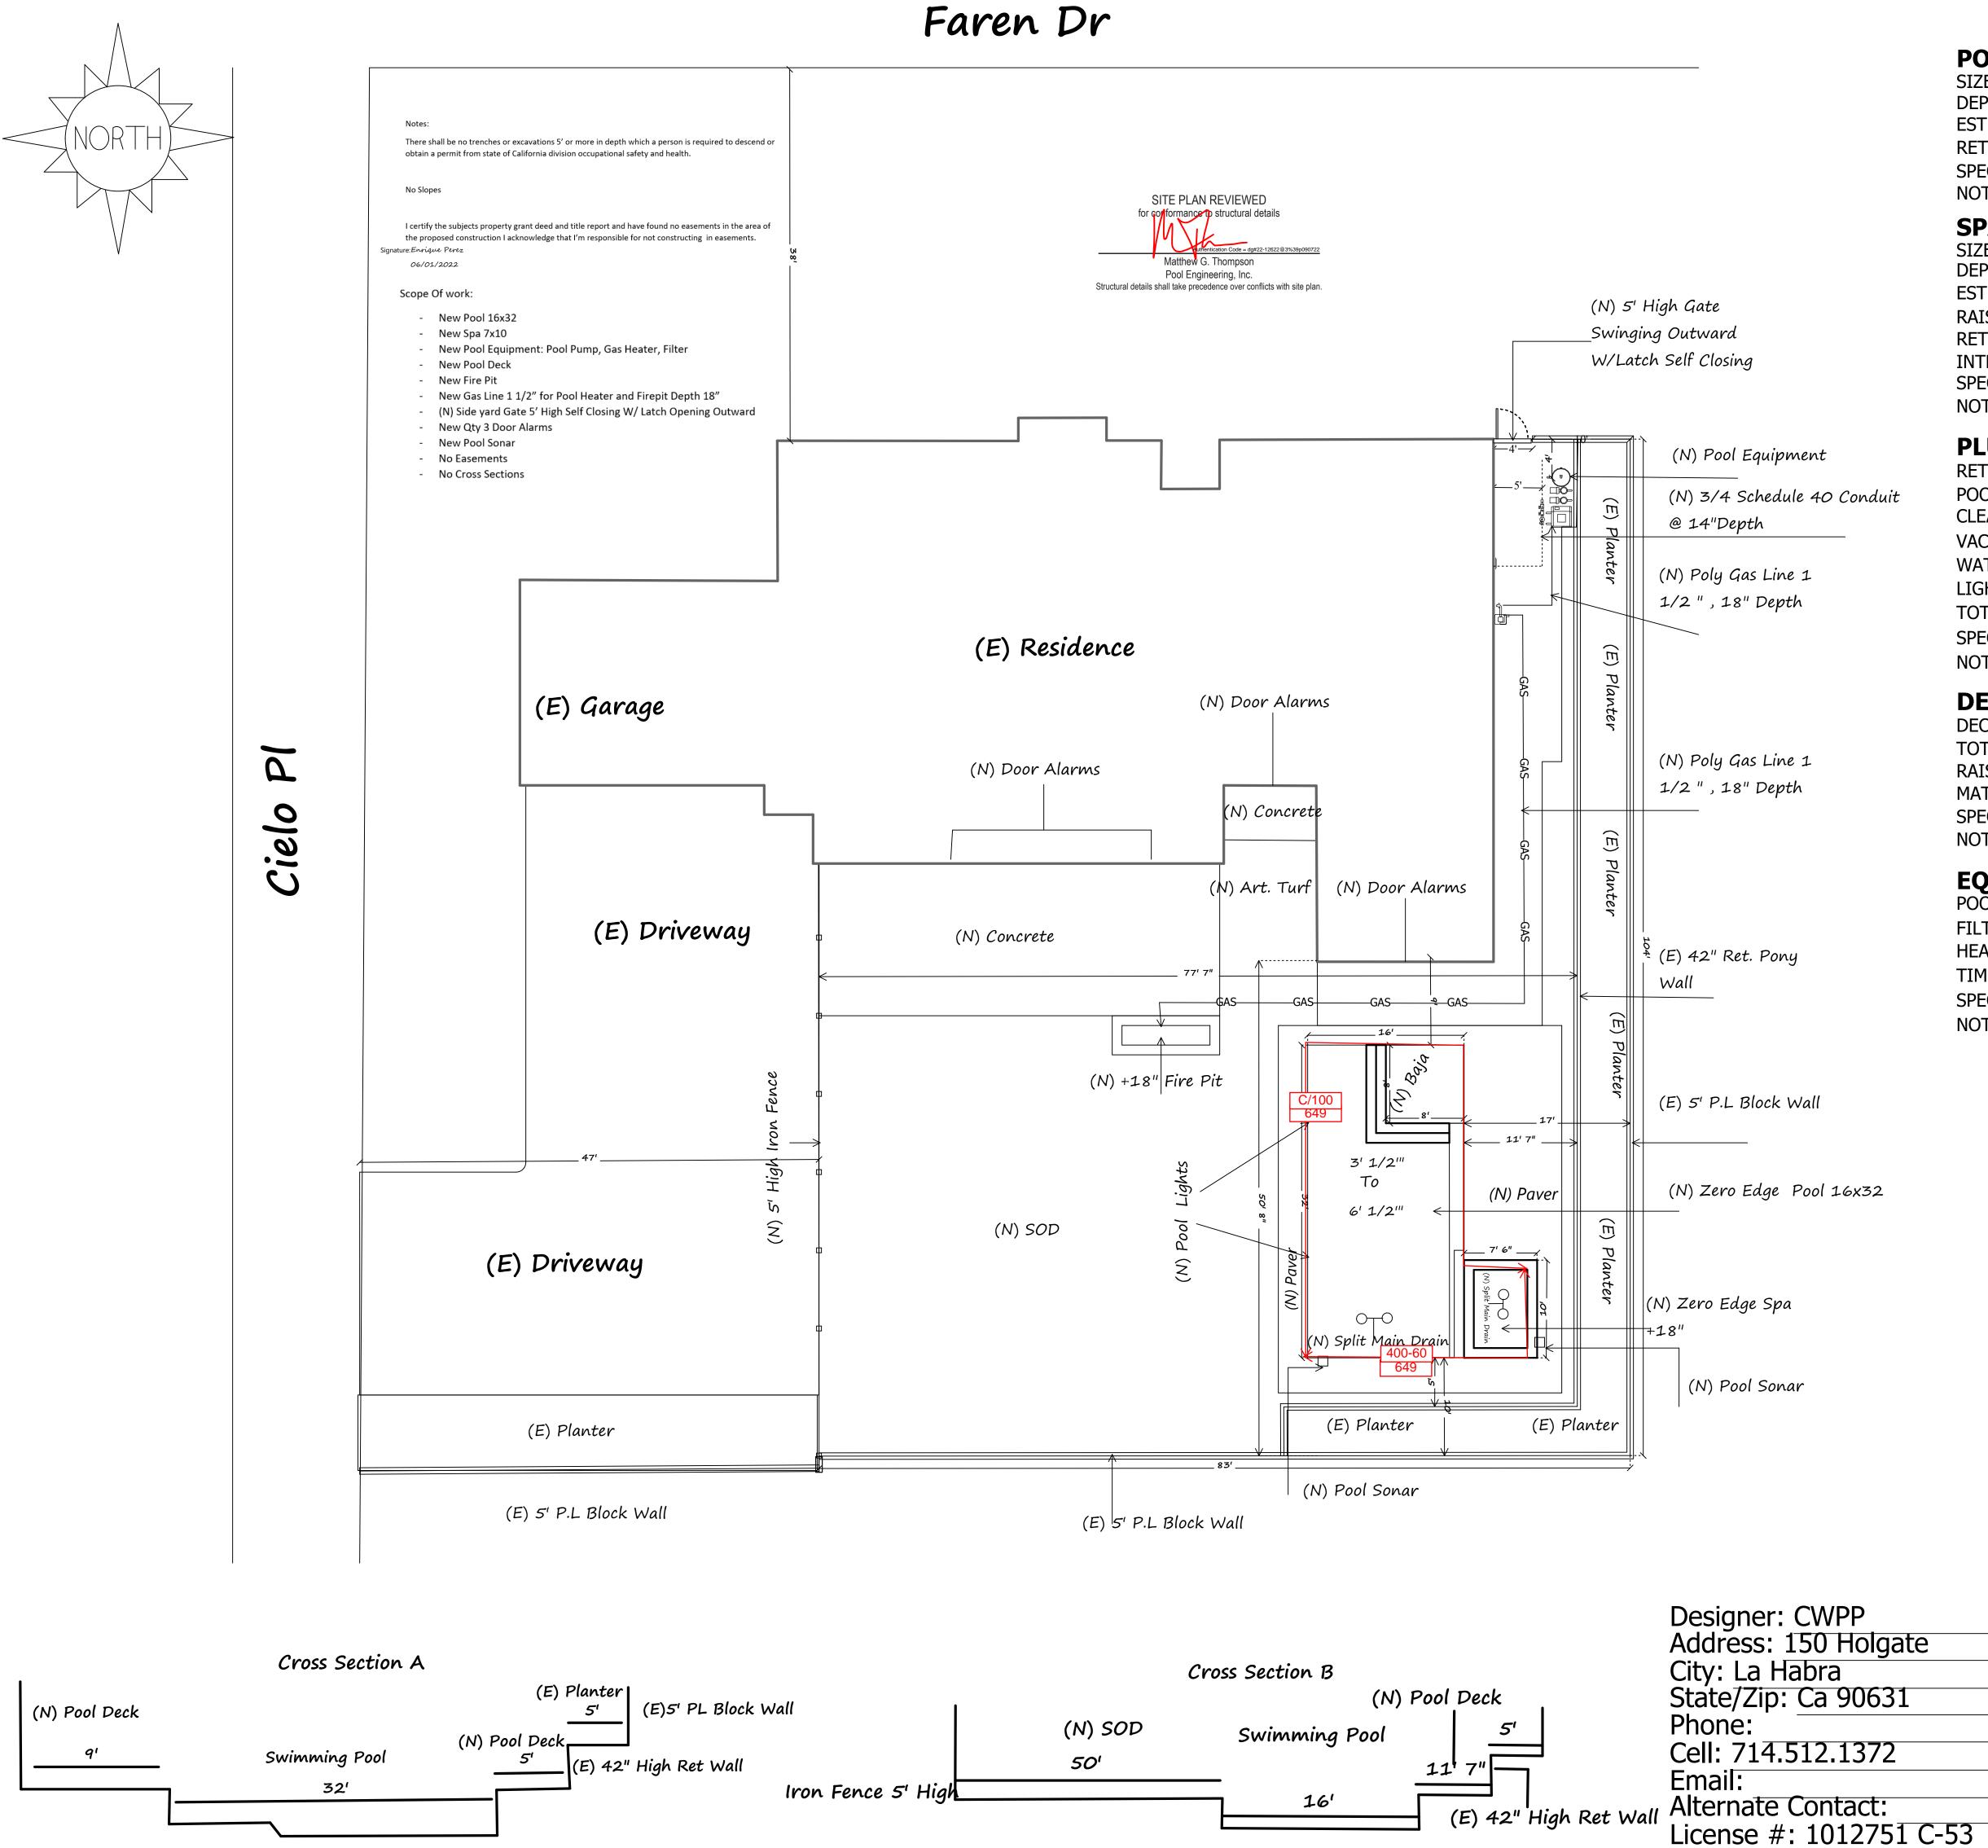
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REVISIONS:	R 26 2 W CORR	024 ECTION
DESIGNER:		
<b>CreS Design +</b> 4160 TEMECAL CANYON RD STE. 410 CORONA, CA 92883	PHONE: 951-278-5609 EMAIL: eleazar@cre8designplus.com WEBSITE: www.caarchitecturaldesign.com	
Design & Prepa Eleazar Grahar	•	
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PROJECT:		
CRYSTAL WATER POLLS & BASKETBALL COURT FENCE HOME IMPROVEMENT PROJECT	1322 FAREN DR., SANTA ANA, CA 92705	FENCE FLOOR PLAN
		TITLE:
DATE: SEP. 26 SCALE: AS INE DRAWN: EAG &	DICATED	F
JOB NO.: WP05 SHEET:	02–1568	B3DLCH
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	F	PANEL		
		TOLERANCE	SPECIFIC	AT
HORIZONTAL WIRE DIAMETER	0.144"	±0.0019"		
VERTICAL WIRE DIAMETER	0.144"	±0.0019"		
TENSILE STRENGTH	80 ksi			
ZINC COATING	G60		ASTM A	-6
POWDER COATING THICKNESS	100 MICRONS		ASTM D-	-70
POST SIZE	DIMENSION 3''x3''	SPECIFIC/ ASTM A		
POST GAUGE	11			
TENSILE STRENGTH	44945 lbs/in ²	ASTM A	-500	
POST ZINC COATING	G60			
YIELD STRENGTH	32997 lbs/in ²	ASTM A	-500	
POST CAP				
HARDWARE CLAMPS	UNIVERSAL CLAMP	ELECTROGALV	ANIZED STEEL	
POWDER COAT THICKNESS	100 MICRONS			





### POOL

SIZE: 16x32	
DEPTH: 3 1/2'- 6 1/2'	
EST TOTAL GALLONS:	
RETURNS: 4	
SPECIAL:	
NOTES:	

### **SPA SPECS**

SIZE: 7 1/2x10 '	SQFT: 70 Sq Ft
DEPTH: 3'	PERIMETER: 48
EST TOTAL GALLONS:	SPILLWAY: Zero Edge
RAISED HEIGHT: +18"	SKIMMERS:
RETURNS: 1	TILE: Glass
INTERIOR MATERIAL: Glass Pe	bble
SPECIAL:	
NOTES:	

SQFT: 512 Sq Ft

SKIMMERS: Qty 1

SKIMMERS: Qty 1

ROBOT VAC: Qty 1

LIGHTS IN SPA: <u>Qty 1</u>

HEADS:

SPA MAIN DRAINS: Split

SPA SPILLWAY: Zero Edge

TILE: Glass

PERIMETER: 96 Ln Ft

INTERIOR MATERIAL: Glass

### PLUMBING

RETURNS: <u>4</u>
POOL MAIN DRAINS: Split
CLEANING SYSTEM: Auto
VAC LINES: Qty 1
WATER FEATURES: N/A
LIGHTS IN POOL: Qty 3
TOTAL PIPE:
SPECIAL:
NOTES:

### DECK

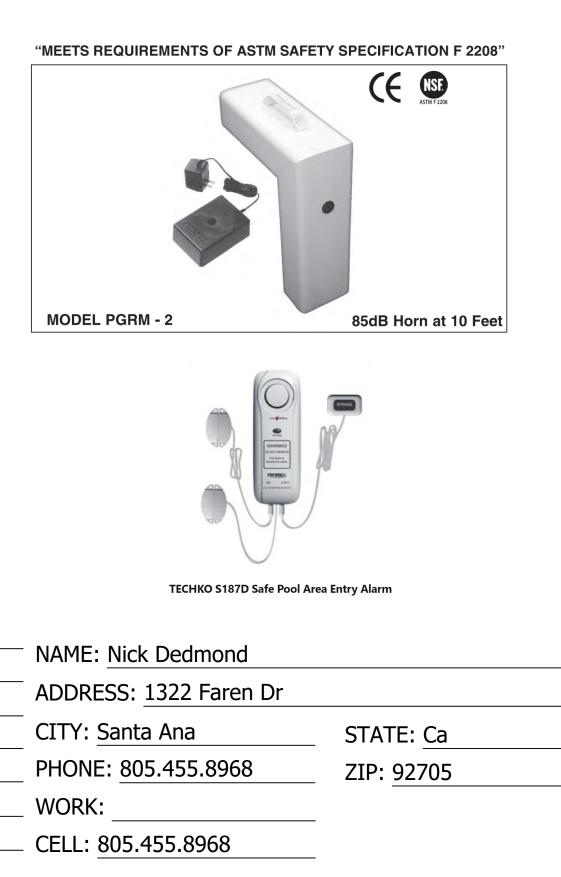
DECK TYPE: Pavers	ELEVATION: Flushed
TOTAL DECK SQFT: TBD	PERIMETER: TBD
RAISED BEAM: N/A	LIP STYLE:
MATERIAL 1:	MATERIAL 2:
SPECIAL:	
NOTES:	

### EQUIPMENT

POOL PUMP: 3 HP VS	
FILTRATION: D.E	
HEATER: 400k BTU	
TIMER: Auto	
SPECIAL:	
NOTES:	

2ND PUMP: 2HP Super Flo FILTER SIZE: 60 Sq Ft INLINE: 1 1/2" GAS: Natural

# Pool Alarms

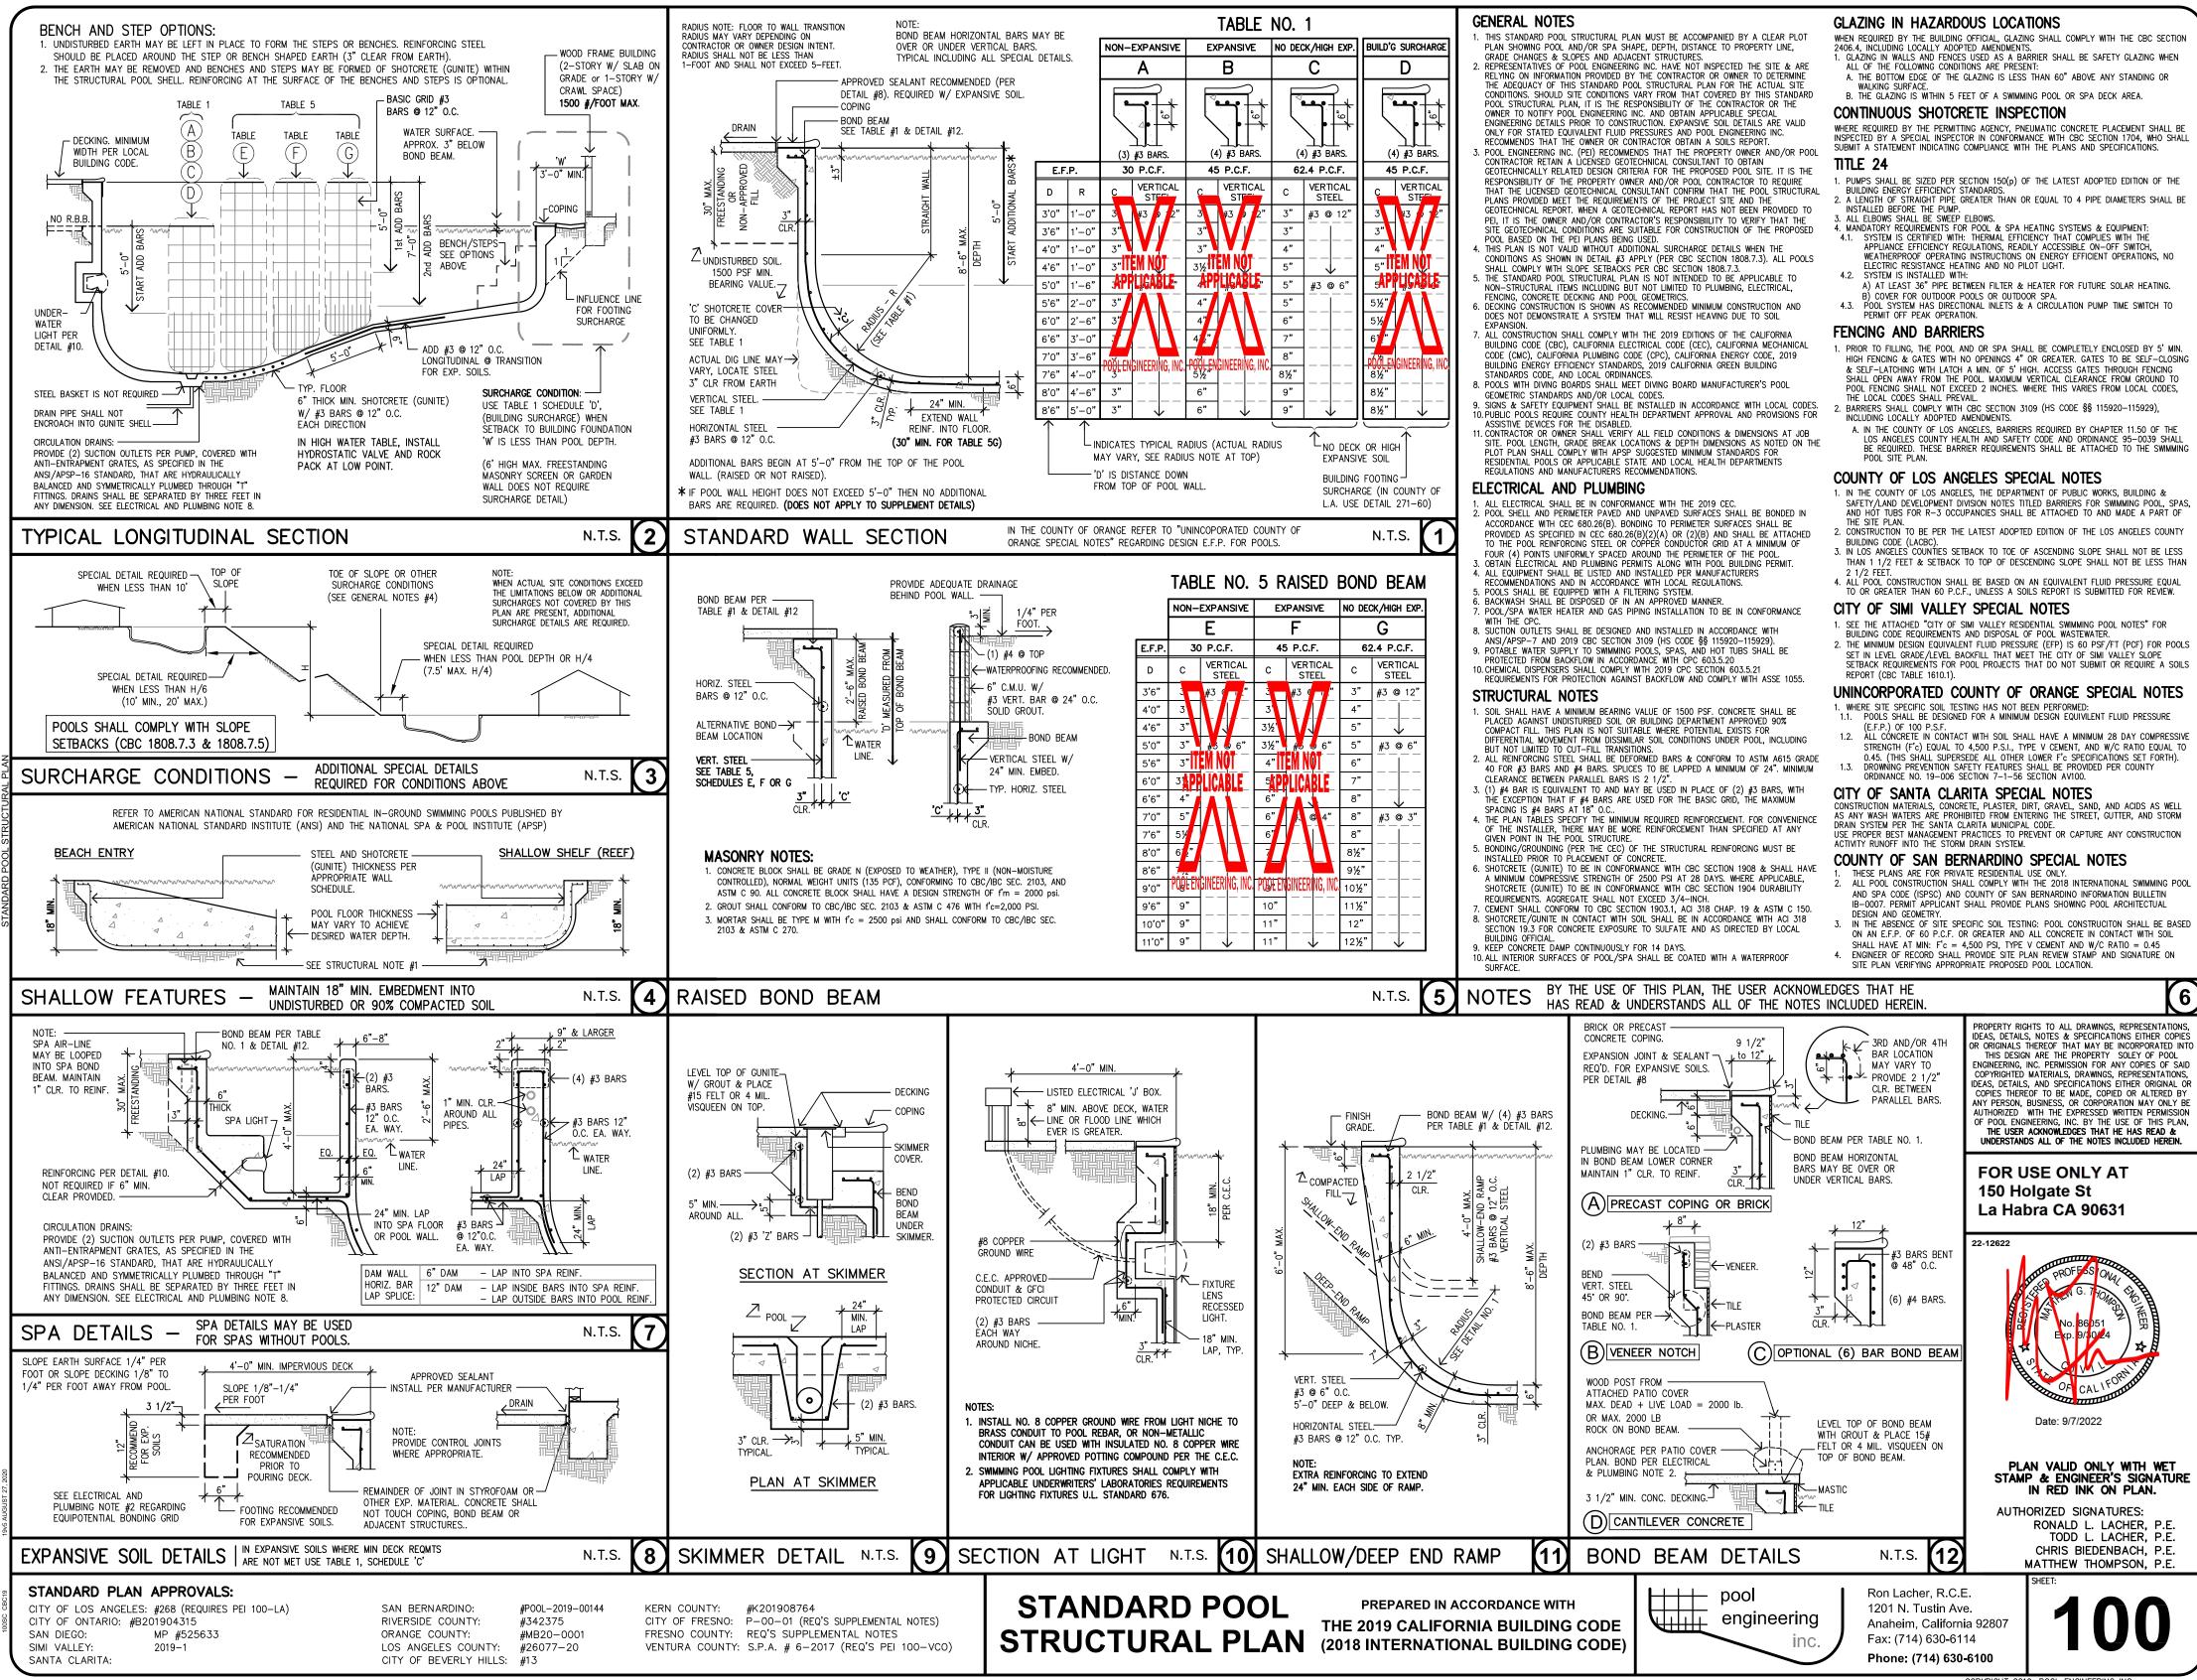




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General Plan

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