
REED RESIDENCE

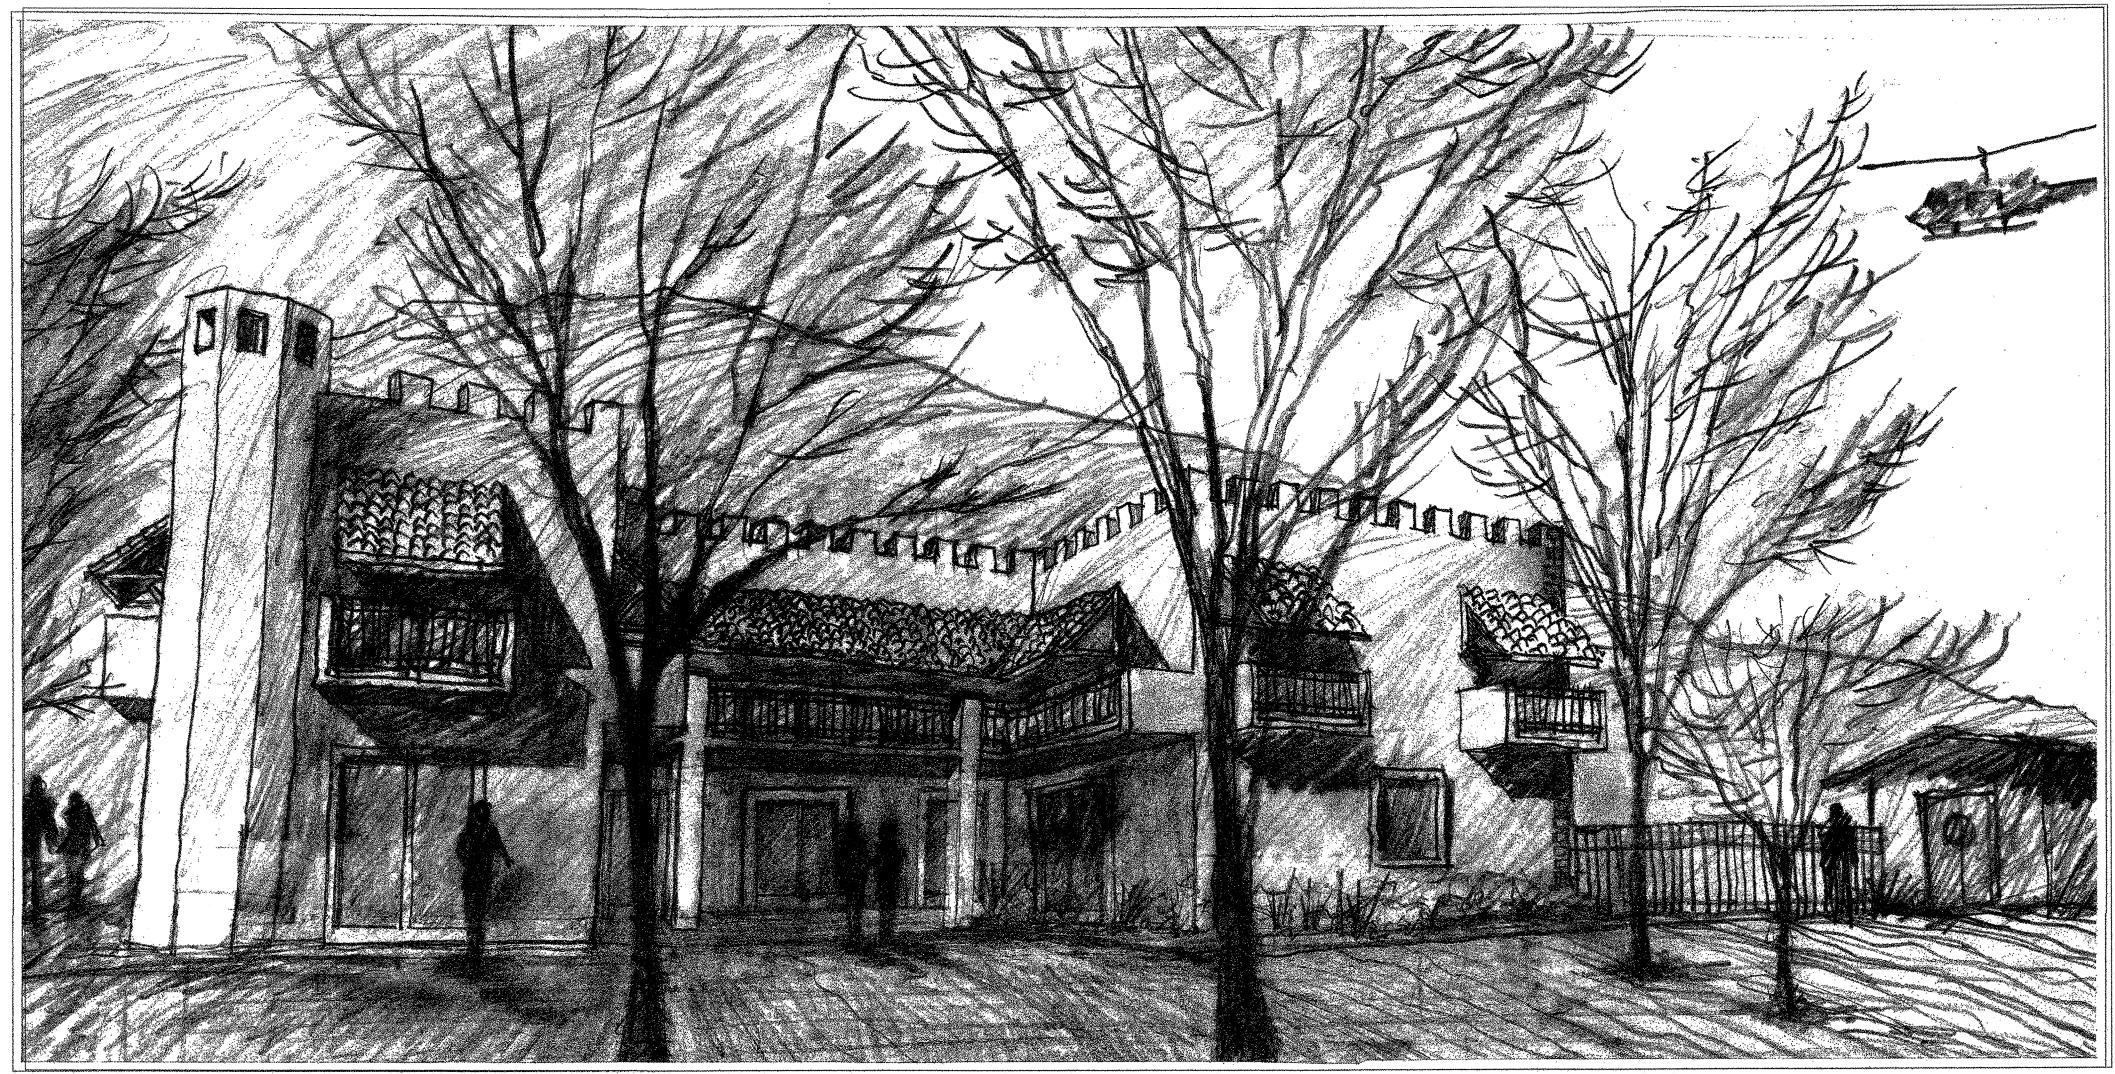

Conceptual Sketch

VICINITY MAP SITE AND BUILDING DATA SHEET INDEX PROJECT DATA TITLE SHEET A-1.0 SITE PLAN OWNER: **OCCUPANCY GROUP:** MAIN LEVEL FLOOR PLAN 1. SITE AND BUILDING DATA: A-2.0 UPPER LEVEL FLOOR PLAN A-2.1 JAKE REED SITE AREA 73,616 S.F. **ROOF PLAN** A-2.2 30122 CANYON CREEK DR. **EXTERIOR ELEVATIONS** A-3.0 (5) TRABUCO CANYON CA 92679 2. HOUSE FOOTAGES: **EXTERIOR ELEVATIONS BUILDING CODES:** LEGAL DESCRIPTION: A-4.0 **BUILDING SECTIONS** BUILDING SECTIONS A- MAIN RESIDENCE: A-4.1 PLANS SHALL COMPLY WITH: MAIN LEVEL FLOOR PLAN ACCESSORY DWELLING UNIT) 2010 CALIFORNIA BUILDING CODE (CBC) 1,618 S.F. **EXISTING -3 STORY** ROOF PLAN ACCESSORY DWELLING UNIT 2010 CMC, CPC, CEC AND CRC **ADDITION -3 STORY** 3,723 S.F. **GRADING PLAN** T-24 ENERGY CONSERVATION REGULATIONS TOPOGRAPHIC SURVEY TOTAL AREA: 5,341 S.F. COUNTY ORDINANCES AND REGULATIONS AND ACCESSOR'S PARCEL NUMBER: **EXISTING 3-CAR GARAGE** 1,476 S.F. DRIVEWAY \ BUILDING PAD OVERLAY 30122 Canyon Creek Drive, Trabuco Canyon, CA 92679 **EXTERIOR STAIRWAY** 181 S.F. SEPTIC TANK \ LEACH FIELD OVERLAY 2010 CALIFORNIA RESIDENTIAL CODE, WHICH ADOPTS BALCONY@ UPPER FLOOR 677 S.F. THE 2009 IRC, 2009 UMC, 2009 UPC AND THE 2008 NEC. SITE COVERAGE OVERLAY CAL SECTION R106.2. NATURAL OPEN SPACE DEDICATION PROJECT DESCRIPTION: HARDSCAPE COVERAGE CAL. B. ACCESSORY DWELLING UNIT MAIN ENTRANCE GATE BUILDING SITE COVERAGE CAL PROPOSED 2 STORY ADDITION TO EXISTING Compliance Note: 1,000 S.F. **EXISTING - 1 STORY** REED AS-BUILT RESIDENCE AND AS-BUILT **DECKS** 663 S.F. A-1.1 SITE PLAN (PRESICE GRADING PLAN) PLANS FOR EXISTING FAMILY GUEST HOUSE Project must comply with requirements of 2013 CRC, CALGREEN and ENERGY Codes. A project submitted after January I, 2017 shall also comply with 2016 California Codes and all other applicable codes as determined by OC Building **ZONING:** Department. 6 **Retaining Wall Note:** TYPE OF CONSTRUCTION: A separate retaining wall permit must be must be obtained at the time of building permit submittal, all other permits as determined by OC Building Department must also be obtained.

lohrbach studio

31742 SOUTH COAST HWY.

LAGUNA BEACH CA 9265
TEL 949.661 5068 FAX 949.715.952

Seal / Signature:

Consultan


REED RESIDENCE & ACCESSORY DWELLING UNIT


30122 Canyon Creek Dr. Trabuco Canyon, Ca 92679


Revi	sions:	
No.	Date Revision	and the second s
$\overline{\wedge}$		
$\overline{\wedge}$		refolenten et en
$\overline{\wedge}$		nazanddiidhaaqiidhean maadsiyaan yadda metuu
$\stackrel{\longleftarrow}{\wedge}$		Odrabii deigenees ee kiroos ee kaasaa ka
$\stackrel{\longleftarrow}{\wedge}$		**************************************
$\stackrel{\angle}{\prec}$		***************************************
		16-тевратана по принципа и при выпосна при выпосна применения по при выпосна при выпосна при выпосна при выпосн При применения при выпосна
Date		2/21
Job I	Vo.:	
	ociation nittal:	en e
Bldg	Dept. Submittal:	
Bid I	ssue:	**************************************
Cons	struction Issue:	***********************************


	y, mens y &	-
Shee	er inte:	
Shee	TTTLE S	HEET
Shee		HEET

ENCL (9)

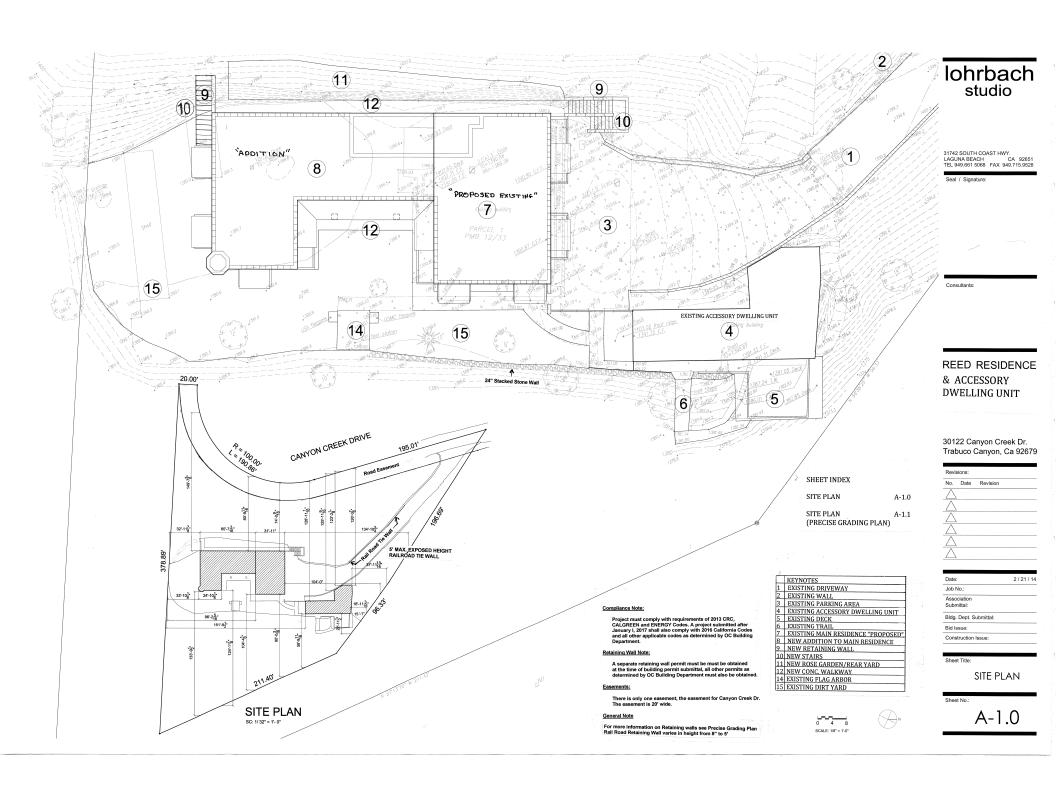

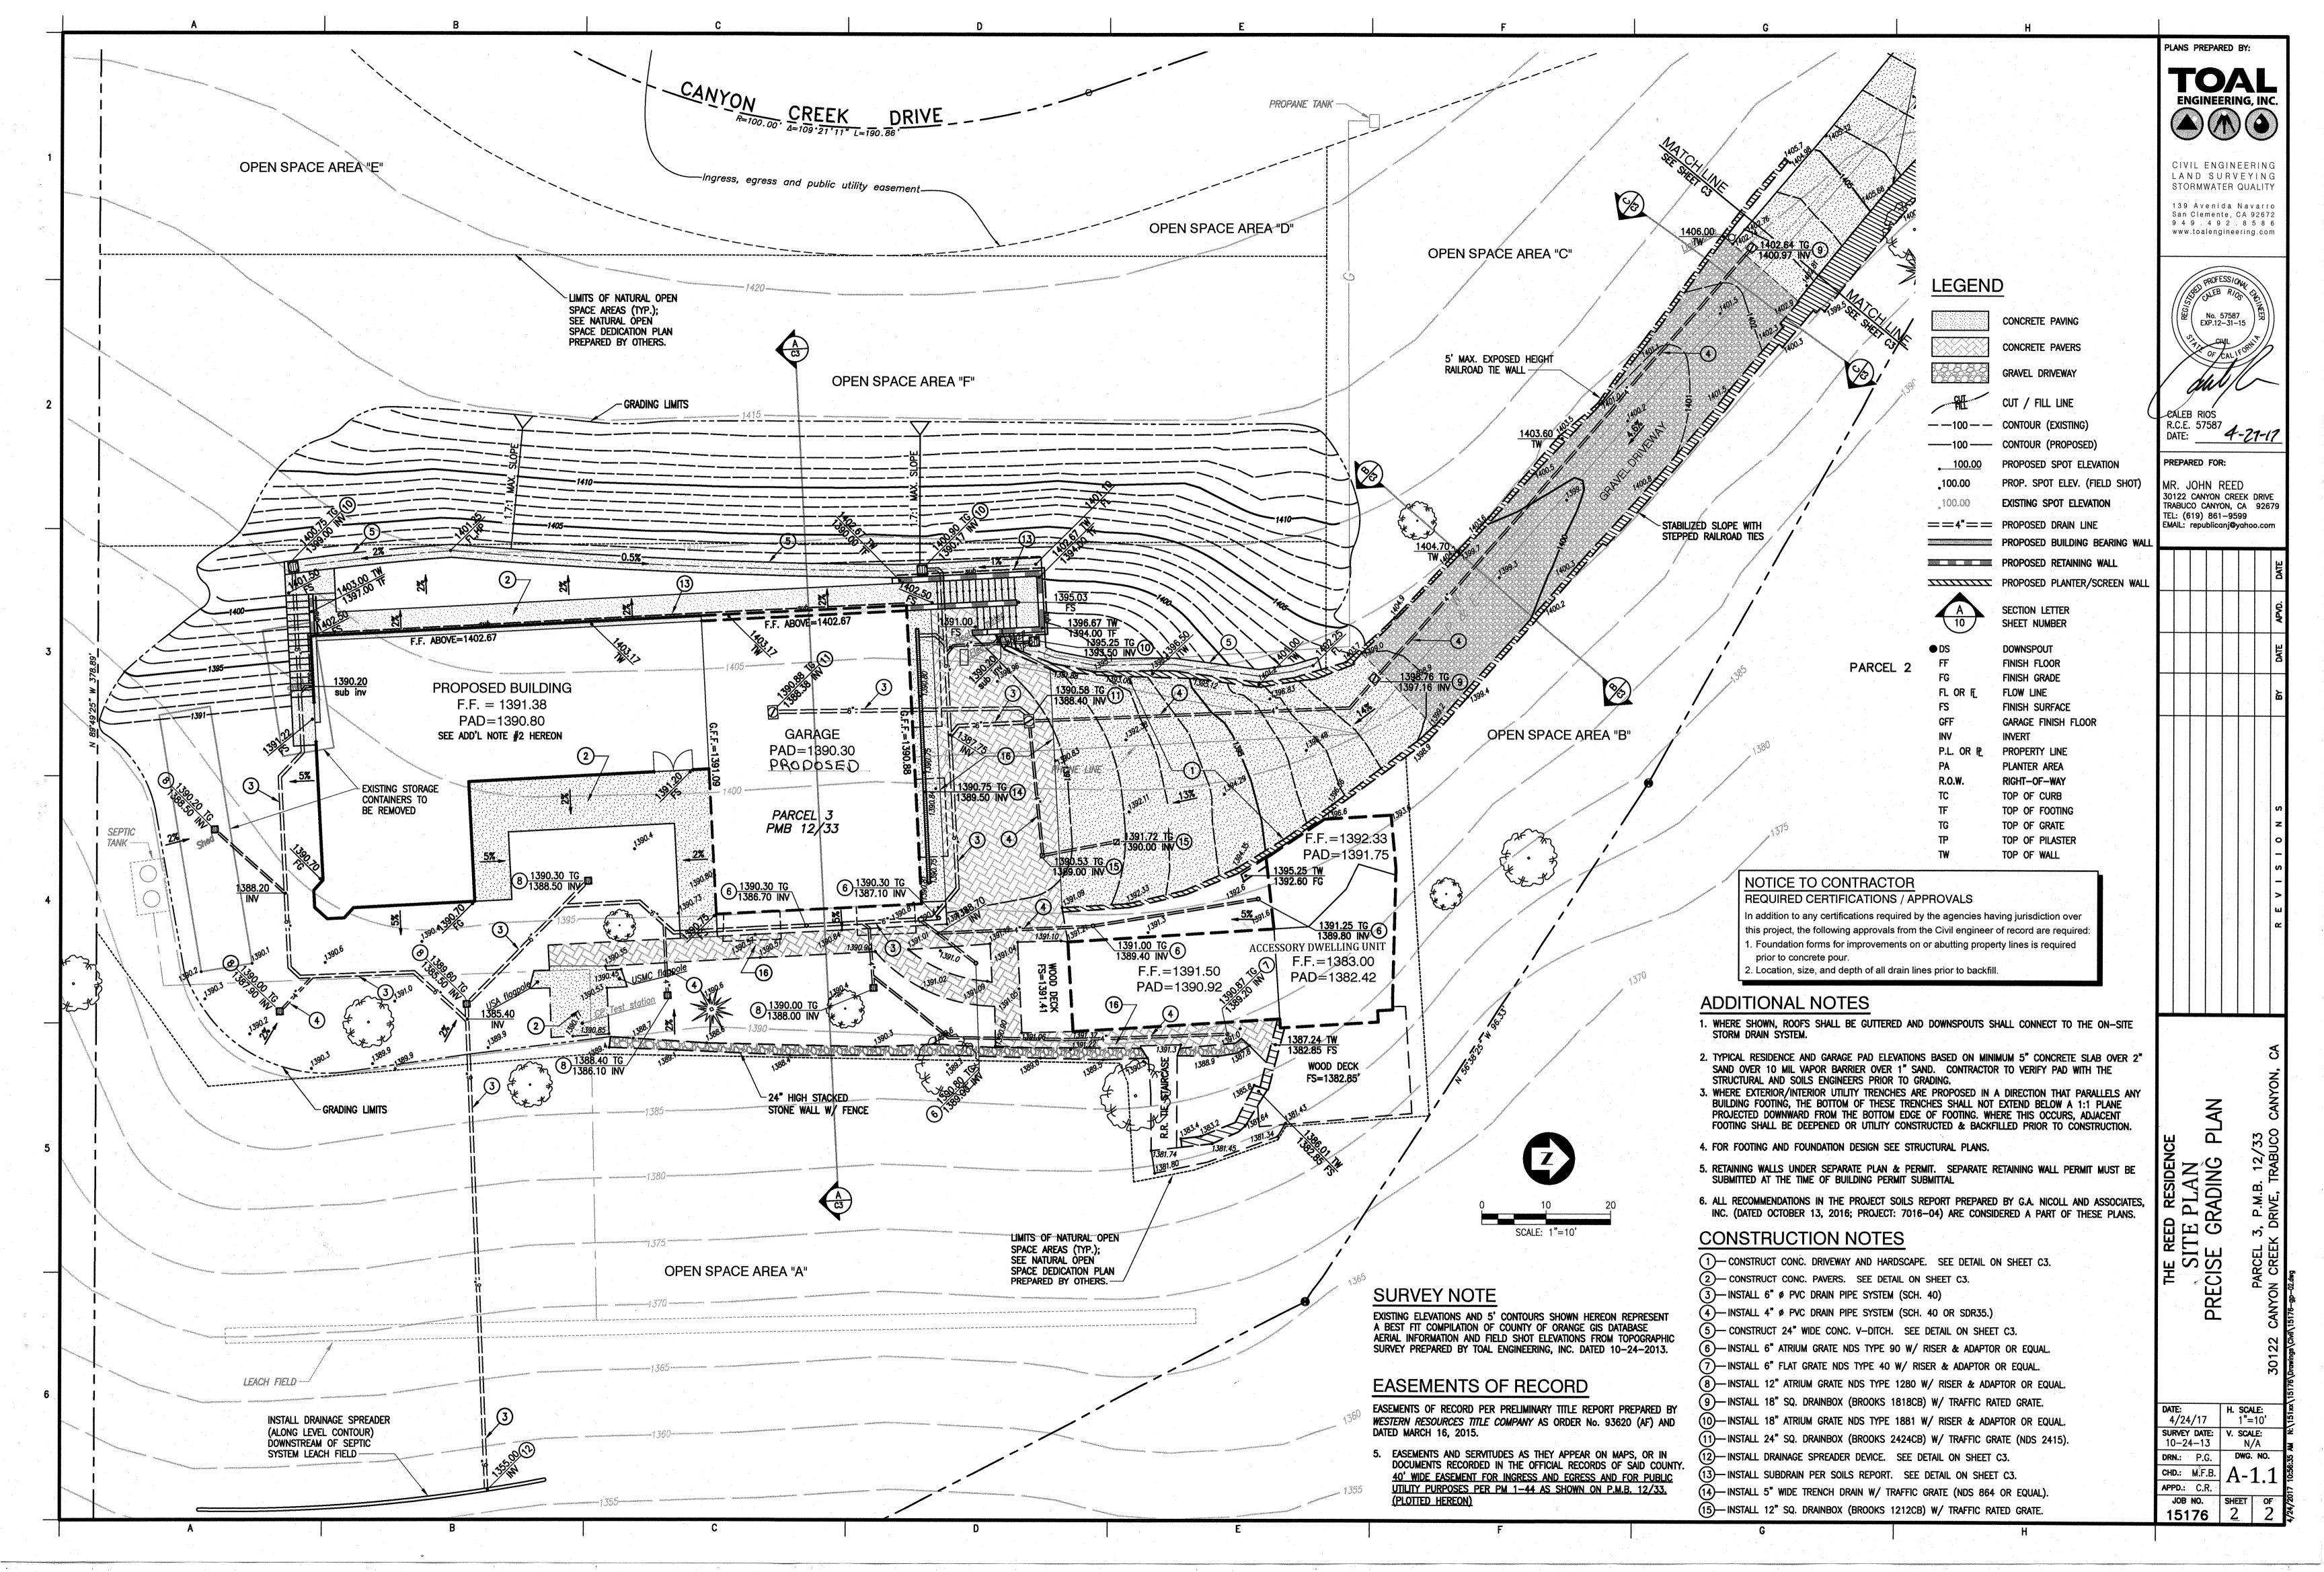

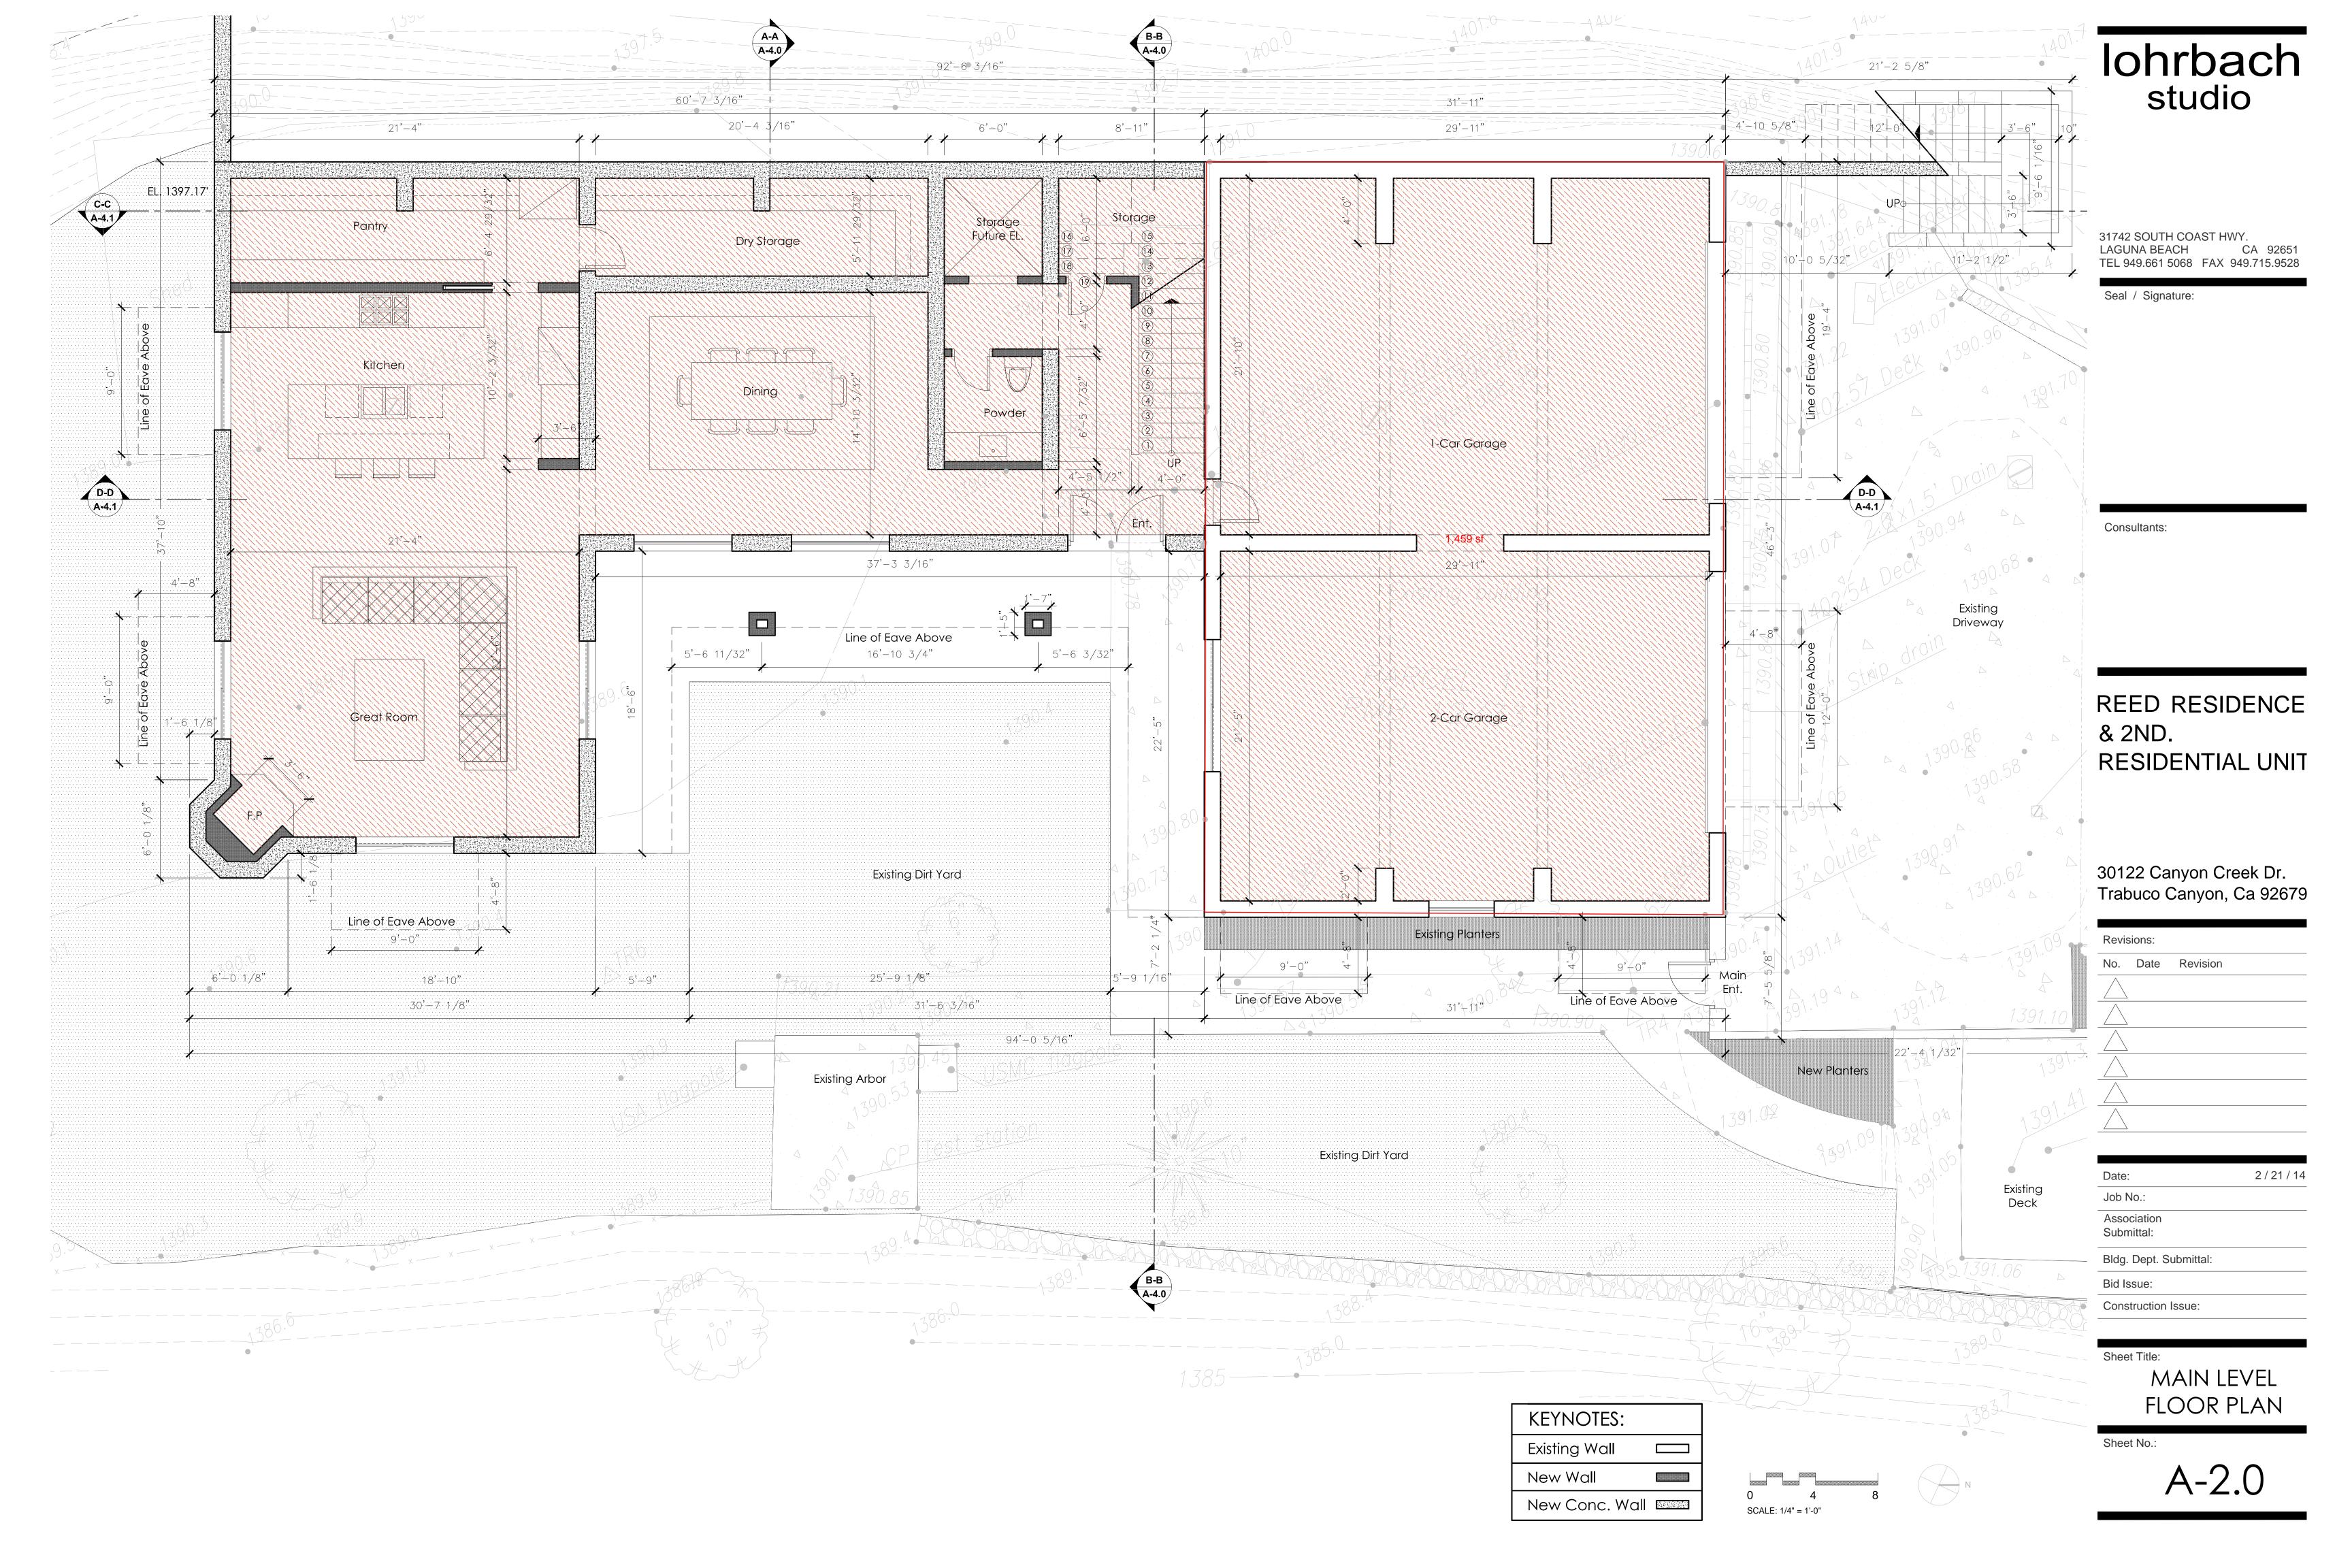

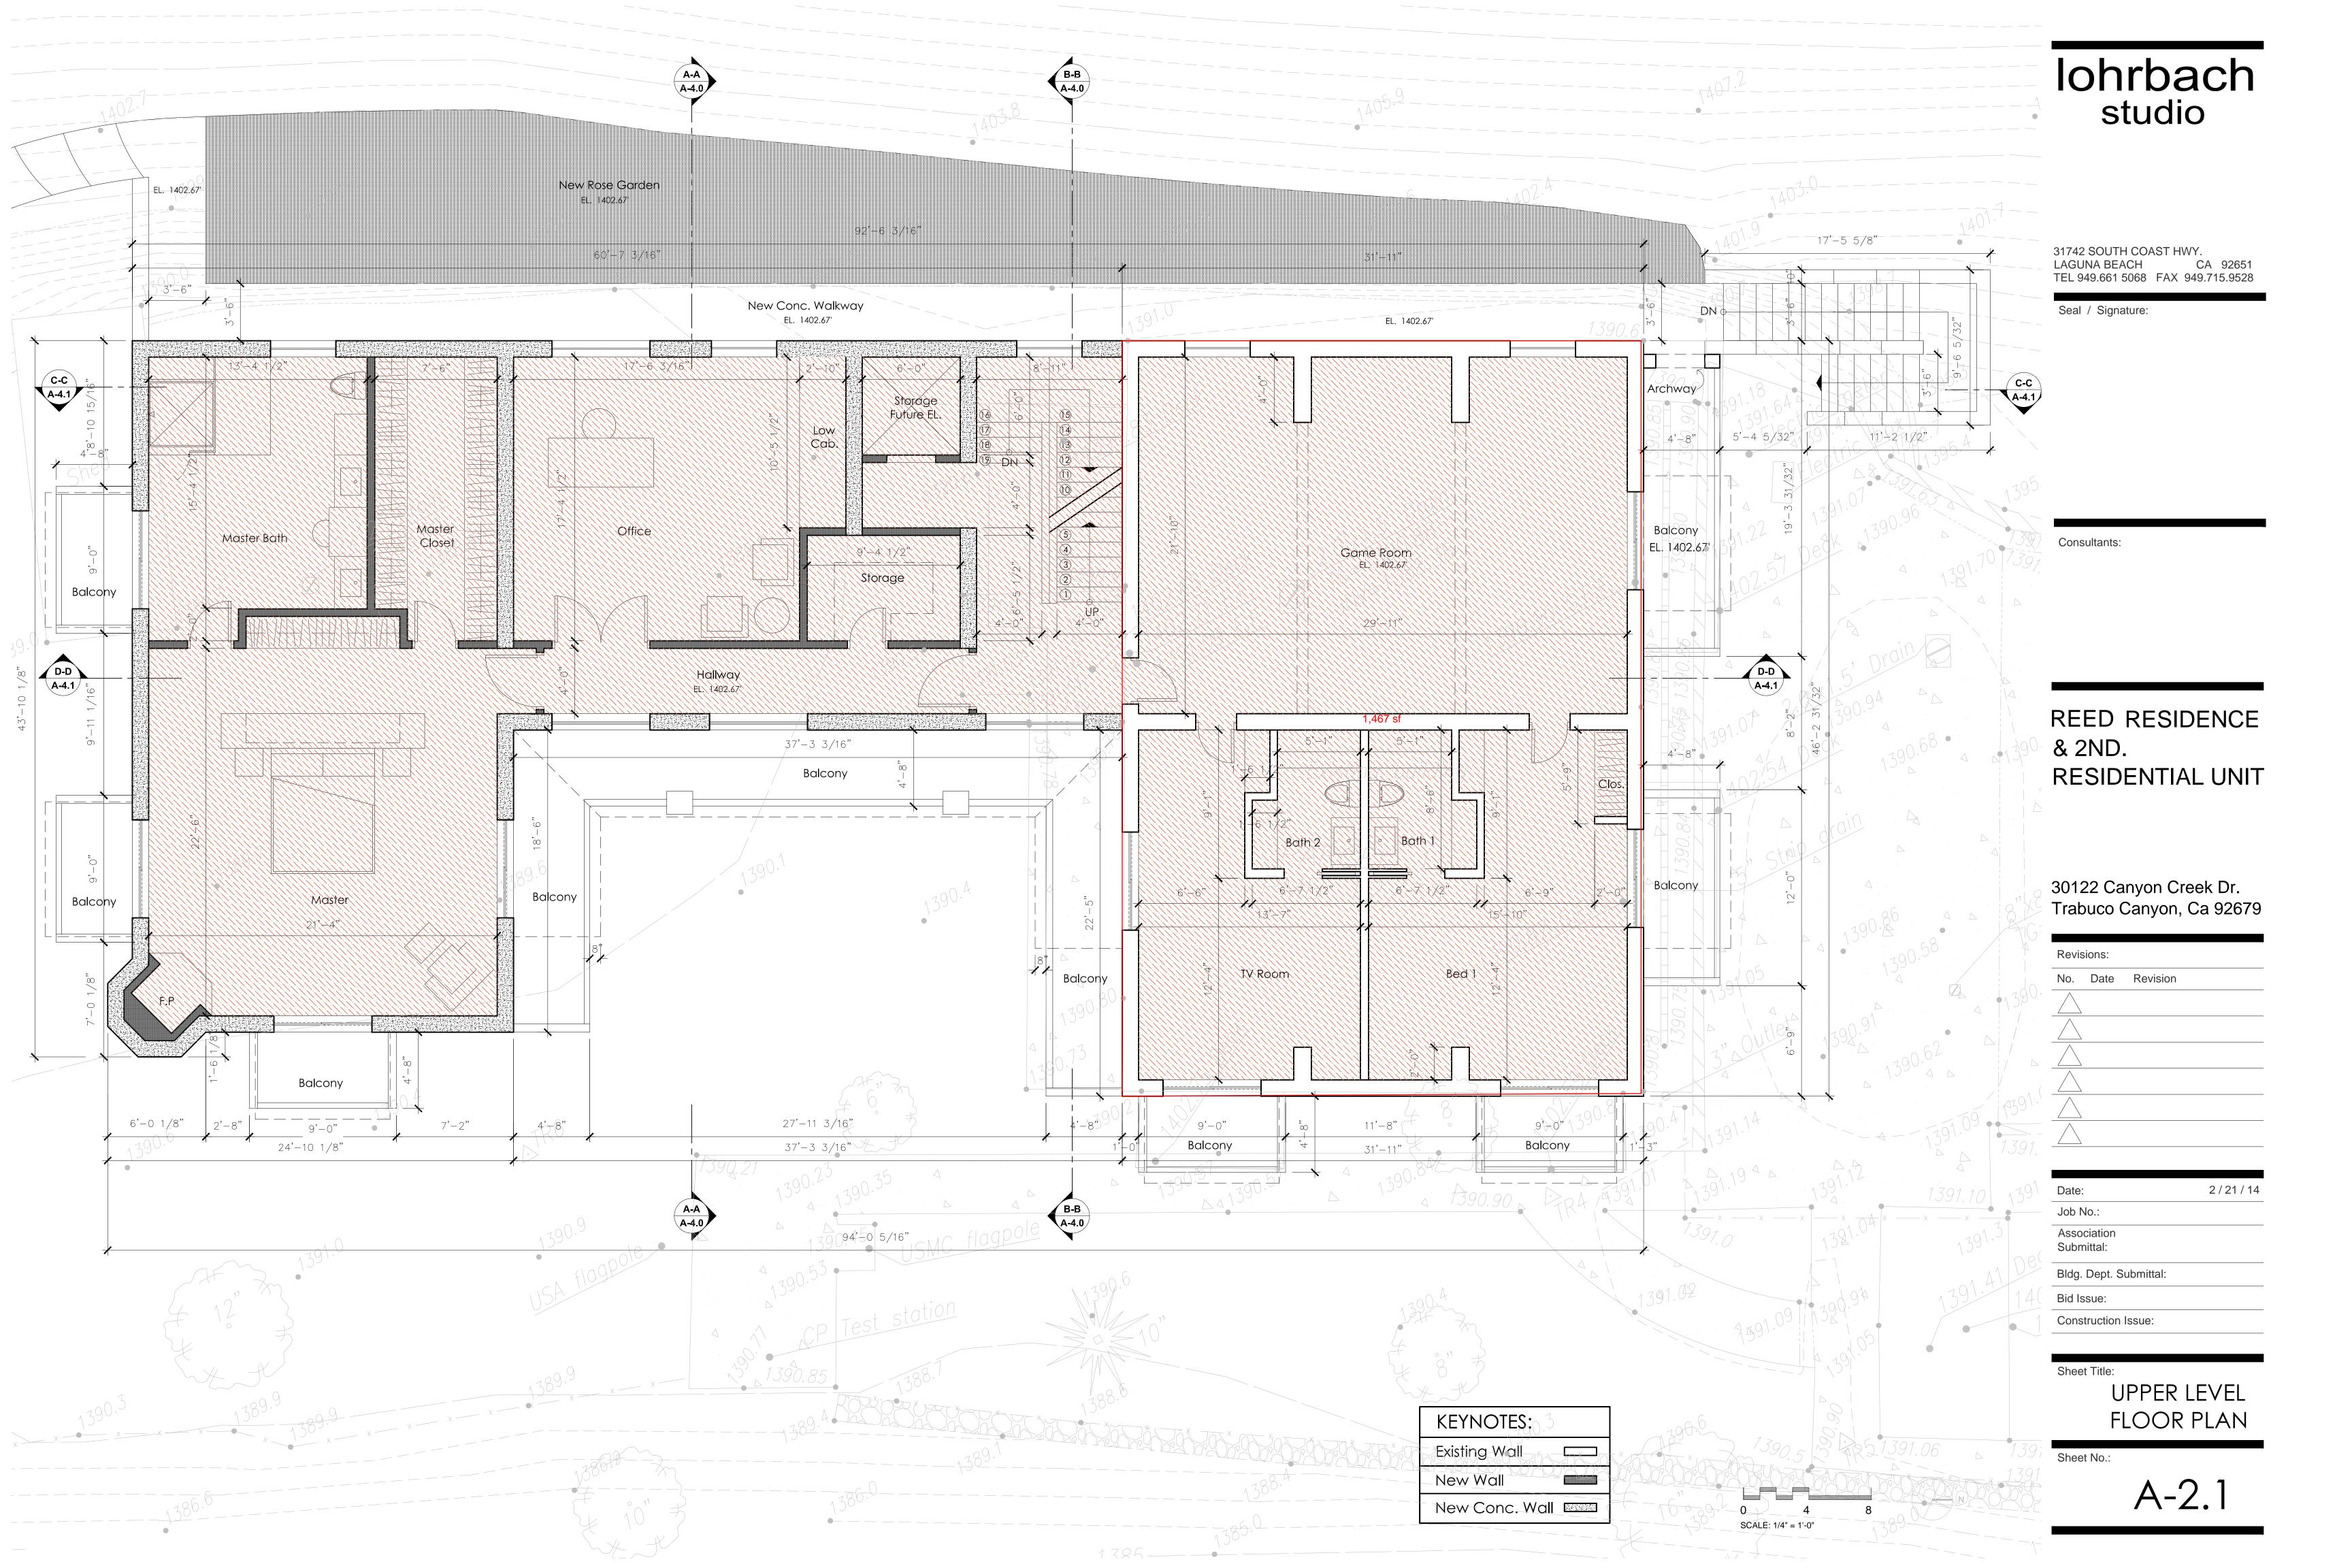

lohrbach studio




Seal / Signature:

Consultants:

REED RESIDENCE & 2ND. RESIDENTIAL UNIT

30122 Canyon Creek Dr. Trabuco Canyon, Ca 92679

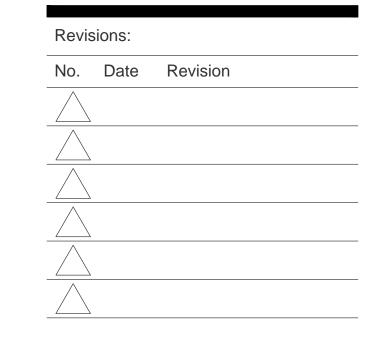


Date:	2 / 21 / 14
Job No.:	
Association Submittal:	
Bldg. Dept. Submittal:	
Bid Issue:	
Construction Issue:	

Sheet Title:


ROOF PLAN

Sheet No.:


A-2.2

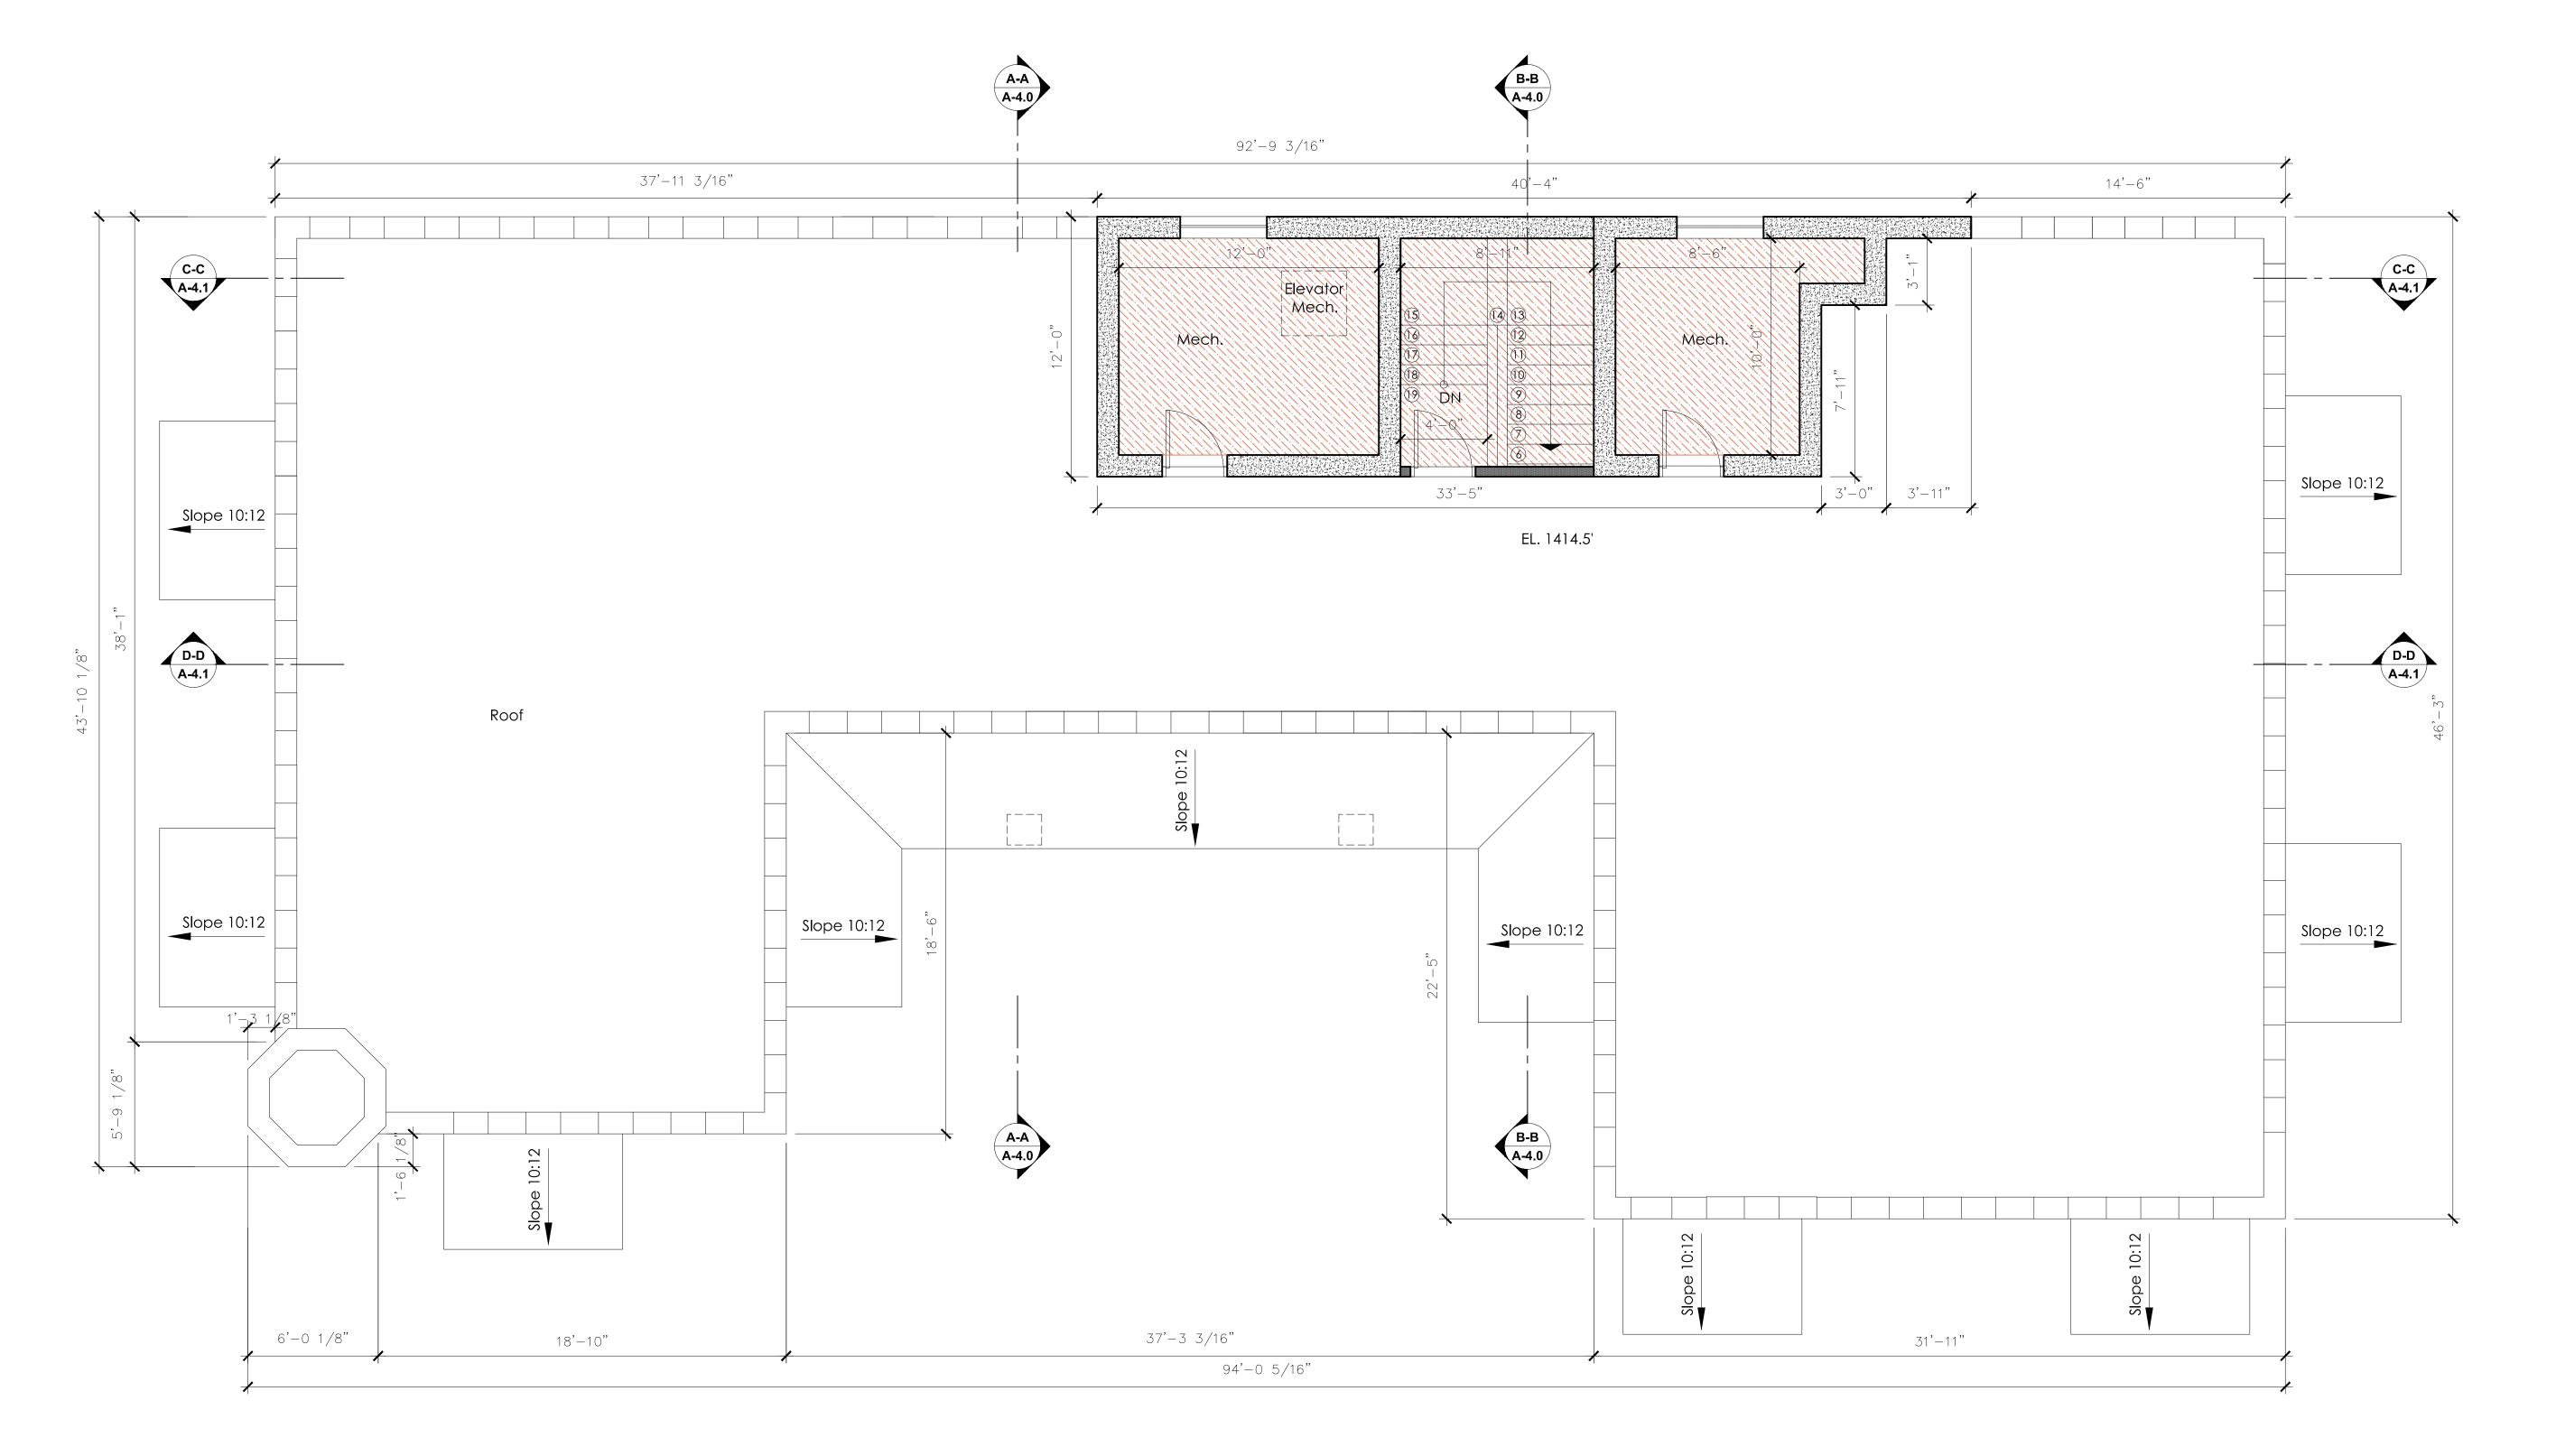

KEYNOTES:	
Existing Wall	
New Wall	
New Conc. Wall	S. 11. 14. 14. 14. 14. 14. 14. 14. 14. 14.

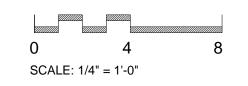

MAX.BUILDING HEIGHT _ EL. 1423.67' T.O. FLAT ROOF EL. 1414.5' MANAMAMAMAMA Market Arthritish Arth John Market Mark MAHAHAHAHAHAHA BHHHHHHHHHHH BHHHHHHHHHHH - Retaining Wall SECOND FIN. FLR. Grade LOT AVG. GRADE EL. 1390.92 SOUTH ELEVATION

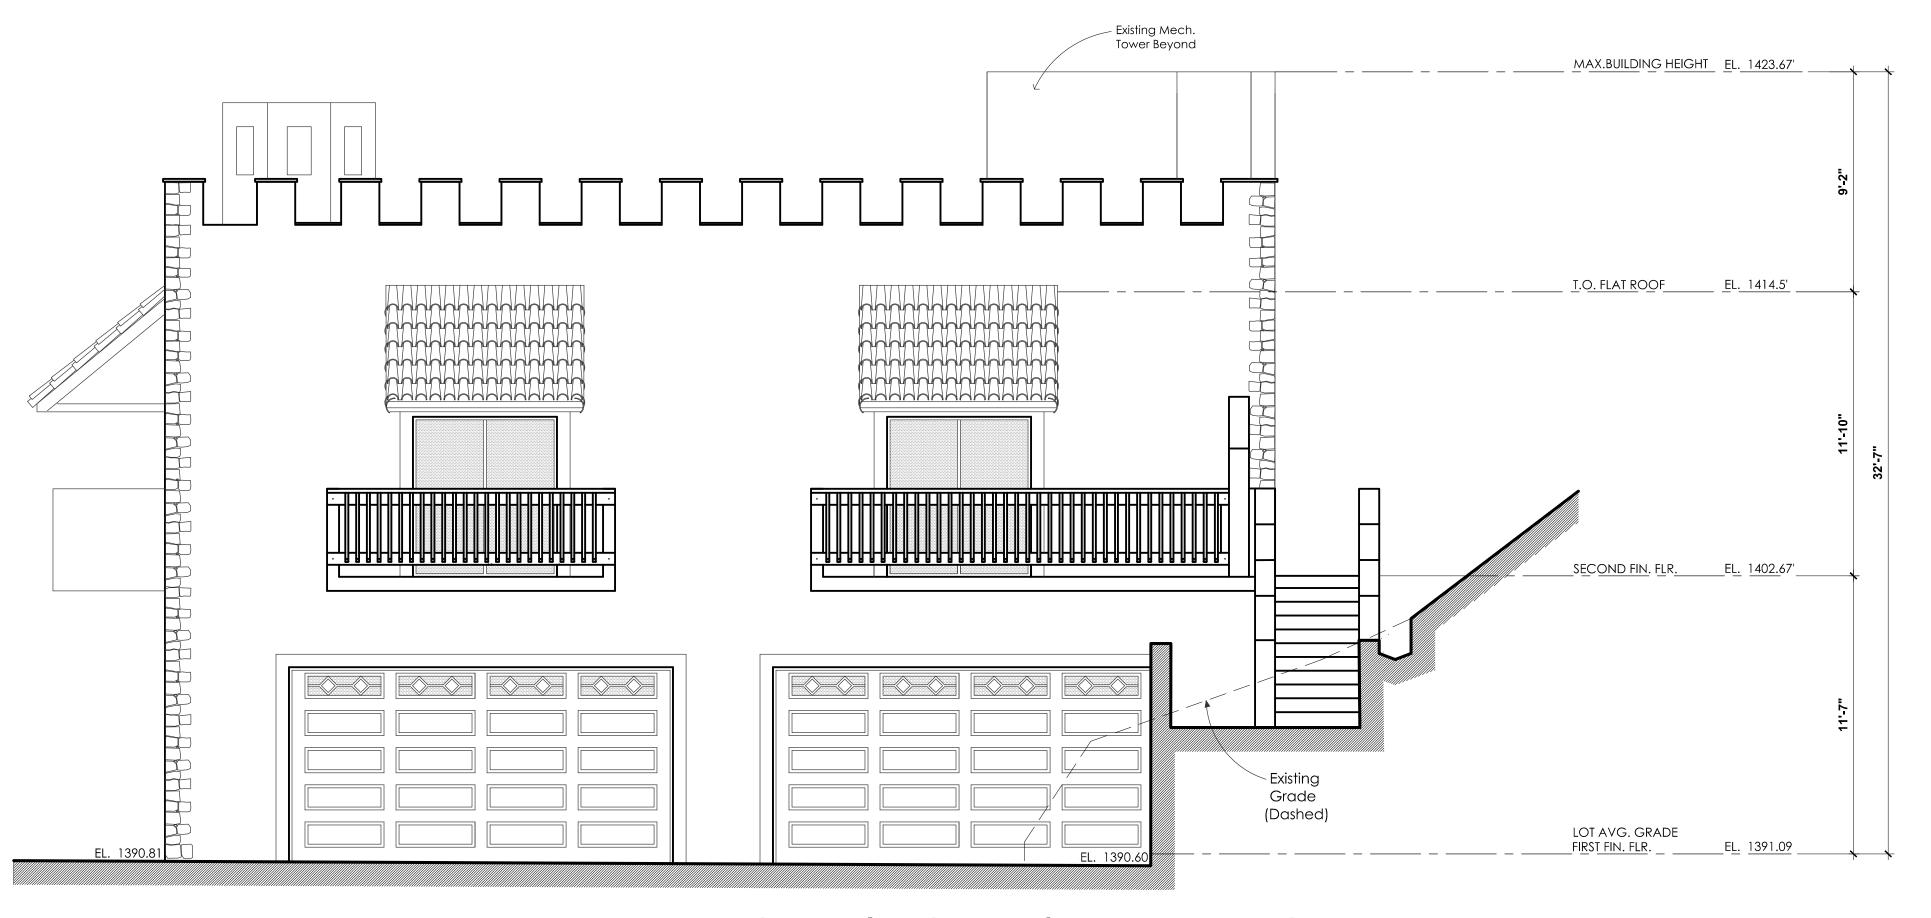

FRONT (NORTH) ELEVATION



31742 SOUTH COAST HWY.

LAGUNA BEACH CA 92651

TEL 949.661 5068 FAX 949.715.9528

Seal / Signature:

Consultants:

REED RESIDENCE & 2ND. RESIDENTIAL UNIT

30122 Canyon Creek Dr. Trabuco Canyon, Ca 92679

Revisions:				
No.	Date	Revision		

Date:	2/21/14
Job No.:	
Association Submittal:	
Bldg. Dept. Submittal:	
Bid Issue:	
Construction Issue:	

Sheet Titl


EXTERIOR ELEVATIONS

Sheet No.:

SCALE: 1/4" = 1'-0"

A-3.0


Iohrbach MAX.BUILDING HEIGHT studio EL. 1423.67 T.O. FLAT ROOF_ EL. 1414.5' 31742 SOUTH COAST HWY. harden ha LAGUNA BEACH TEL 949.661 5068 FAX 949.715.9528 Seal / Signature: MANAHAHAHAHAHA MANAHAMANAHA AHHHHHHHHHH BHHHHHHHHHH AHHHHHHHHHH SECOND FIN. FLR. EL. 1402.67' Consultants: LOT AVG. GRADE FIRST FIN. FLR. EAST ELEVATION REED RESIDENCE

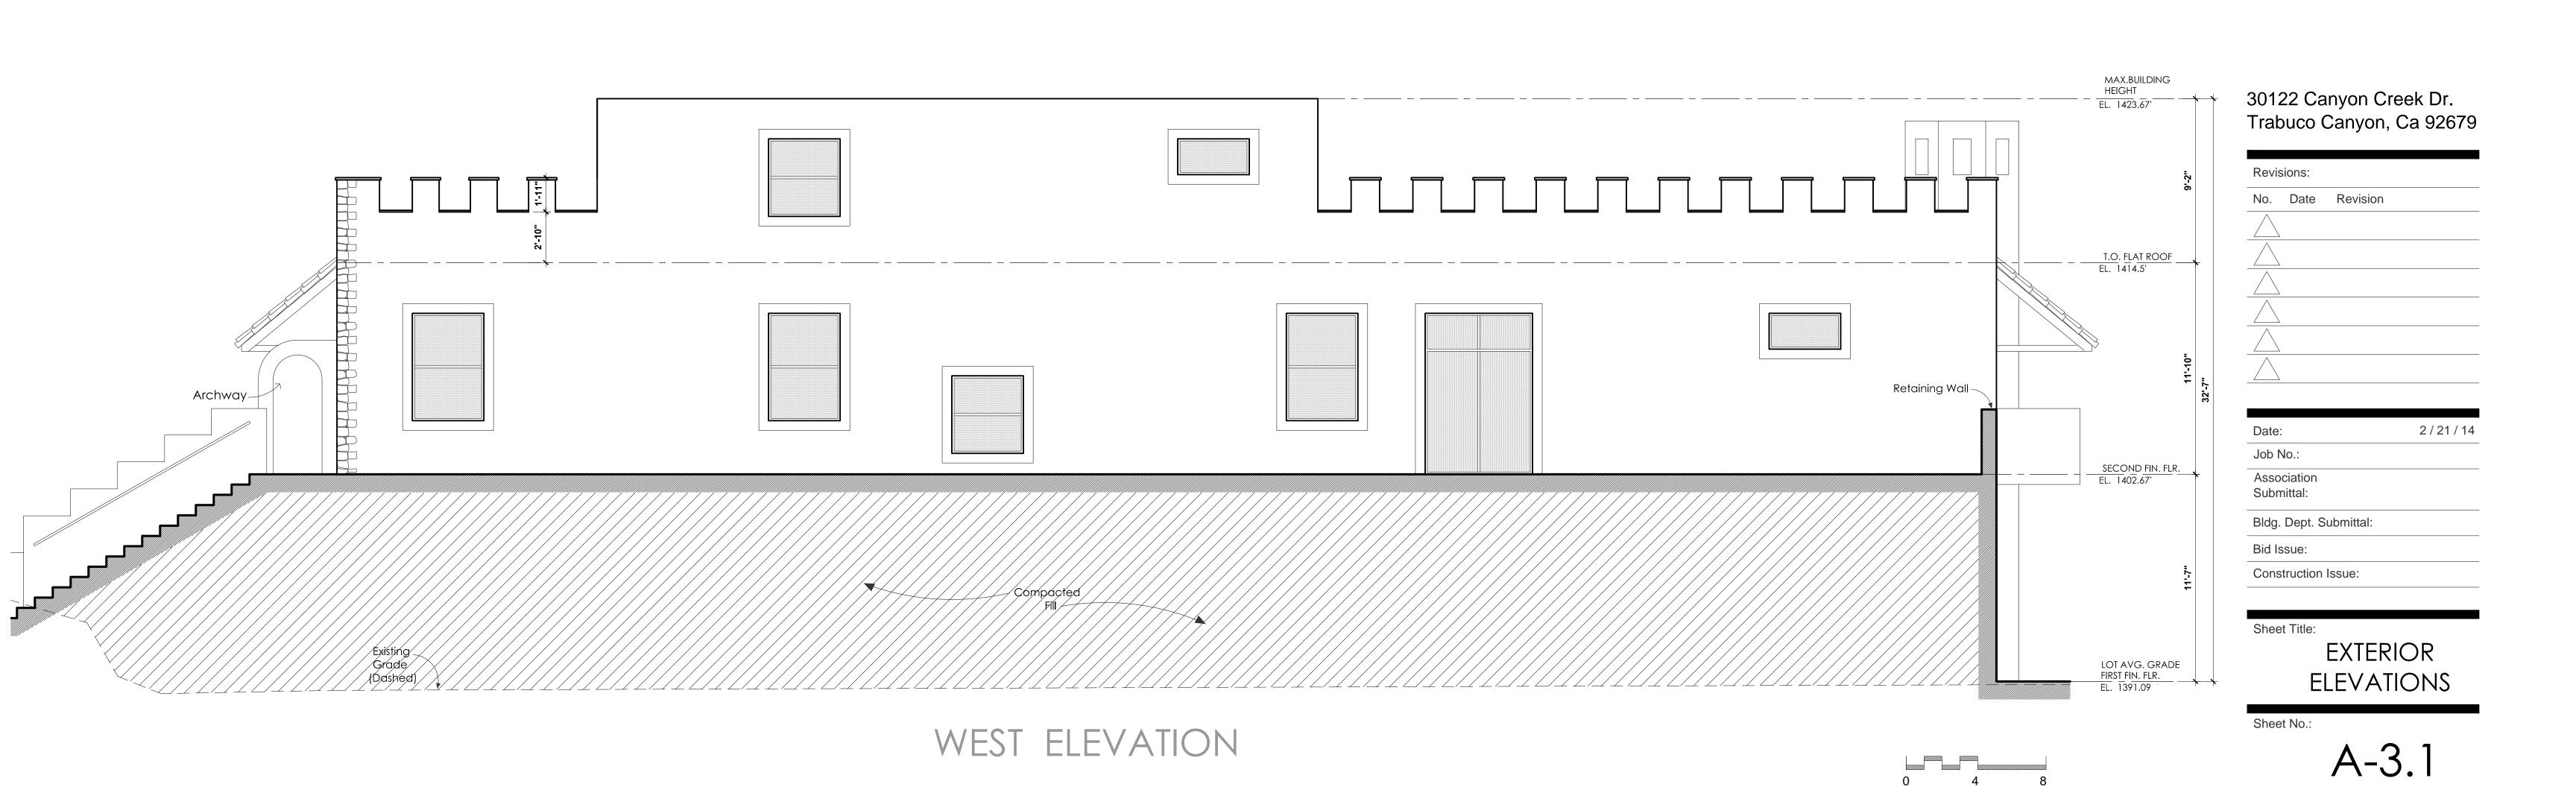


& 2ND.

SCALE: 1/4" = 1'-0"

RESIDENTIAL UNIT

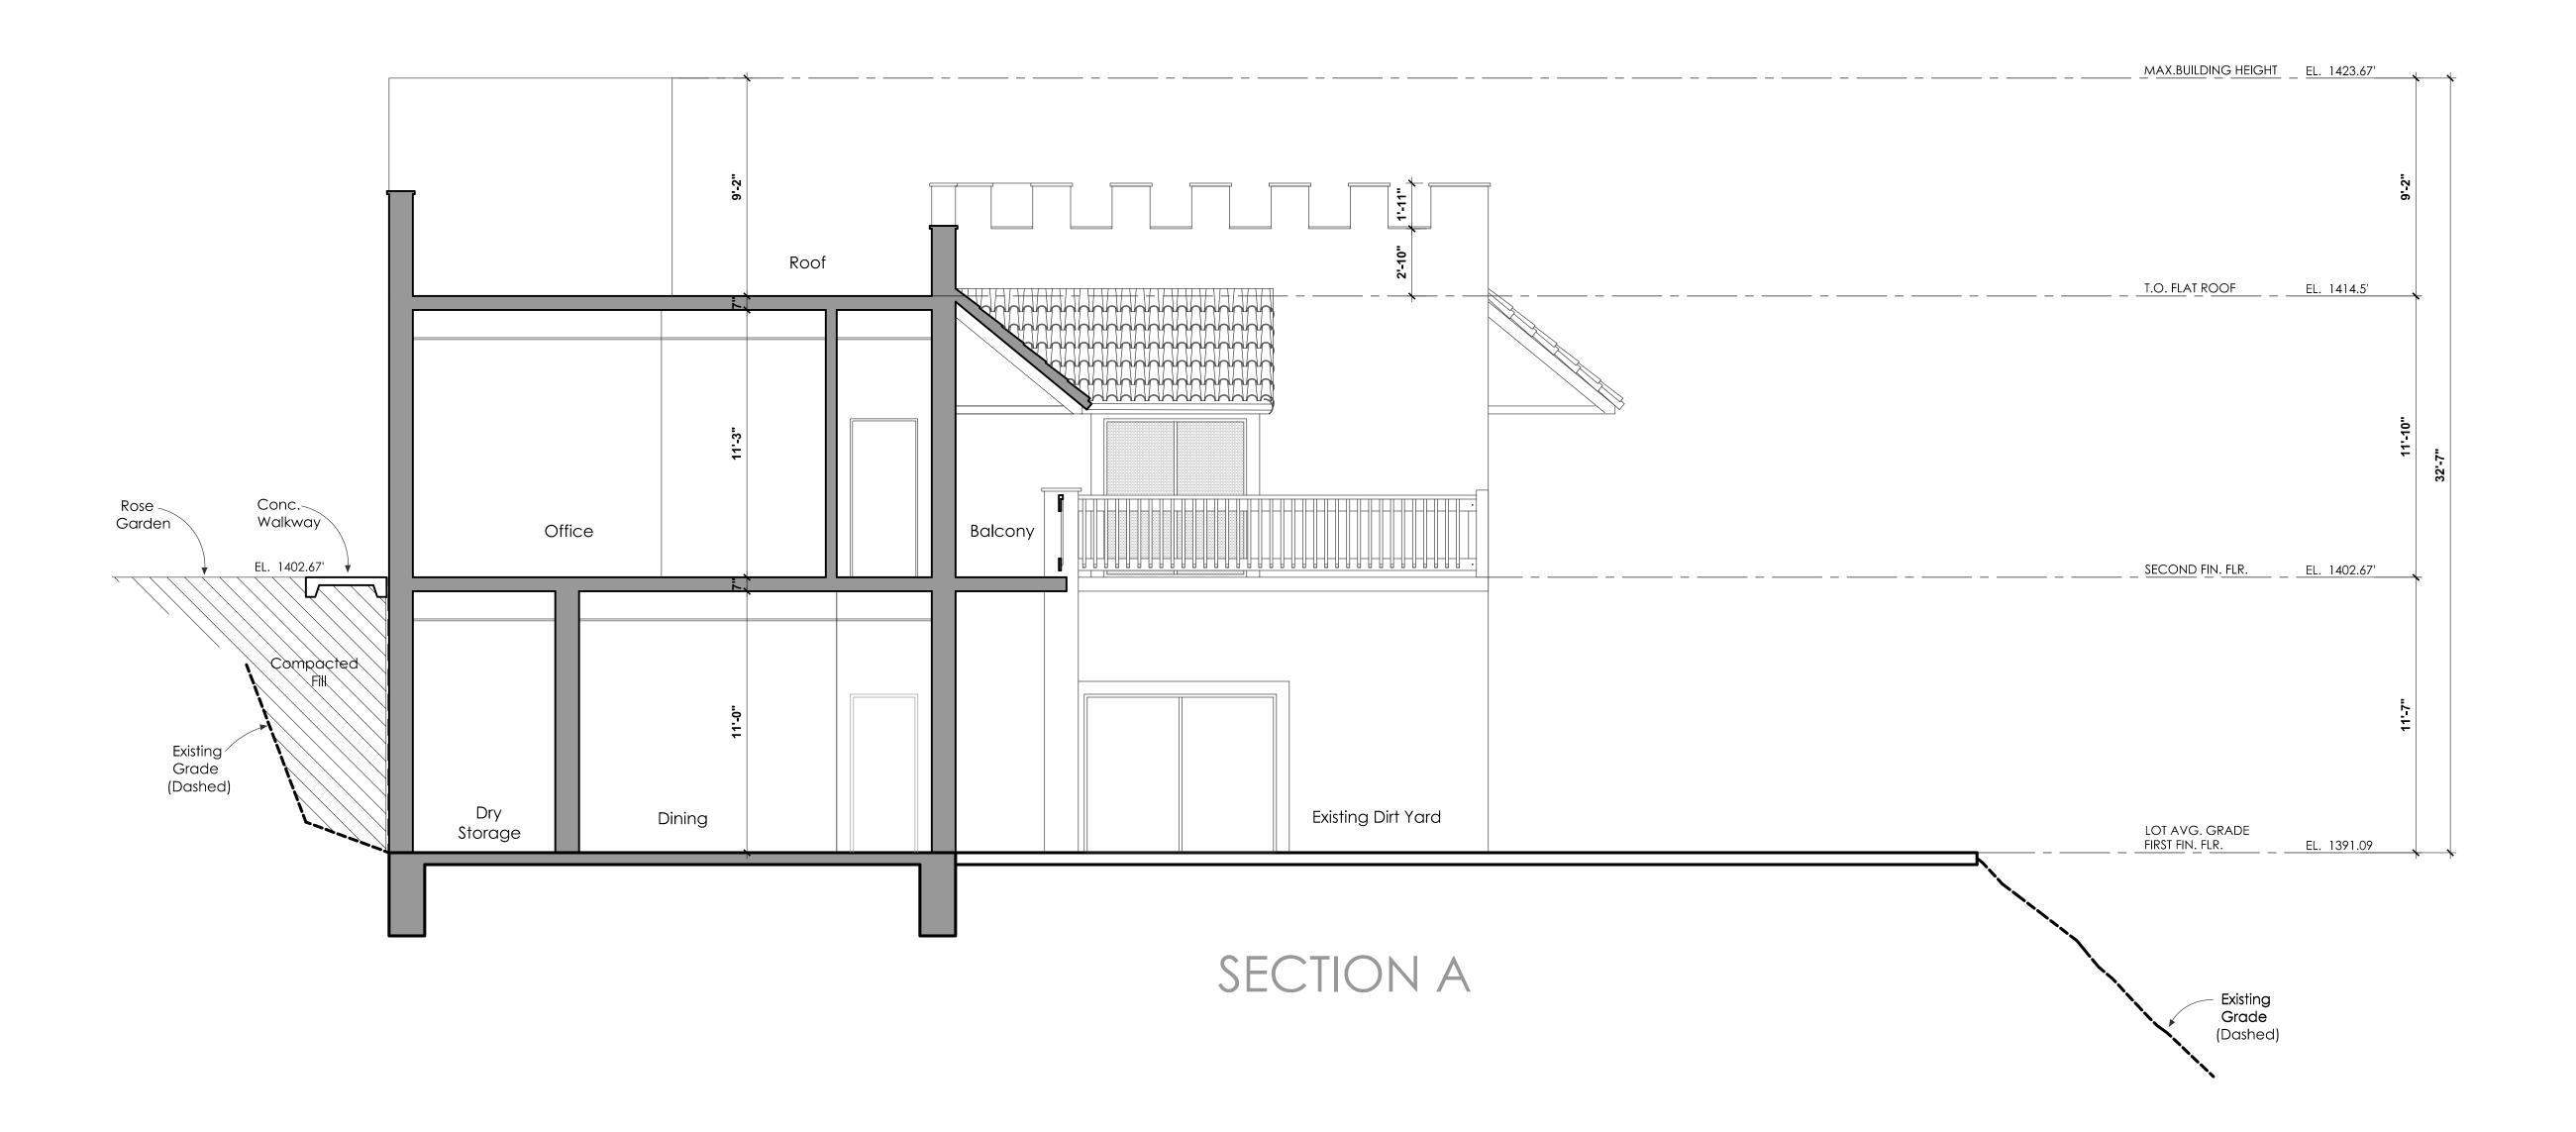

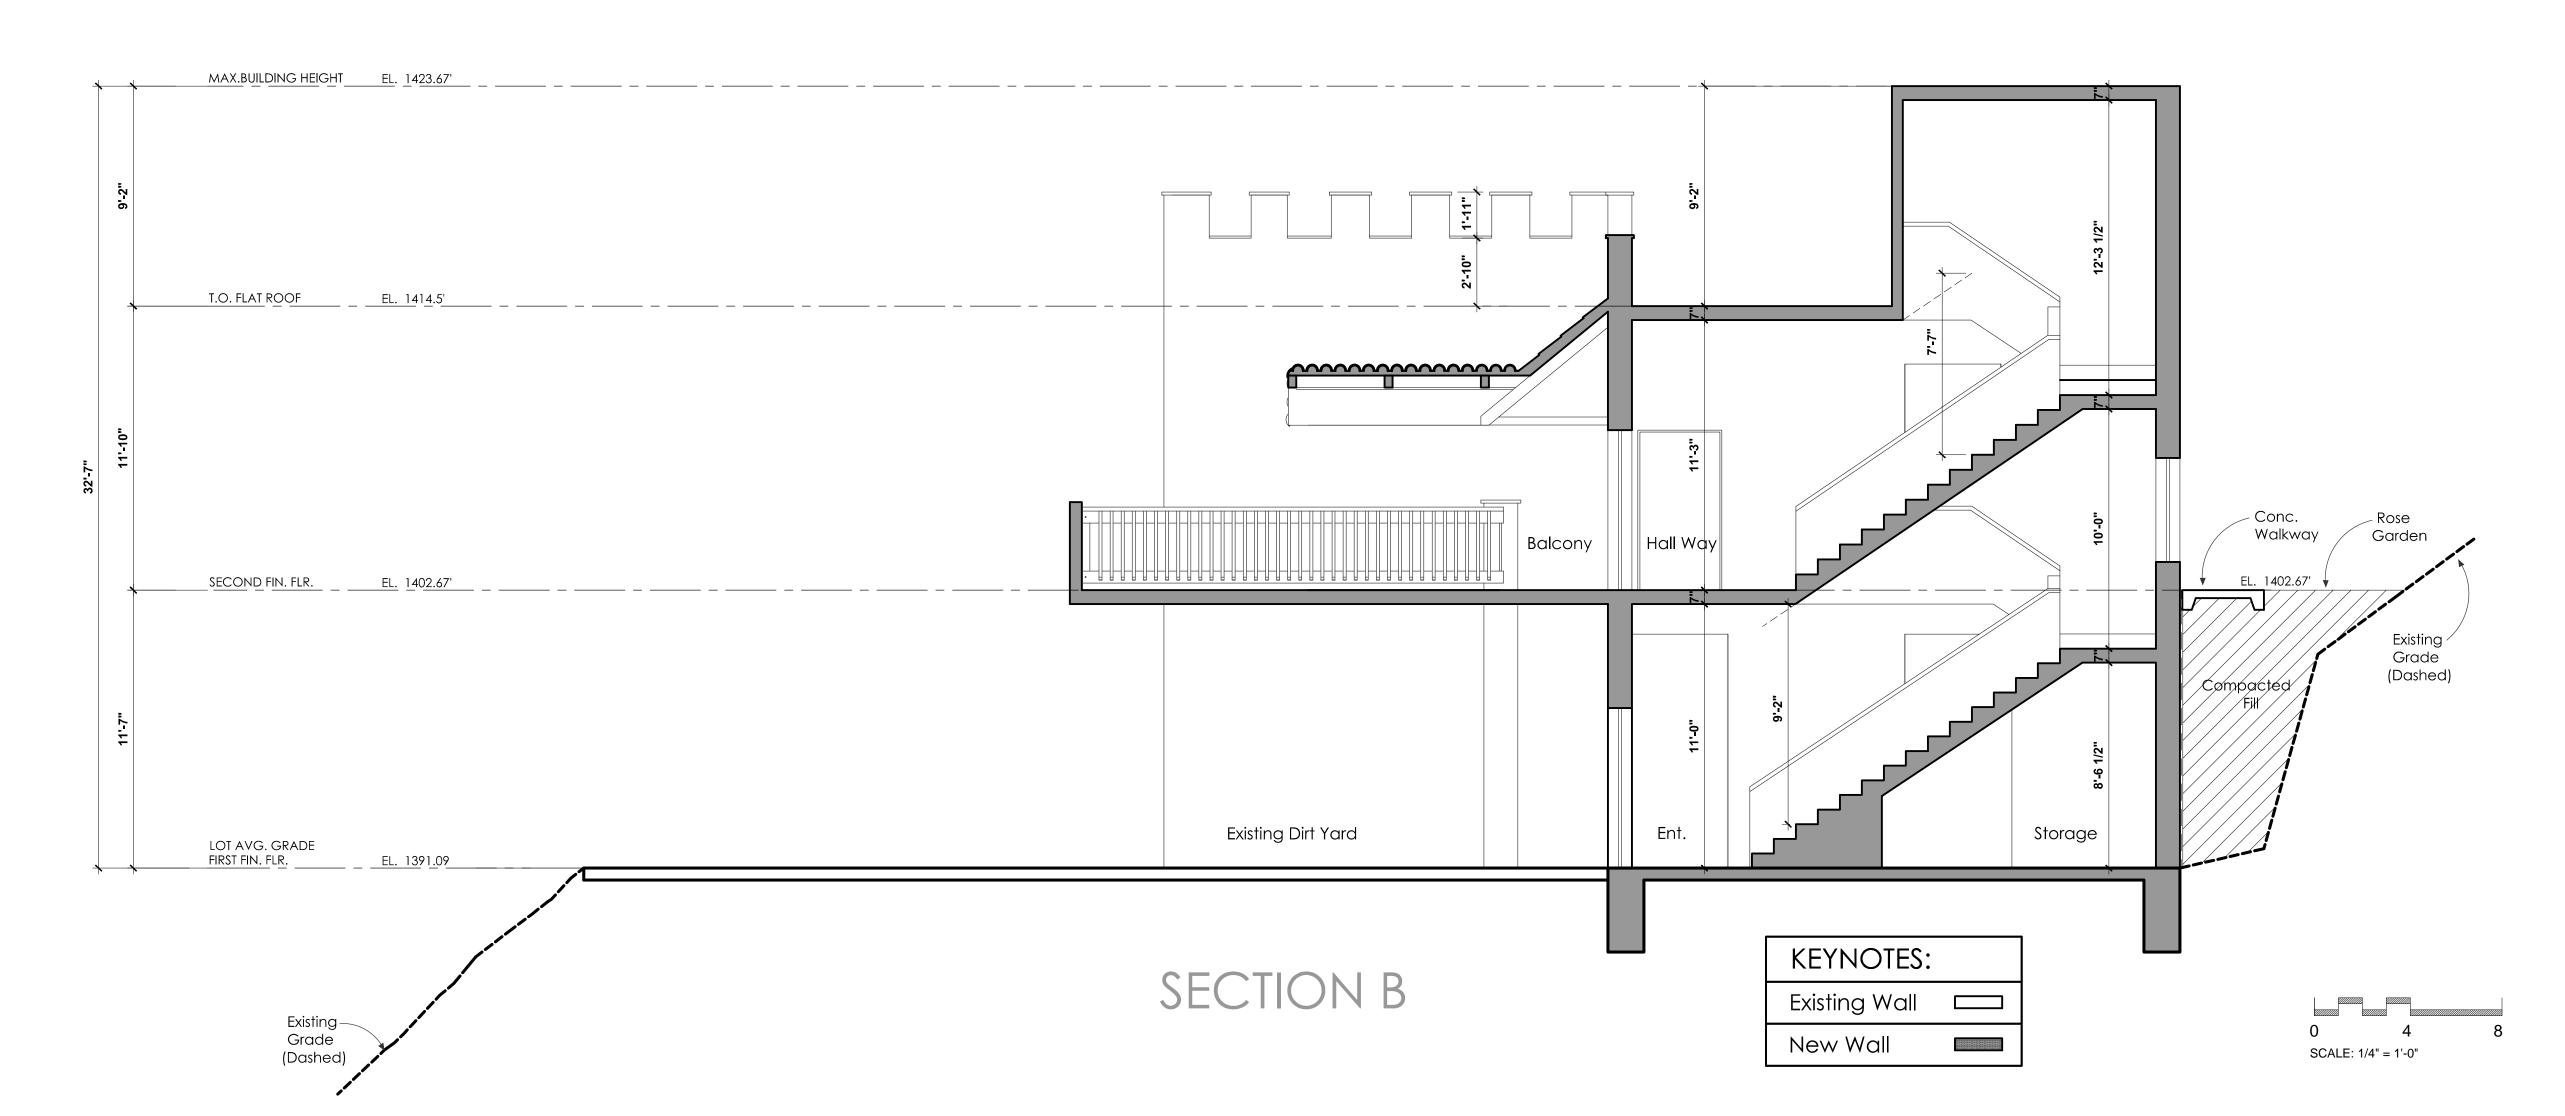

lohrbach studio

31742 SOUTH COAST HWY.

LAGUNA BEACH CA 92651

TEL 949.661 5068 FAX 949.715.9528

Seal / Signature:

Consultants:

REED RESIDENCE & 2ND. RESIDENTIAL UNIT

30122 Canyon Creek Dr. Trabuco Canyon, Ca 92679

Revis	Revisions:				
No.	Date	Revision			


Date:	2/21/14
Job No.:	
Association Submittal:	
Bldg. Dept. Submittal:	
Bid Issue:	
Construction Issue:	


Sheet Title:


BUILDING SECTIONS

Sheet No.:

A-4.0

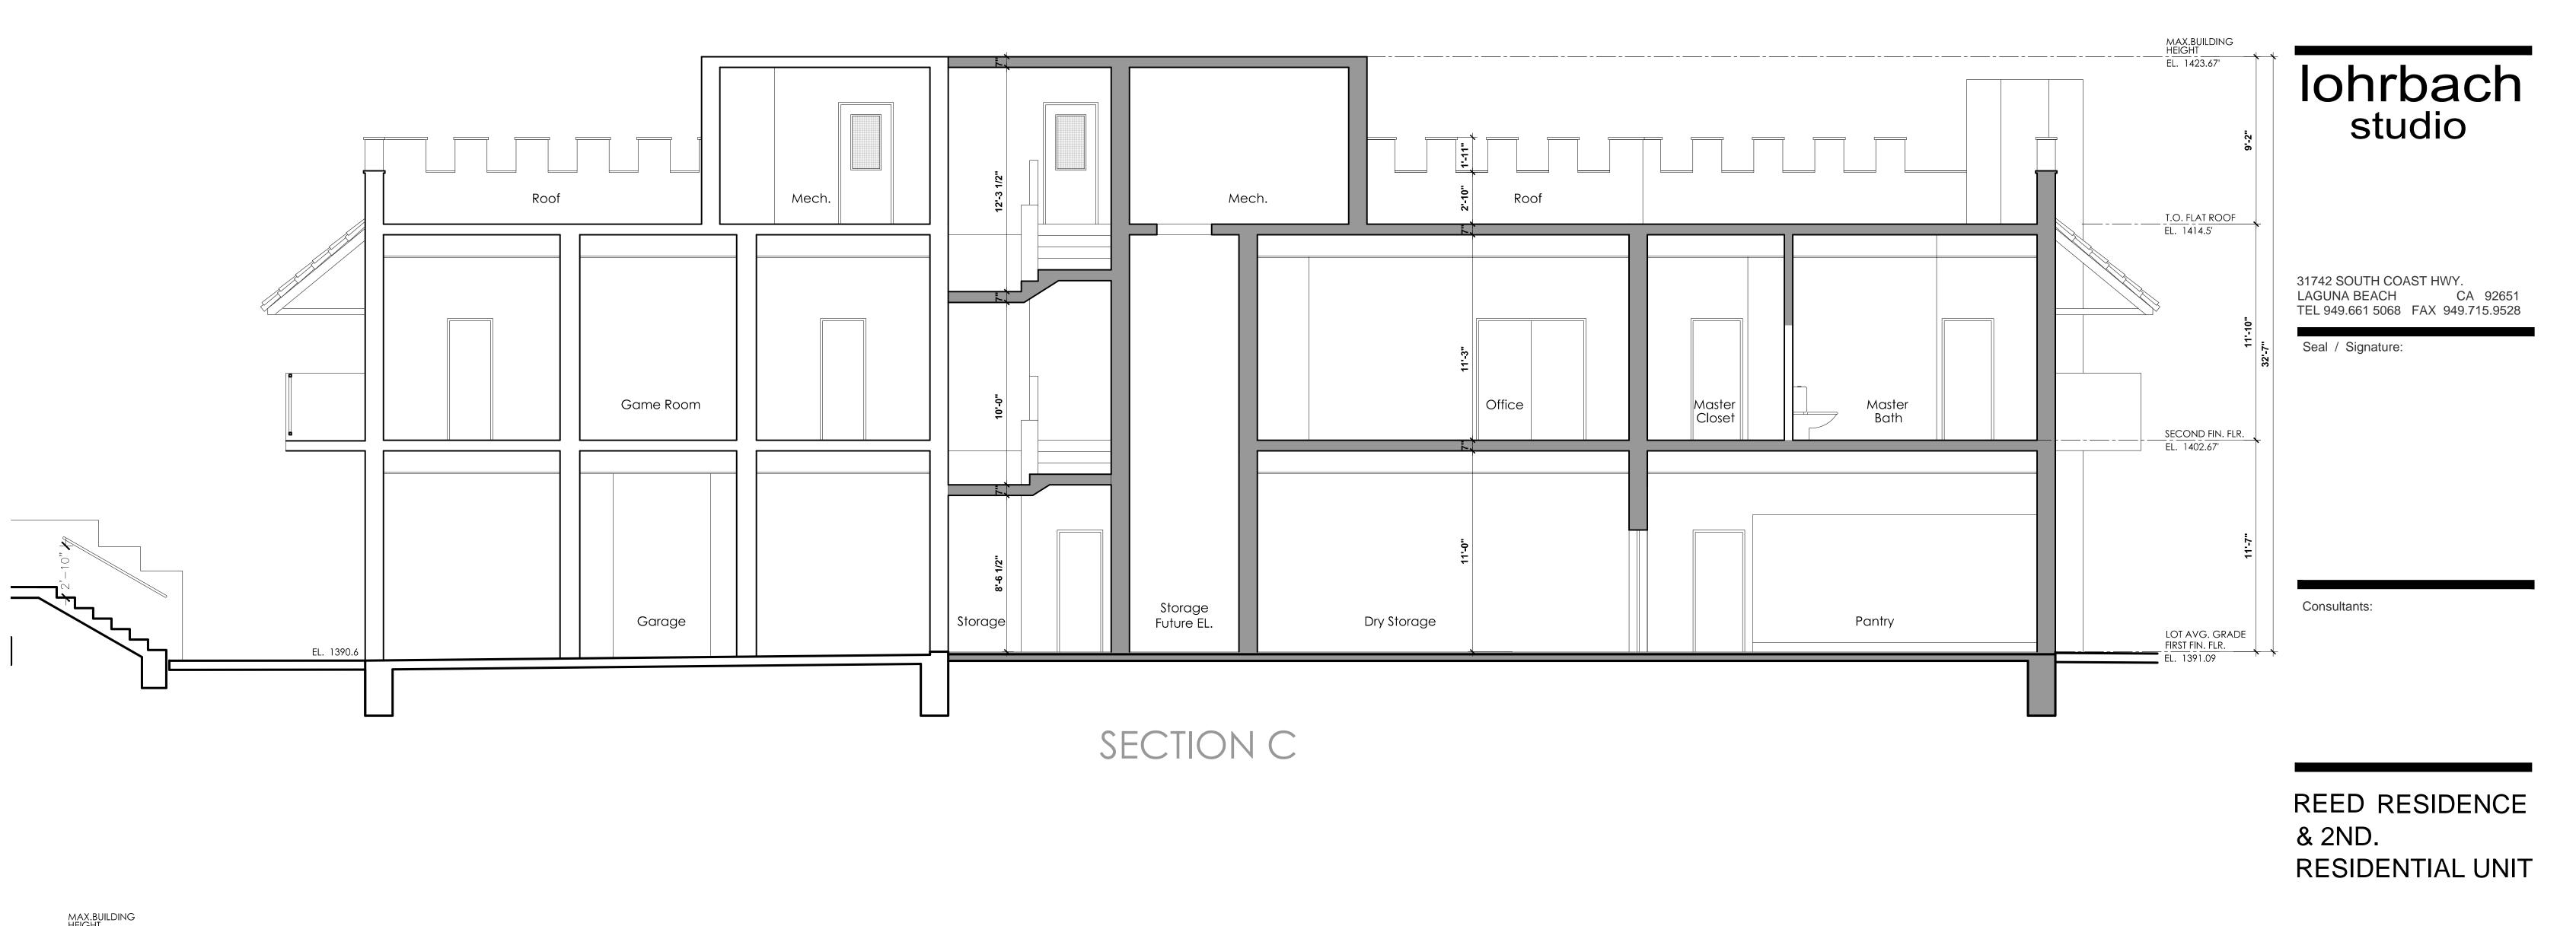

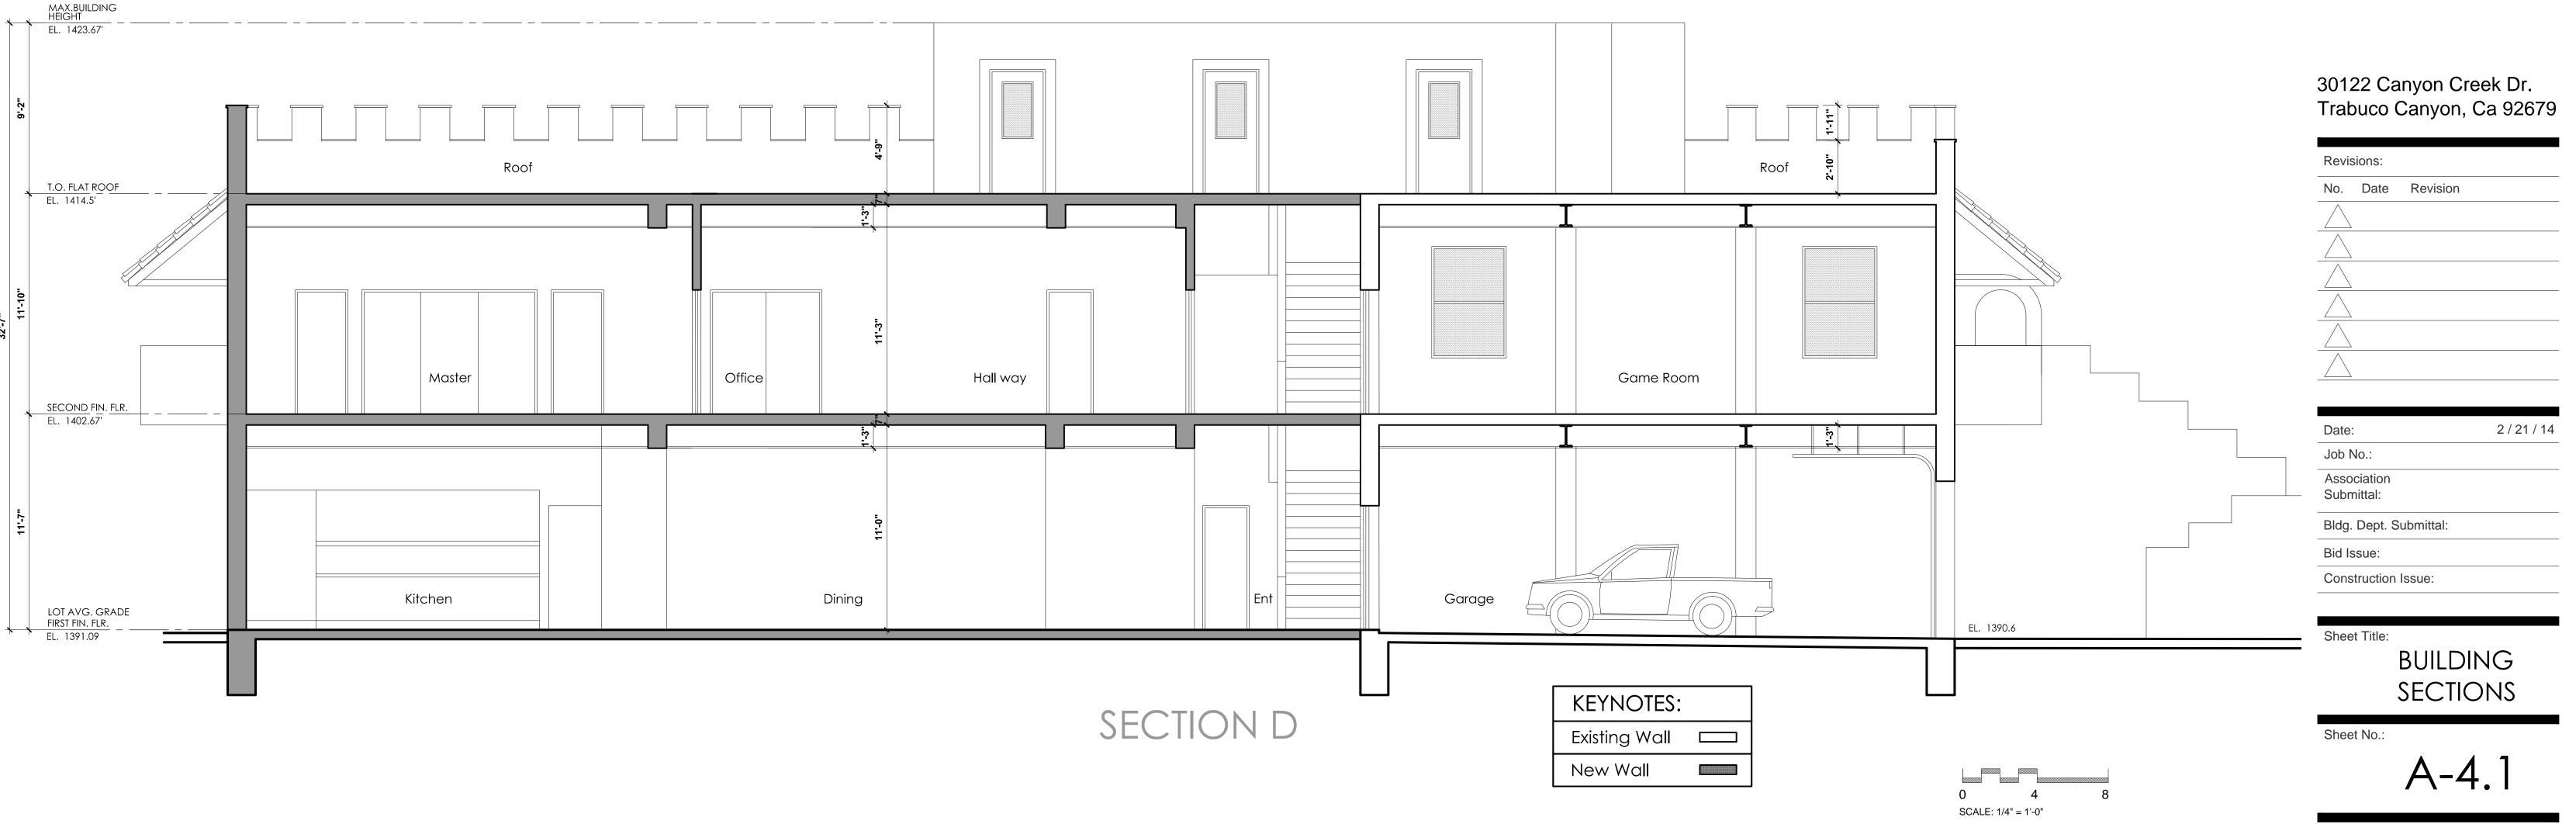

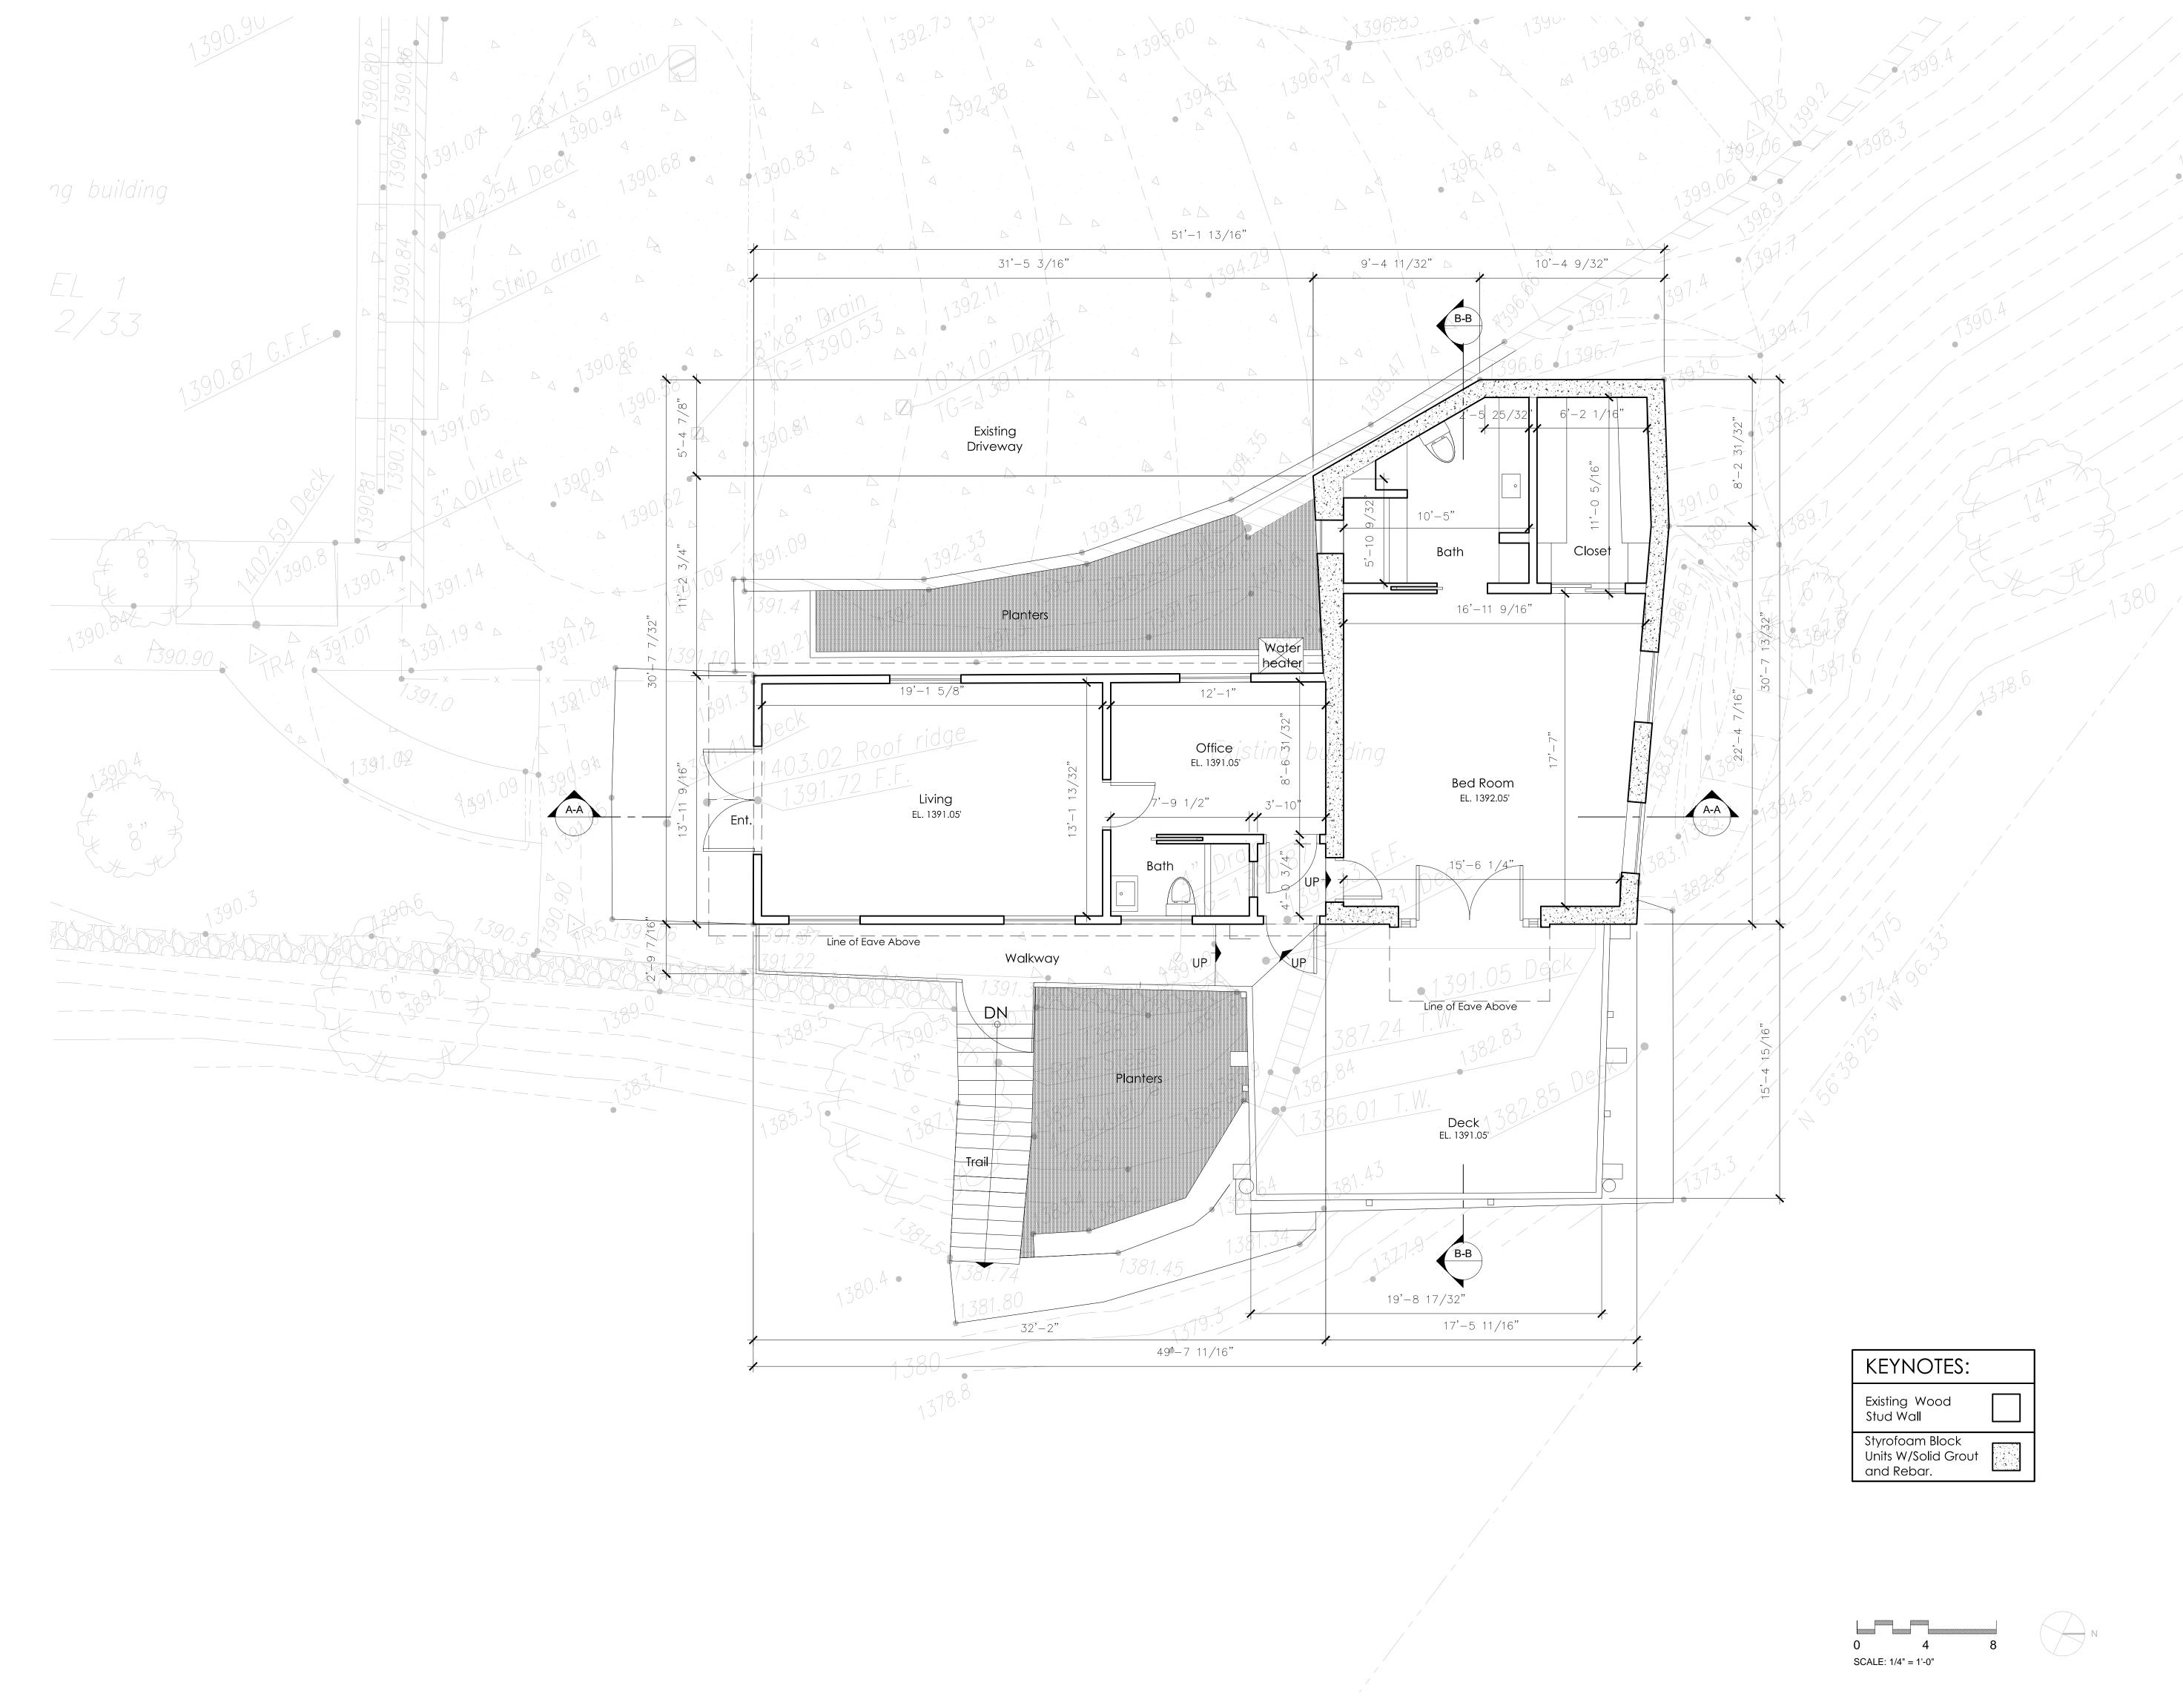

Iohrbach studio

31742 SOUTH COAST HWY.

LAGUNA BEACH CA 92651

TEL 949.661 5068 FAX 949.715.9528

Seal / Signature:

Consultants:

REED RESIDENCE & 2ND. RESIDENTIAL UNIT

30122 Canyon Creek Dr. Trabuco Canyon, Ca 92679

Revis	Revisions:				
No.	Date	Revision			

Date: 2 / 21 / 14

Job No.:

Association
Submittal:

Bldg. Dept. Submittal:


Bid Issue:

Construction Issue:

Sheet Title:
PERMITTED 2ND UNIT
MAIN LEVEL
FLOOR PLAN

Sheet No.:

A-5.0

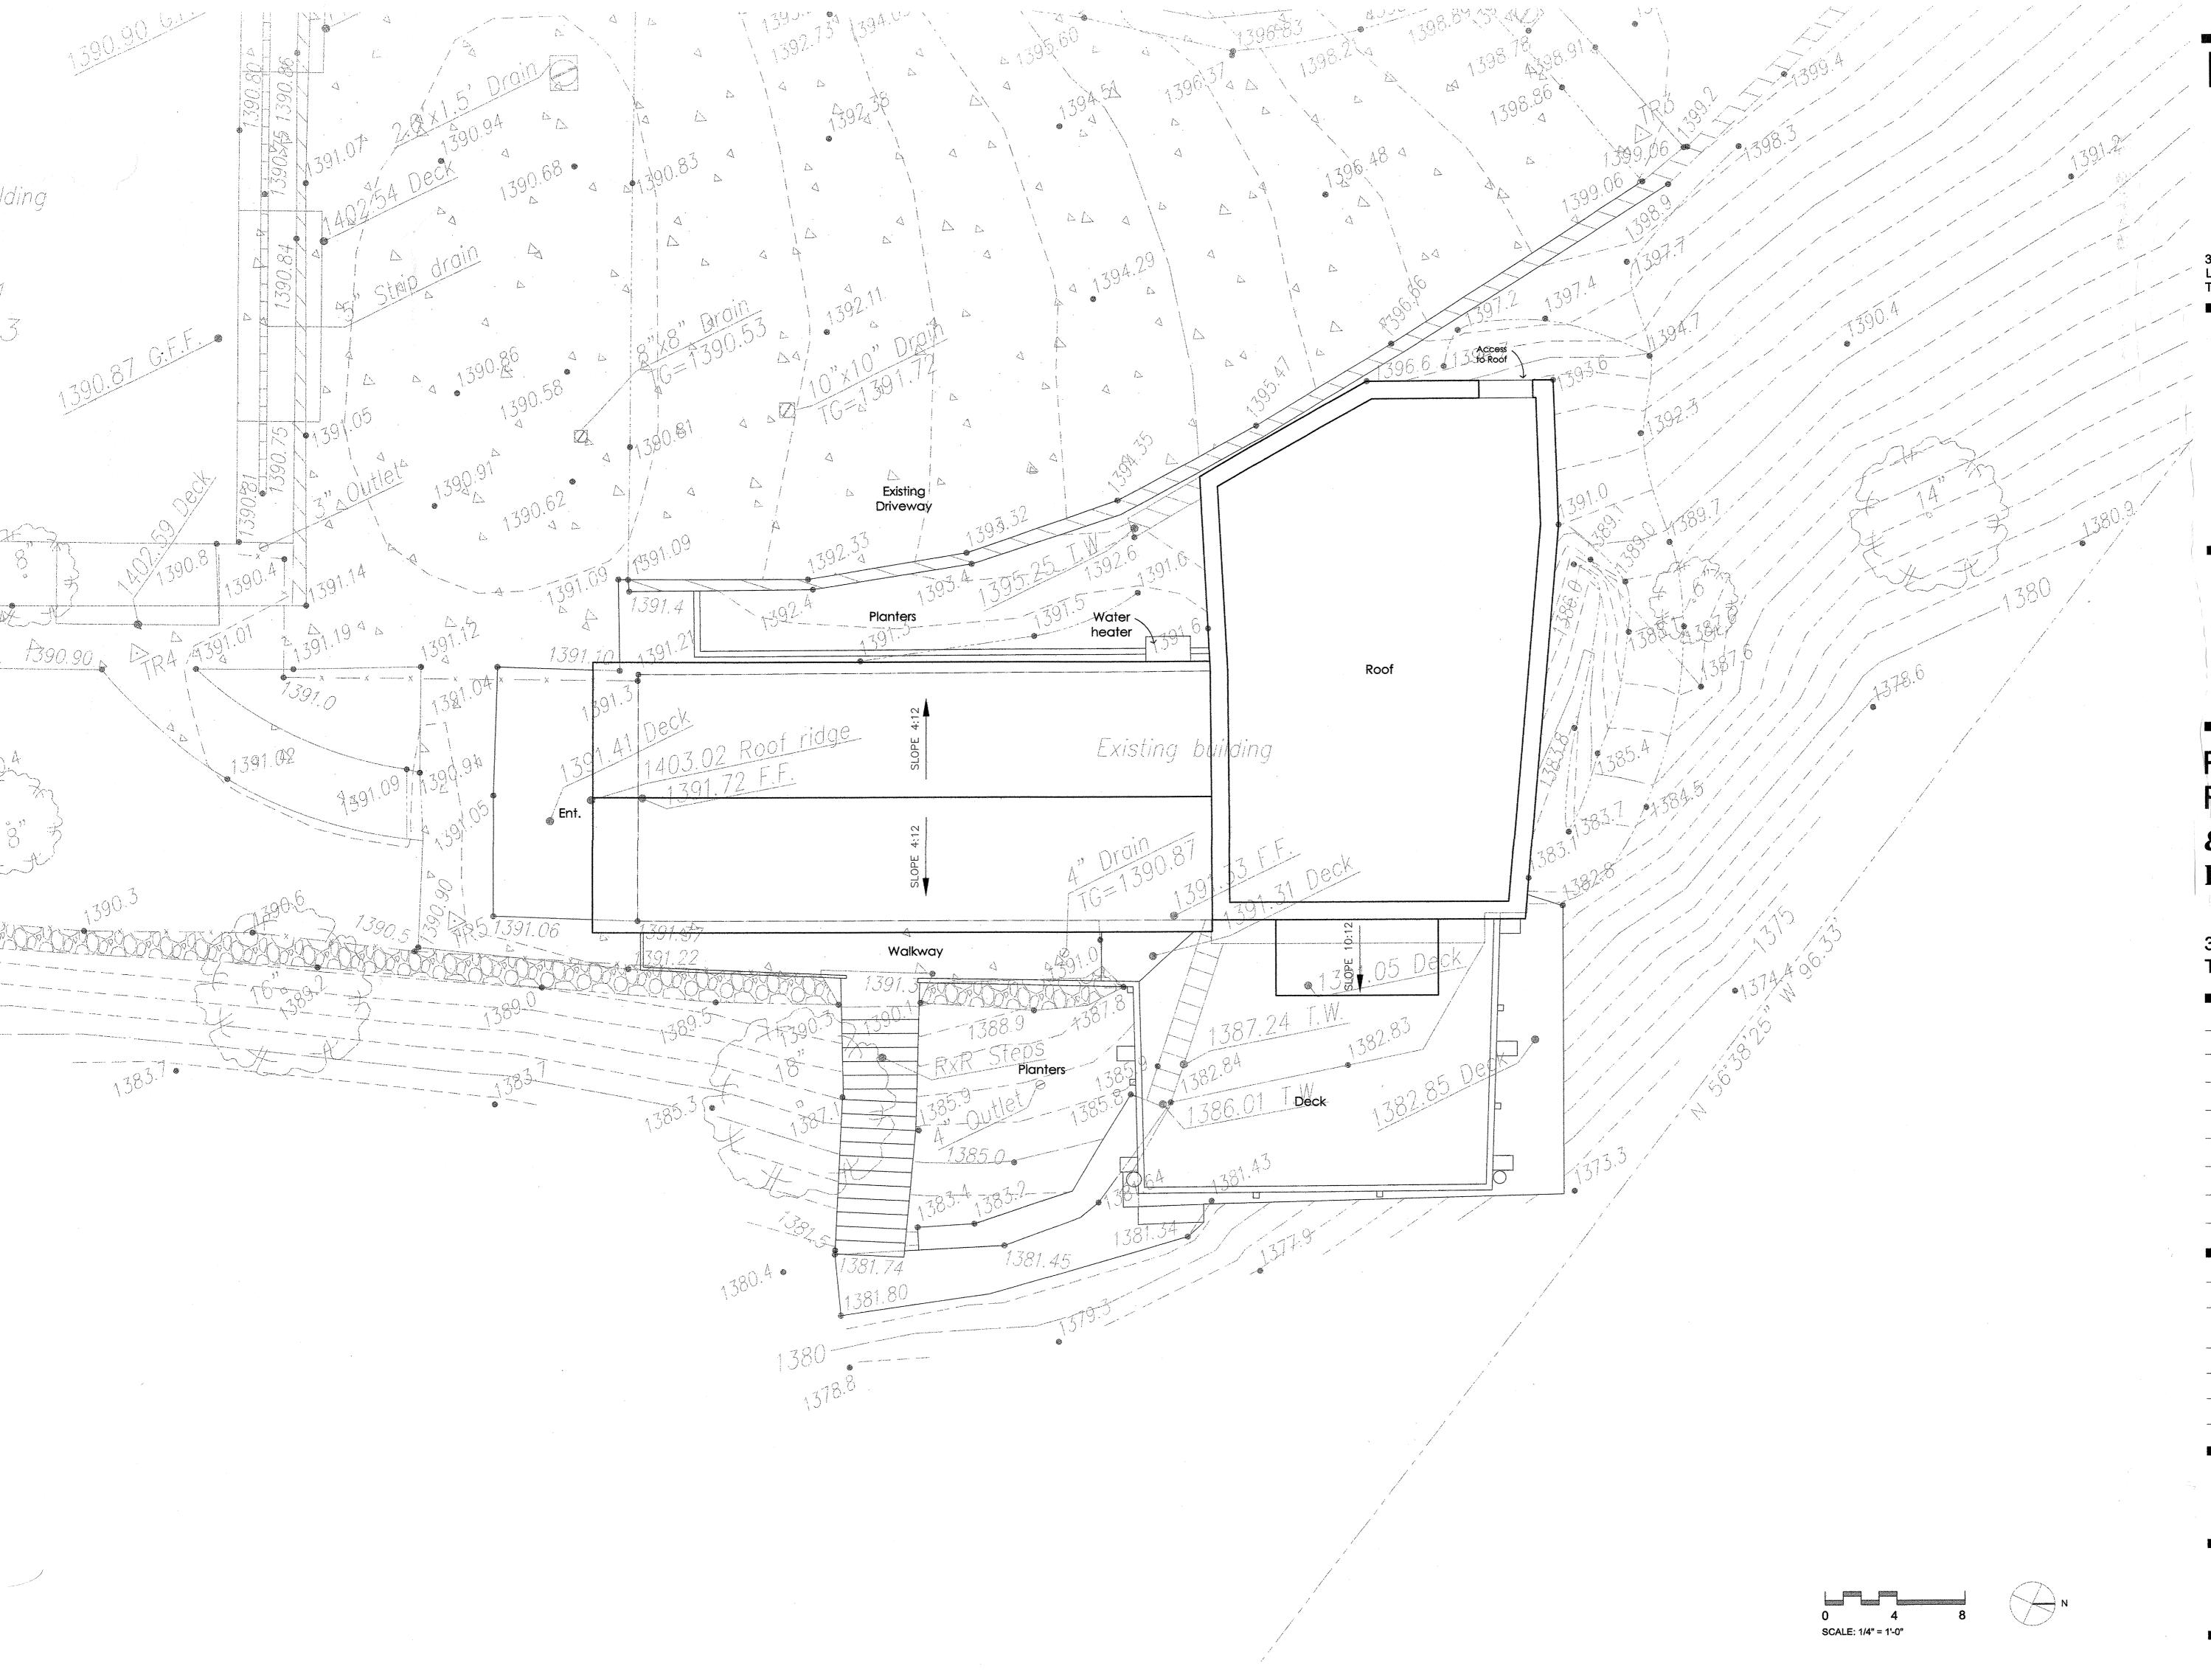

lohrbach studio

31742 SOUTH COAST HWY.
LAGUNA BEACH CA 92651
TEL 949.661 5068 FAX 949.715.9528

Seal / Signatu

Consultants:

REED RESIDENCE & ACCESSARY DWELLING UNIT

30122 Canyon Creek Dr. Trabuco Canyon, Ca 92679

Revisions:			
No.	Date	Revision	
$\overline{\triangle}$			
\triangle	•		
		ar Marian da da da parte de a desarbita da da de desarba da da de	

Date: 1 / 16 / 14

Job No.:

Association
Submittal:

Bidg. Dept. Submittal:

Bid Issue:

Construction Issue:


Sheet Title:

ROOF PLAN

Sheet No.:

A-5.1

EL 1992AS PICT PIN FIR. TIS. EL 1992AS PINT PIN FIR. EL 1992AS PIN FIR. EL 1992AS PINT PIN FIR. EL 1992AS PIN FIR. EL 1992AS PIN FIR. EL 199

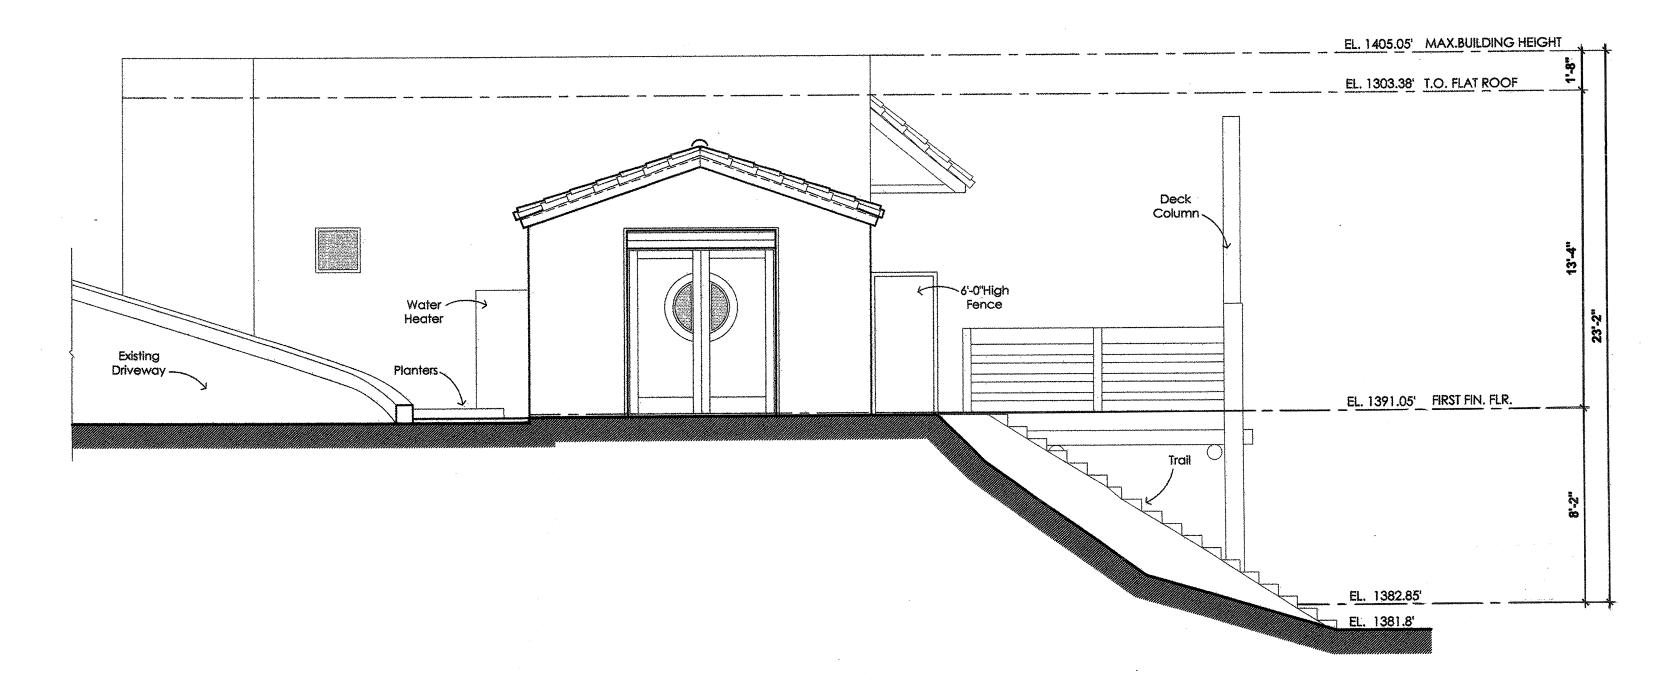

FRONT (SOUTH) ELEVATION

lohrbach studio

31742 SOUTH COAST HWY.

LAGUNA BEACH CA 92651

TEL 949.661 5068 FAX 949.715.9528

Seal / Signature:

Consultant

REED
RESIDENCE
& ACCESSARY
DWELLING UNIT

30122 Canyon Creek Dr. Trabuco Canyon, Ca 92679

Revisions:				
No.	Date	Revision		
$\overline{\triangle}$				
\triangle			***************************************	
$\overline{\triangle}$				Washington and the same of the
$\overline{\triangle}$				
$\overline{\triangle}$				
$\overline{\wedge}$			teren formularis de la companya en estado (en estado en el control de la constitución de la constitución de la	***************************************
		<u></u>	······································	

Date:	1/16/14
Job No.:	
Association	
Submittal:	
Bldg. Dept. Submittal:	
Bid Issue:	
Construction Issue:	

Sheet Title:


EXTERIOR ELEVATIONS

Sheet No.:


A-6.0

0 4 SCALE: 1/4" = 1'-0"

E. 190.29 T.O. PATROCI COPPE FENCO EL 191.22 FEL 191.25 EL 191.25 FEL 19

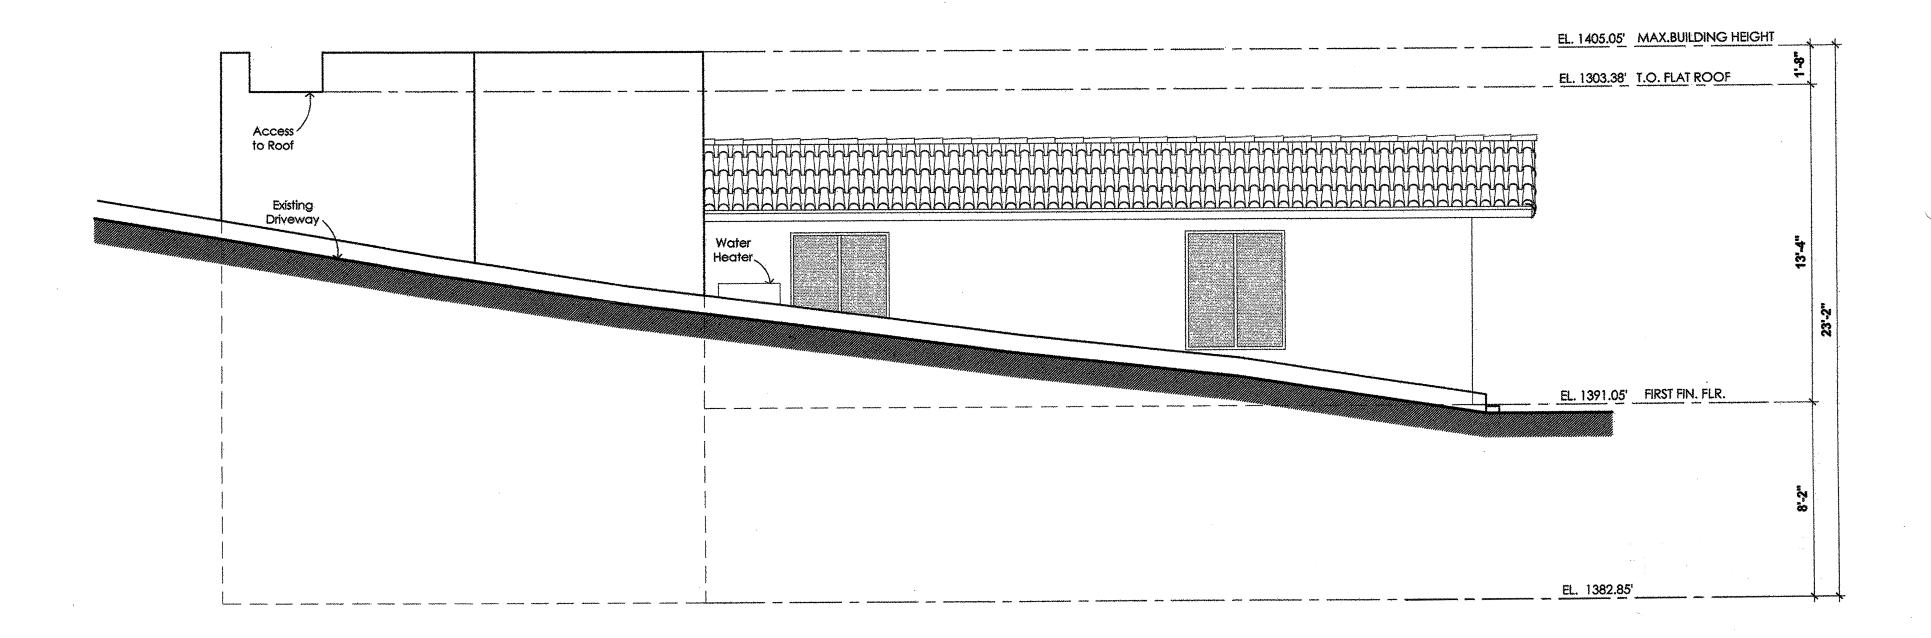

WEST ELEVATION

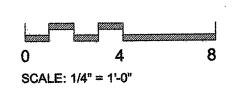

lohrbach studio

31742 SOUTH COAST HWY.
LAGUNA BEACH CA 92651
TEL 949.661 5068 FAX 949.715.9528

Seal / Signature:

Concultant

REED RESIDENCE & ACCESSARY DWELLING UNIT

30122 Canyon Creek Dr. Trabuco Canyon, Ca 92679

No. Da	Revision	
\triangle		* Managa ,
\triangle		
\triangle		
<u></u>		
\triangle		
\triangle		<u> </u>
Date:	1/	16 / 14
Job No.:		

Submittal:

Bid Issue:


Bldg. Dept. Submittal:

Construction Issue:

EXTERIOR ELEVATIONS

Sheet No.:

A-6.1

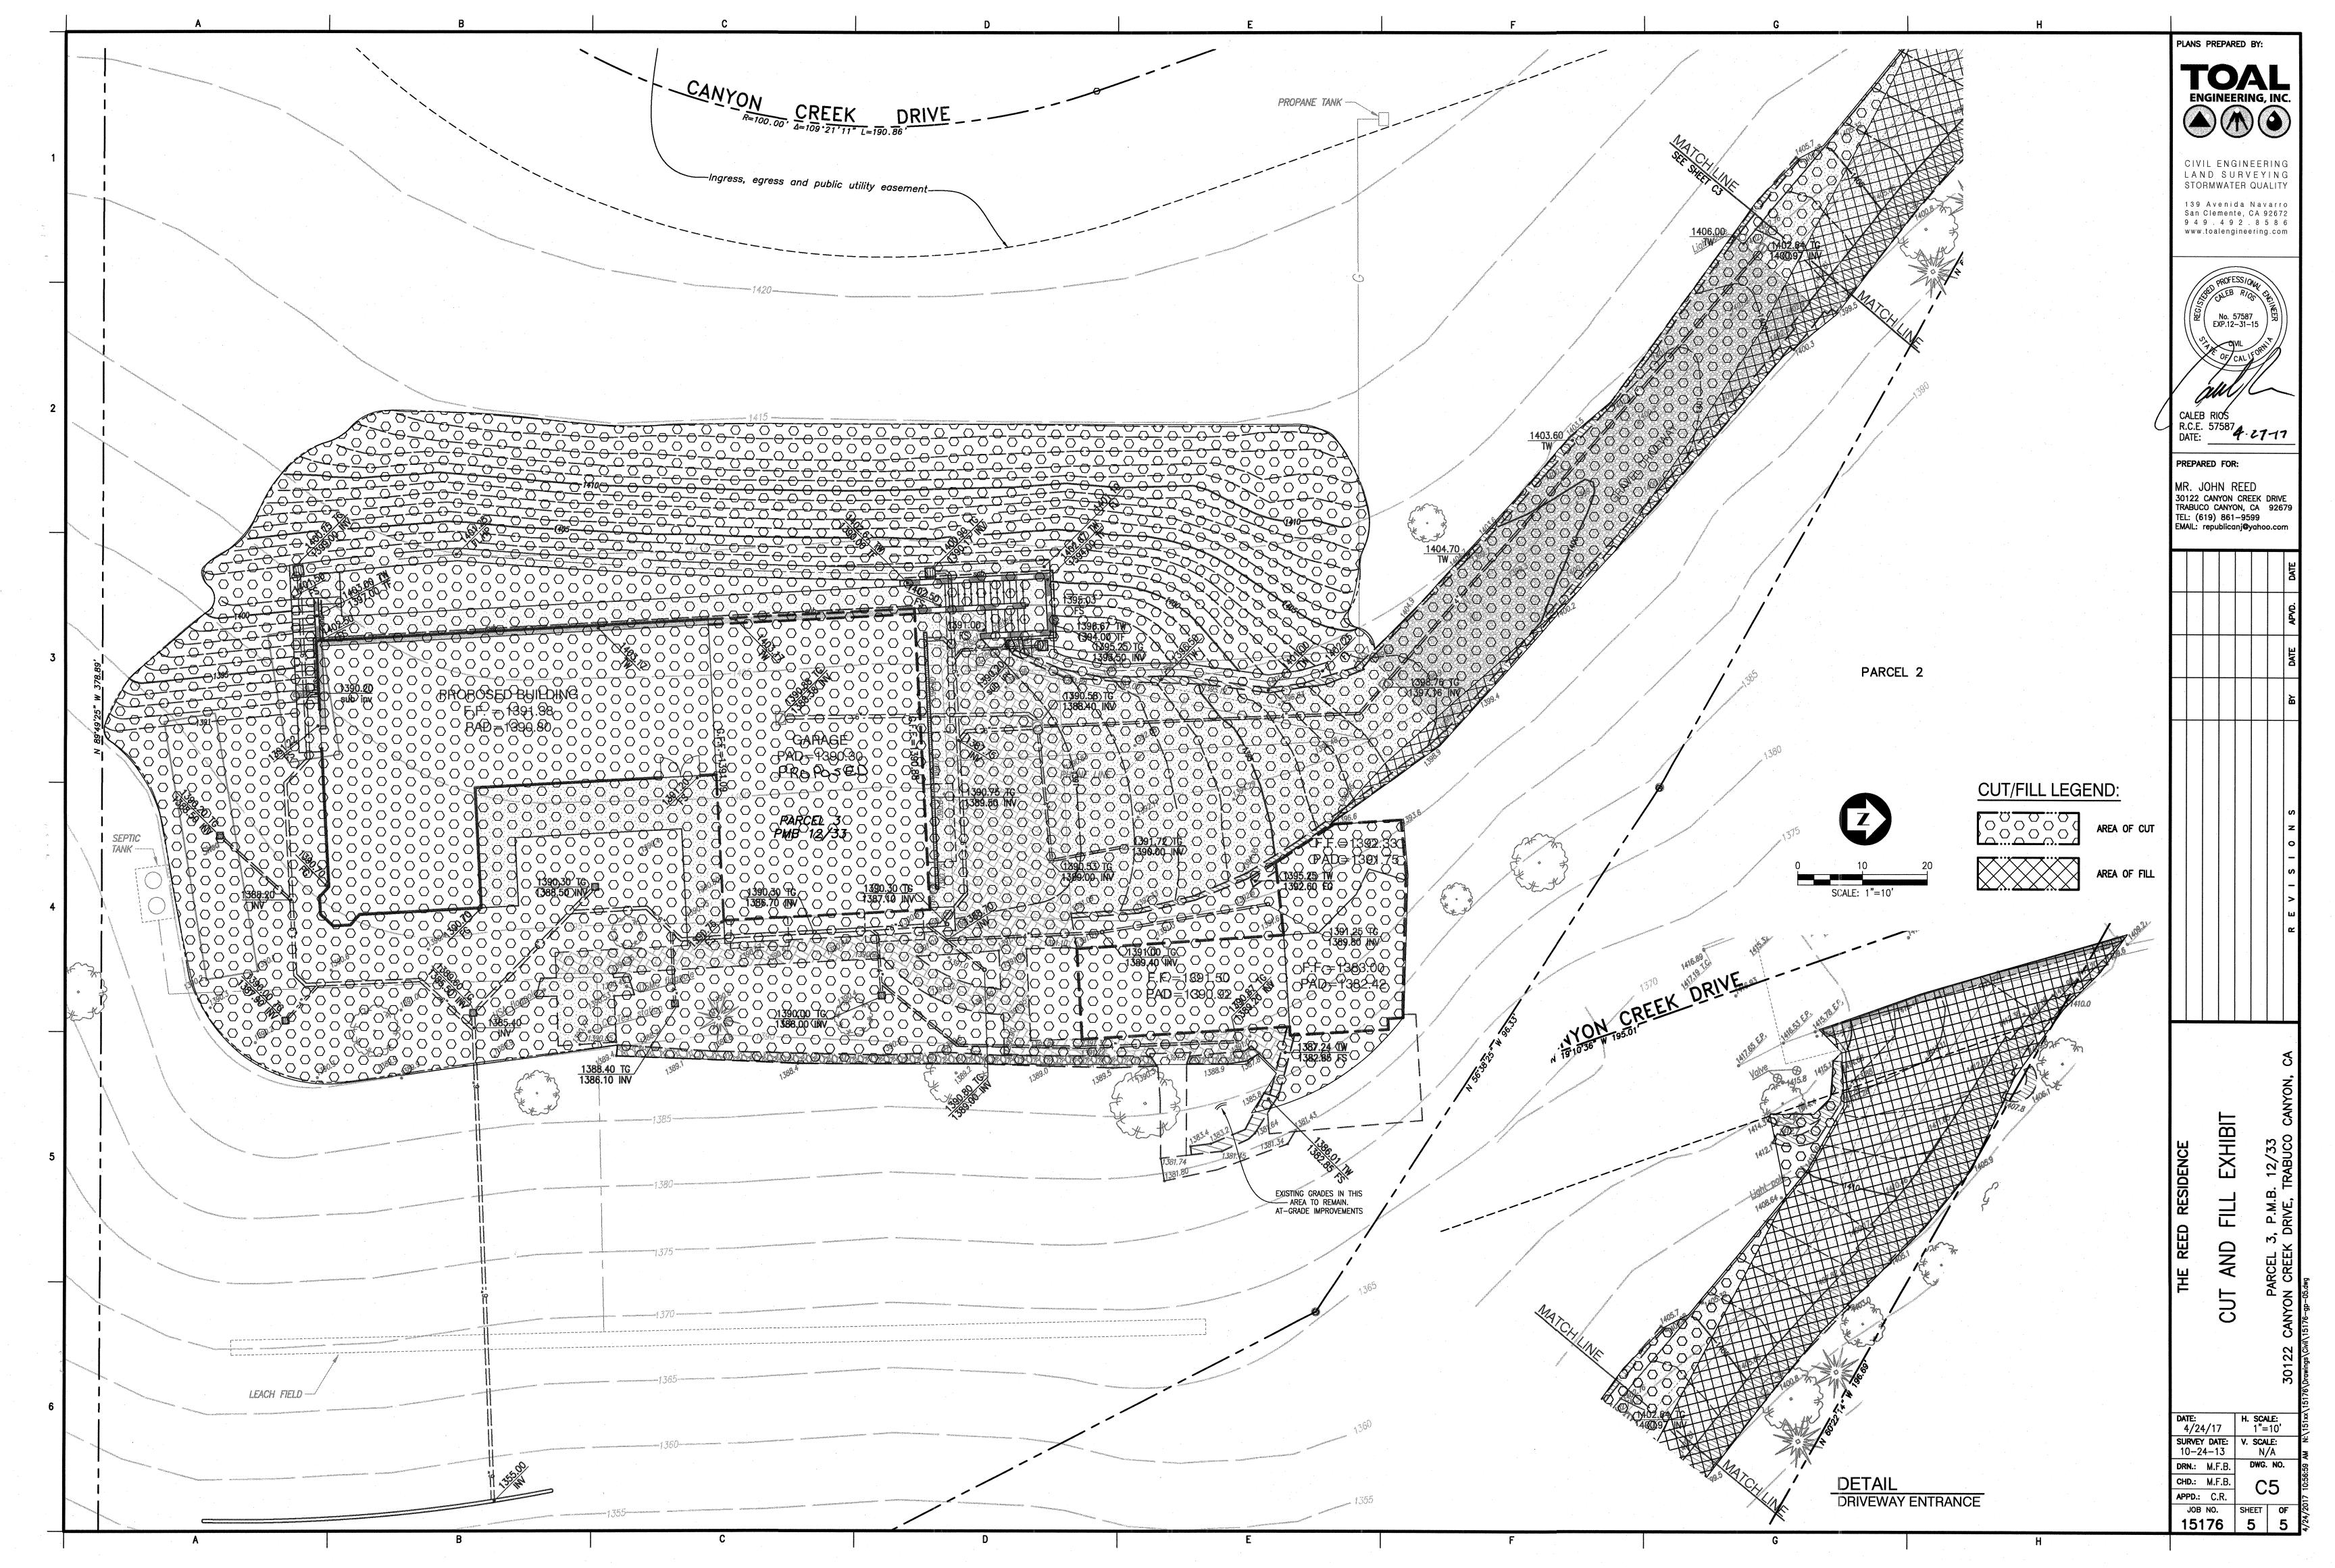

CONSTRUCTION CONTRACTOR AGREES THAT IN ACCORDANCE WITH GENERALLY ACCEPTED CONSTRUCTION PRACTICES, CONSTRUCTION CONTRACTOR WILL BE REQUIRED TO ASSUME SOLE AND COMPLETE RESPONSIBILITY FOR JOB SITE CONDITIONS DURING THE COURSE OF CONSTRUCTION OF THE PROJECT, INCLUDING SAFETY OF ALL PERSONS AND PROPERTY; THAT THIS REQUIREMENT SHALL BE MADE TO APPLY CONTINUOUSLY AND NOT BE LIMITED TO NORMAL WORKING HOURS, AND CONSTRUCTION CONTRACTOR FURTHER AGREES TO DEFEND. INDEMNIFY AND HOLD DESIGN PROFESSIONAL HARMLESS FROM ANY AND ALL LIABILITY, REAL OR ALLEGED, IN CONNECTION WITH THE PERFORMANCE OF WORK ON THIS PROJECT, EXCEPTING LIABILITY ARISING FROM THE SOLE NEGLIGENCE OF DESIGN PROFESSIONAL.

ALL EXISTING TOPOGRAPHY AND EXISTING GRADES SHOULD BE FIELD VERIFIED PRIOR TO CONSTRUCTION.

- THE EXISTENCE AND LOCATION OF ANY UNDERGROUND UTILITIES OR STRUCTURES SHOWN ON THESE PLANS ARE OBTAINED BY A SEARCH OF AVAILABLE RECORDS. TO THE BEST OF OUR KNOWLEDGE, THERE ARE NO EXISTING UTILITIES EXCEPT THOSE SHOWN ON THESE PLANS. THE CONTRACTOR IS REQUIRED TO TAKE ALL PRECAUTIONARY MEASURES TO PROTECT THE UTILITIES SHOWN, AND ANY OTHER LINES OR STRUCTURES NOT SHOWN ON THESE PLANS, AND IS RESPONSIBLE FOR THE PROTECTION OF. AND ANY DAMAGE TO, THESE LINES OR STRUCTURES. (ALL UTILITIES HAVE BEEN INSTALLED).
- EARTHWORK AND OTHER CONSTRUCTION ITEM QUANTITIES ARE ESTIMATES FOR AGENCY SUBMITTAL OF THIS PLAN AND ARE NOT TO BE USED FOR CONSTRUCTION COST ESTIMATES FOR BIDDING PURPOSES, CONTRACTOR(S) TO DEVELOP OWN QUANTITIES FOR
- A SOILS INVESTIGATION MUST BE MADE BY A QUALIFIED SOILS ENGINEER AND/OR GEOLOGIST. SOILS AND EARTH ACCEPTABILITY AE NOT UNDER THE PURVIEW OF THE RESPONSIBILITY OF DESIGN ENGINEER OF THIS PLAN. THE DESIGN ENGINEER DOES NOT TEST OR OBSERVE SOILS CONDITIONS PRIOR TO, DURING OR AFTER CONSTRUCTION AND HAS NO RESPONSIBILITY FOR SOILS
- IF THIS PROJECT IS STAKED BY SURVEY CREWS OTHER THAN THOSE CREWS UNDER THE DIRECT SUPERVISION OF THE SIGNATORY ENGINEER, THE SIGNATORY ENGINEER WILL NO LONGER BE THE ENGINEER OF RECORD AND WILL HAVE NO RESPONSIBILITY AS TO THE FINAL CONSTRUCTED PROJECT. THE SIGNATORY ENGINEER WILL NOT BE RESPONSIBLE FOR ERRORS OR OMISSIONS THAT COULD HAVE BEEN CORRECTED DURING THE CONSTRUCTION OF THIS PROJECT, IF THE STAKING HAD BEEN DONE BY SURVEY CREWS UNDER HIS DIRECT SUPERVISION.
- AN EASEMENT SEARCH WAS CONDUCTED FOR THIS PROJECT. THERE IS ONLY ONE ROAD EASEMENT AS NOTED ON THE TOPOGRAPHIC SURVEY.
- 8. ALL RETAINING WALL DESIGNS, T.W., T.F., STRUCTURAL, THICKNESS, SUBDRAINS, ETC. ARE TO BE BUILT PER STRUCTURAL ENGINEER, AND NOT BY INFORMATION SHOWN ON THIS PLAN. DESIGN OF RETAINING WALLS IS BY OTHERS, NOT TOAL
- ALL SURFACE DRAINAGE, INCLUDING SHEET, SWALE OR DRAINAGE PIPES WILL NEED TO BE MAINTAINED FOR THE LIFE OF THE PROJECT. IT IS UP TO THE OWNER OF THE PROPERTY TO PERIODICALLY INSPECT AND MAINTAIN THE DRAINAGE TO ASSURE THAT NO BLOCKAGE OCCURS. CARE SHOULD BE TAKEN SO AS TO NOT OVER WATER. THEREBY CAUSING SOILS SATURATION.

GRADING NOTES

- ALL WORK SHALL BE IN ACCORDANCE WITH THE GRADING CODE OF THE COUNTY OF ORANGE AND ANY SPECIAL REQUIREMENTS OF THE PERMIT. A COPY OF THE GRADING CODE AND MANUAL SHALL BE RETAINED ON THE JOB SITE WHILE WORK IS IN PROGRESS. WHEN REFERENCED ON THE PLANS, A COPY OF OCPW STANDARD PLANS SHALL BE
- GRADING SHALL NOT BE STARTED WITHOUT FIRST NOTIFYING THE DISTRICT GRADING INSPECTOR. A PRE-GRADING MEETING ON THE SITE IS REQUIRED BEFORE START OF GRADING WITH THE FOLLOWING PEOPLE PRESENT: OWNER, GRADING CONTRACTOR, DESIGN CIVIL ENGINEER, SOIL ENGINEER, ENGINEERING GEOLOGIST, DISTRICT GRADING INSPECTOR, AND WHEN REQUIRED, THE ARCHAEOLOGIST AND PALEONTOLOGIST. THE REQUIRED INSPECTIONS FOR GRADING WILL BE
- ISSUANCE OF A GRADING PERMIT DOES NOT ELIMINATE THE NEED FOR PERMITS FROM OTHER AGENCIES WITH REGULATORY RESPONSIBILITIES FOR CONSTRUCTION ACTIVITIES ASSOCIATED WITH THE WORK AUTHORIZED ON THIS PLAN. (GRADING PERMIT NOT REQUIRED).
- (4) THE GRADING PERMIT AND AN APPROVED COPY OF THE GRADING PLAN SHALL BE ON THE PERMITTED SITE WHILE WORK IS IN PROGRESS. (NOT REQUIRED).
- PRELIMINARY SOIL AND GEOLOGY REPORTS AND ALL SUBSEQUENT REPORTS AS APPROVED BY THE OC PLANNING, GRADING SECTION, ARE CONSIDERED A PART OF THE APPROVED GRADING PLAN. (NOT REQUIRED).
- THE SOIL ENGINEER AND THE ENGINEERING GEOLOGIST SHALL PERFORM SUFFICIENT INSPECTIONS AND BE AVAILABLE DURING GRADING AND CONSTRUCTION TO VERIFY COMPLIANCE WITH THE PLANS, SPECIFICATIONS AND THE CODE WITHIN
- THE CIVIL ENGINEER SHALL BE AVAILABLE DURING GRADING TO VERIFY COMPLIANCE WITH THE PLANS, SPECIFICATIONS, CODE AND ANY SPECIAL CONDITIONS OF THE PERMIT WITHIN THEIR PURVIEW. (NOT REQUIRED).
- THE ENGINEERING GEOLOGIST AND SOIL ENGINEER SHALL, AFTER CLEARING AND PRIOR TO THE PLACEMENT OF FILL IN CANYONS, INSPECT EACH CANYON FOR AREAS OF ADVERSE STABILITY AND TO DETERMINE THE PRESENCE OR ABSENCE OF SUBSURFACE WATER OR SPRING FLOW. IF NEEDED, SUBDRAINS WILL BE DESIGNED AND CONSTRUCTED PRIOR TO THE PLACEMENT OF FILL IN EACH RESPECTIVE CANYON. (NO FILL).
- SUBDRAIN OUTLETS SHALL BE COMPLETED AT THE BEGINNING OF THE SUBDRAIN CONSTRUCTION.
- THE EXACT LOCATION OF THE SUBDRAINS SHALL BE SURVEYED IN THE FIELD FOR LINE/GRADE AND SHOWN ON
- AREAS TO RECEIVE FILL SHALL BE PROPERLY PREPARED AND APPROVED IN WRITING BY THE SOILS ENGINEER AND THE BUILDING OFFICIAL PRIOR TO PLACING FILL. (NOT REQUIRED. NO FILL.)
- FILLS SHALL BE BENCHED INTO COMPETENT MATERIAL PER O.C.P.W. STANDARD PLAN NO. 1322. (N/A)
- ALL EXISTING FILLS SHALL BE APPROVED BY THE BUILDING OFFICIAL OR REMOVED PRIOR TO PLACING ADDITIONAL FILLS. (THERE ARE NO FILLS).
- FILLS SHALL BE COMPACTED THROUGHOUT TO A MINIMUM OF 90% RELATIVE DENSITY, AGGREGATE BASE FOR ASPHALTIC AREAS SHALL BE COMPACTED TO MINIMUM OF 95% RELATIVE DENSITY. MAXIMUM DENSITY SHALL BE DETERMINED BY UNIFORM BUILDING CODE STANDARD NO. 70-1 OR APPROVED EQUIVALENT, AND FIELD DENSITY BY UNIFORM BUILDING CODE STANDARD NO. 70-2 OR APPROVED EQUIVALENT. (N/A)
- CUT AND FILL SLOPES SHALL BE NO STEEPER THAN 2 FOOT HORIZONTAL TO 1 FOOT VERTICAL (2:1) EXCEPT WHERE SPECIFICALLY APPROVED OTHERWISE. (N/A)
- ALL CUT SLOPES SHALL BE INVESTIGATED BOTH DURING AND AFTER GRADING BY THE ENGINEERING GEOLOGIST TO DETERMINE IF ANY SLOPE STABILITY PROBLEM EXISTS. SHOULD EXCAVATION DISCLOSE ANY GEOLOGICAL HAZARDS OR POTENTIAL GEOLOGICAL HAZARDS, THE ENGINEERING GEOLOGIST SHALL SUBMIT RECOMMENDED TREATMENT TO THE BUILDING OFFICAL FOR APPROVAL. (N/A)
- WHERE SUPPORT OR BUTTRESSING OF CUT AND NATURAL SLOPE IS DETERMINED TO BE NECESSARY BY THE ENGINEERING GEOLOGIST AND SOIL ENGINEER, THE SOIL ENGINEER SHALL SUBMIT DESIGN, LOCATIONS AND CALCULATIONS TO THE BUILDING OFFICAL PRIOR TO CONSTRUCTION. THE ENGINEERING GEOLOGIST AND SOIL ENGINEER SHALL INSPECT AND PROVIDE RECOMMENDATIONS AS NECESSARY FOR THE CONSTRUCTION OF THE BUTTRESSING AND CERTIFY TO THE STABILITY OF SLOPE AND ADJACENT STRUCTURES UPON COMPLETION. (N/A)
- WHEN CUT PADS ARE BROUGHT NEAR GRADE, THE ENGINEERING GEOLOGIST SHALL DETERMINE IF THE BEDROCK IS EXTENSIVELY FRACTURED OR FAULTED AND WILL READILY TRANSMIT WATER. IF CONSIDERED NECESSARY BY THE ENGINEERING GEOLOGIST AND SOIL ENGINEER A COMPACTED FILL BLANKET WILL BE PLACED. (N/A)
- ALL TRENCH BACKFILLS SHALL BE TESTED AND APPROVED BY THE SOIL ENGINEER PER THE GRADING CODE. (N/A)
- ANY EXISTING IRRIGATION LINES AND CISTERNS SHALL BE REMOVED, OR CRUSHED IN PLACE, AND APPROVED BY THE BUILDING OFFICIAL AND SOIL ENGINEER. (N/A)
- ANY EXISTING WATER WELLS SHOULD BE ABANDONED IN COMPLIANCE WITH THE SPECIFICATIONS APPROVED BY ORANGE COUNTY, HEALTH CARE AGENCY, AND DIVISION OF ENVIRONMENTAL HEALTH. (N/A)
- ANY EXISTING CESSPOOLS AND SEPTIC TANKS SHALL BE ABANDONED IN COMPLIANCE WITH THE UNIFORM PLUMBING
- CODE TO THE APPROVAL OF OC PLANNING/BUILDING INSPECTION. (N/A)

STOCKPILING OF EXCESS MATERIAL SHALL BE APPROVED BY THE BUILDING OFFICAL PRIOR TO EXCAVATION.

- EXPORT SOIL MUST BE TRANSPORTED TO A LEGAL DUMP OR TO A PERMITTED SITE APPROVED BY THE DISTRICT
- THE PERMITTEE SHALL COMPLY WITH THE GRADING CODE REQUIREMENTS FOR HAUL ROUTES WHEN AN EXCESS OF 5,000 CUBIC YARDS OR EARTH IS TRANSPORTED TO OR FROM A PERMITTED SITE ON PUBLIC ROADWAYS. (N/A)
- THE PERMITTEE IS RESPONSIBLE FOR DUST CONTROL MEASURES.
- THE PERMITTEE SHALL GIVE REASONABLE NOTICE TO THE OWNER OF ADJOINING LANDS AND BUILDINGS PRIOR TO BEGINNING EXCAVATIONS WHICH MAY AFFECT THE LATERAL AND SUBJACENT SUPPORT OF THE ADJOINING PROPERTY. THE NOTICE SHALL STATE THE INTENDED DEPTH OF EXCAVATION AND WHEN THE EXCAVATION WILL COMMENCE. THE ADJOINING OWNER SHALL BE ALLOWED AT LEAST 30 DAYS AND REASONABLE ACCESS ON THE PERMITTED PROPERTY TO PROTECT HIS STRUCTURE, IF HE SO DESIRES, UNLESS OTHERWISE PROTECTED BY LAW.
- ALL CONCRETE STRUCTURES THAT COME IN CONTACT WITH THE ON-SITE SOILS SHALL BE CONSTRUCTED WITH TYPE V CEMENT, UNLESS DEEMED UNNECESSARY BY SOLUBLE SULPHATE-CONTENT TESTS CONDUCTED BY THE SOIL ENGINEER.

PRECISE GRADING PLAN

THE REED RESIDENCE & FAMILY GUEST HOUSE

30122 CANYON CREEK DRIVE (PARCEL 3, PMB 12/33) ORANGE COUNTY, CALIFORNIA

- SLOPES EXCEEDING 5 FEET IN HEIGHT SHALL BE PLANTED WITH AN APPROVED PLANT MATERIAL. IN ADDITION. SLOPES EXCEEDING 15 FEET IN HEIGHT SHALL BE PROVIDED WITH AN APPROVED IRRIGATION SYSTEM, UNLESS OTHERWISE APPROVED BY THE BUILDING OFFICIAL.
- ALL EXISTING DRAINAGE COURSES THROUGH THIS SITE SHALL REMAIN OPEN UNTIL FACILITIES TO HANDLE STORM WATER ARE APPROVED AND FUNCTIONAL; HOWEVER, IN ANY CASE, THE PERMITTEE SHALL BE HELD LIABLE FOR ANY DAMAGE DUE TO OBSTRUCTING NATURAL DRAINAGE PATTERNS.
- (31) SANITARY FACILITIES SHALL BE MAINTAINED ON THE SITE.
- THE LOCATION AND PROTECTION OF ALL UTILITIES IS THE RESPONSIBILITY OF THE PERMITTEE.
- APPROVED PROTECTIVE MEASURES AND TEMPORARY DRAINAGE PROVISIONS SHALL BE USED TO PROTECT ADJOINING PROPERTIES DURING GRADING. (N/A)
- GRADING OPERATIONS INCLUDING MAINTENANCE OF EQUIPMENT WITHIN ONE—HALF MILE OF A HUMAN OCCUPANCY SHALL NOT BE CONDUCTED BETWEEN THE HOURS OF 8:00 P.M. AND 7:00 A.M. DAILY, ON SUNDAY OR ON A FEDERAL HOLIDAY.
 - (A) ALL CONSTRUCTION VEHICLES OR EQUIPMENT, FIXED OR MOBILE, OPERATED WITHIN 1,000' OR A
 - DWELLING SHALL BE EQUIPPED WITH PROPERLY OPERATING AND MAINTAINED MUFFLERS. (B) ALL OPERATIONS SHALL COMPLY WITH ORANGE COUNTY CODIFIED ORDINANCE DIVISION 6 (NIIISE
- (C) STOCKPILING AND/OR VEHICLE STAGING AREAS SHALL BE LOCATED AS FAR AS PRACTICABLE FROM DWELLINGS AND WITHIN THE LIMITS OR GRADING PERMIT.
- GRADING AND EXCAVATION SHALL BE HALTED DURING PERIODS OF HIGH WINDS. ACCORDING TO AQMD MEASURES F-4, HIGH WINDS ARE DEFINED AS 30 MPH OR GREATER. THIS LEVEL OCCURS ONLY UNDER UNUSUALLY EXTREME CONDITIONS, SUCH AS SANTA ANA WIND CONDITIONS.
- ASPHALT SECTIONS MUST BE PER CODE: PARKING STALLS = 3" A/C OVER 6" A/B, DRIVES 3: A/C OVER 10" (COMM) 12" (INDUSTRIAL). OR: PRIOR TO ROUGH GRADE RELEASE FOR BUILDING PERMITS BY THE DISTRICT GRADING INSPECTOR. THE SOIL ENGINEER SHALL SUBMIT FOR APPROVAL, PAVEMENT SECTION RECOMMENDATIONS BASED ON "R" VALUE ANALYSIS OF THE SUBGRADE SOILS, AND EXPECTED TRAFFIC INDICES. (N/A)
- ASPHALT CONCRETE SHALL BE CONSTRUCTED PER THE REQUIREMENTS OF OCPW STANDARD PLAN
- AGGREGATE BASE SECTION SHALL BE CONSTRUCTED PER OCPW STANDARD PLAN 1804.
- ROOF GUTTERS SHALL BE INSTALLED TO PREVENT ROOF DRAINAGE FROM FALLING ON MANUFACTURED
- THE CIVIL ENGINEER, AS A CONDITION OF ROUGH GRADE APPROVAL, SHALL PROVIDE A BLUE TOP WITH ACCOMPANYING WITNESS STAKE, SET AT THE CENTER OF EACH PAD REFLECTING THE PAD ELEVATION FOR PRECISE PERMITS AND A BLUE TOP WITH WITNESS STAKE SET AT THE DRAINAGE SWALE HIGH POINT REFLECTING THE HIGH POINT ELEVATION FOR PRELIMINARY PERMITS. (N/A)
- PRIOR TO FINAL APPROVAL, THE CMIL ENGINEER SHALL CERTIFY TO THE BUILDING OFFICIAL THE AMOUNT OF EARTH MOVED DURING THE GRADING OPERATION. (N/A)
- THE ENGINEERING GEOLOGIST SHALL PERFORM PERIODIC INSPECTIONS AND SUBMIT A COMPLETE REPORT AND MAP UPON COMPLETION OF THE ROUGH GRADING. (N/A)
- THE GRADING CONTRACTOR SHALL SUBMIT A STATEMENT OF COMPLIANCE TO THE APPROVED GRADING PLAN PRIOR TO FINAL APPROVAL. (N/A)
- THE COMPACTION REPORT AND APPROVAL FROM THE SOIL ENGINEER SHALL INDICATE THE TYPE OF FIELD TESTING PERFORMED. THE METHOD OF OBTAINING THE IN-PLACE DENSITY SHALL BE IDENTIFIED WHETHER SAND CONE, DRIVE RING, OR NUCLEAR, AND SHALL BE NOTED FOR EACH TEST. SUFFICIENT MAXIMUM DENSITY DETERMINATIONS SHALL BE PERFORMED TO VERIFY THE ACCURACY OF THE MAXIMUM DENSITY CURVES USED BY THE FIELD TECHNICIAN. (N/A)
- IN THE EVENT THAT SOIL CONTAMINATION IS DISCOVERED DURING EXCAVATION AND REMOVAL OF AN EXISTING TANK, WORK SHALL BE STOPPED UNTIL A SITE ASSESSMENT AND MITIGATION PLAN HAS BEEN PREPARED, SUBMITTED AND APPROVED BY HCA/ENVIRONMENTAL HEALTH AND OC PLANNING/GRADING.

EROSION CONTROL NOTES

NOT WORK ON GRADING DURING RAINY SEASON).

(46) IN CASE OF EMERGENCY CALL: JOHN REED (619) 861-9599 (949) 888-8069

- (47) EQUIPMENT AND WORKERS FOR EMERGENCY WORK SHALL BE MADE AVAILABLE AT ALL TIMES DURING THE RAINY SEASON. NECESSARY MATERIALS SHALL BE AVAILABLE ON SITE AND STOCKPILED AT CONVENIENT LOCATIONS TO FACILITATE RAPID CONSTRUCTION OF TEMPORARY DEVICES WHEN RAIN IS IMMINENT. (WILL
- (48) EROSION CONTROL DEVICES SHALL NOT BE MOVED OR MODIFIED WITHOUT THE APPROVAL OF THE BUILDING OFFICAL.
- (49) ALL REMOVABLE EROSION PROTECTIVE DEVICES SHALL BE IN PLACE AT THE END OF EACH WORKING DAY WHEN THE 5-DAY RAIN PROBABILITY FORECAST EXCEEDS 40%.
- (50) AFTER A RAINSTORM ALL SILT AND DEBRIS SHALL BE REMOVED FROM STREETS, CHECK BERMS & BASINS.
- (51) GRADED AREAS ON THE PERMITTED AREA PERIMETER MUST DRAIN AWAY FROM THE FACE OF SLOPES AT THE CONCLUSION OF EACH WORKING DAY. DRAINAGE TO BE DIRECTED TOWARD DESILTING FACILITIES.
- (52) THE PERMITTEE AND CONTRACTOR SHALL BE RESPONSIBLE AND SHALL TAKE NECESSARY PRECAUTIONS TO

PREVENT PUBLIC TRESPASS ONTO AREAS WHERE IMPOUNDED WATER CREATES A HAZARDOUS CONDITION.

(53) THE PERMITTEE AND CONTRACTOR SHALL INSPECT THE EROSION CONTROL WORK AND INSURE THAT THE WORK IS IN ACCORDANCE WITH THE APPROVED PLANS.

ENVIRONMENTAL NOTES

- (54) THE PERMITTEE SHALL NOTIFY ALL GENERAL CONTRACTORS, SUBCONTRACTORS, MATERIAL SUPPLIERS. LESSEESS, AND PROPERTY OWNERS THAT DUMPING OF CHEMICALS INTO THE STORM DRAIN SYSTEM OR THE WATERSHED IS PROHIBITED.
- (55) PERMITTEE SHALL MAINTAIN CONSTRUCTION SITE IN SUCH A CONDITION THAT AN ANTICIPATED STORM DOES NOT CARRY WASTES OR POLLUTANTS OFF THE SITE. POTENTIAL POLLUTANTS INCLUDE BUT ARE NOT LIMITED TO: SOLID OR LIQUID CHEMICAL SPILLS; WASTES FROM PAINTS, STAINS, SEALANTS, GLUES, LIMES, PESTICIDES, HERBICIDES, WOOD PRESERVATIVES AND SOLVENTS; ASBESTOS FIBERS, PAINTS FLAKES OR STUCCO FRAGMENTS; FUELS, OILS, LUBRICANTS, AND HYDRAULIC, RADIATOR, OR BATTERY FLUIDS; FERTILIZERS. VEHICLE/EQUIPMENT WASH WATER AND CONCRETE WASH WATER; CONCRETE, DETERGENT OR FLOATABLE WATES: WASTES FROM ANY ENGINE/EQUIPMENT STEAM CLEANING OR CHEMICAL DEGREASING: AND SUPERCHLORINATED POTABLE WATER LINE FLUSHINGS. DURING CONSTRUCTION, PERMITTEE SHALL DISPOSE OF SUCH MATERIALS IN A SPECIFIED AND CONTROLLED TEMPORARY AREA ON-SITE. PHYSICALLY SEPARATED FROM POTENTIAL STORMWATER RUNOFF, WITH ULTIMATE DISPOSAL IN ACCORDANCE WITH LOCAL, STATE, AND FEDERAL REQUIREMENTS.
- (56) PERMITTEE MAY DISCHARGE MATERIAL OTHER THAN STORMWATER ONLY WHEN NECESSARY FOR PERFORMANCE AND COMPLETION OF CONSTRUCTION PRACTICES AND WHERE THEY DO NOT: CAUSE OR CONTRIBUTE TO A VIOLATION OF ANY WATER QUALITY STANDARD; CAUSE OR THREATEN TO TO CAUSE POLLUTION, CONTAMINATION, OR NUISANCE; OR CONTAIN A HAZARDOUS SUBSTANCE IN A QUANTITY REPORTABLE UNDER FEDERAL REGULATIONS 40 CFR PARTS 117 AND 302.

ENVIRONMENTAL NOTES (cont.)

- (57) DEWATERING OF CONTAMINATED GROUNDWATER, OR DISCHARGING CONTAMINATED SOILS VIA SURFACE EROSION IS PROHIBITED. DEWATERING OF NON-CONTAMINATED GROUNDWATER REQUIRES A NATIONAL POLLUTANT DISCHARGE ELIMINATION SYSTEM PERMIT FROM THE RESPECTIVE STATE REGIONAL WATER QUALITY CONTROL BOARD.
- (58) SPECIAL NOTE: SURVEY MONUMENTS SHALL BE PRESERVED AND REFERENCED BEFORE CONSTRUCTION AND REPLACED AFTER CONSTRUCTION PURSUANT TO SECTION 8771 OF THE BUSINESS AND PROFESSIONS CODE.
- (59) THIS LOT WAS GRADED IN THE 1960'S. IT WAS USED AS A BORROW PIT TO PROVIDE FILL FOR THE CONSTRUCTION OF CANYON CREEK ROAD. CONSEQUENTLY, THE HOUSE BEING BUILT WILL WEIGH LESS THAN THE MATERIAL REMOVED TO BUILD CANYON CREEK ROAD. THIS WILL PRECLUDE LONG-TERM SETTLEMENT OF THE STRUCTURE.

NATIONAL POLLUTION DISCHARGE ELIMINATION SYSTEM (NPDES) NOTES:

- 1. IN THE CASE OF EMERGENCY, CALL JOHN REED AT TELEPHONE # (619) 861-9599
- 2. SEDIMENT FROM AREAS DISTURBED BY CONSTRUCTION SHALL BE RETAINED ON SITE USING STRUCTURAL CONTROLS TO THE MAXIMUM
- 3. STOCKPILES OF SOIL SHALL BE PROPERLY CONTAINED TO MINIMIZE SEDIMENT TRANSPORT FROM THE SITE TO STREETS, DRAINAGE FACILITIES OR ADJACENT PROPERTIES VIA RUNOFF, VEHICLE TACKING, OR WIND.
- APPROPRIATE BMP'S FOR CONSTRUCTION-RELATED MATERIALS, WASTES, AND SPILLS SHALL BE IMPLEMENTED TO MINIMIZE TRANSPORT FROM
- THE SITE TO STREETS. DRAINAGE FACILITIES. OR ADJOINING PROPERTIES BY WIND OR RUNOFF.
- RUNOFF FROM EQUIPMENT AND VEHICLE WASHING SHALL BE CONTAINED AT CONSTRUCTION SITES UNLESS TREATED TO REDUCE OR REMOVE SEDIMENT AND OTHER POLLUTANTS.
- ALL CONSTRUCTION CONTRACTOR AND SUBCONTRACTOR PERSONNEL ARE TO BE MADE AWARE OF THE REQUIRED BEST MANAGEMENT
- PRACTICES AND GOOD HOUSEKEEPING MEASURES FOR THE PROJECT SITE AND ANY ASSOCIATED CONSTRUCTION STAGING AREAS.
- 7. AT THE END OF EACH DAY OF CONSTRUCTION ACTIVITY ALL CONSTRUCTION DEBRIS AND WASTE MATERIALS SHALL BE COLLECTED AND PROPERLY DISPOSED IN TRASH OR RECYCLE BINS.
- 8. CONSTRUCTION SITES SHALL BE MAINTAINED IN SUCH A CONDITION THAT AN ANTICIPATED STORM DOES NOT CARRY WASTES OR POLLUTANTS OFF THE SITE. DISCHARGES OF MATERIAL OTHER THAN STORMWATER ONLY WHEN NECESSARY FOR PERFORMANCE AND COMPLETION OF CONSTRUCTION PRACTICES AND WHERE THEY DO NOT: CAUSE OR CONTRIBUTE TO A VIOLATION OF ANY WATER QUALITY STANDARD; CAUSE OR THREATEN TO CAUSE POLLUTION, CONTAMINATION, OR NUISANCE; OR CONTAIN A HAZARDOUS SUBSTANCE IN A QUANTITY REPORTABLE UNDER FEDERAL REGULATIONS 40 CFR PARTS 117 & 302.
- POTENTIAL POLLUTANTS INCLUDE BUT ARE NOT LIMITED TO: SOLID OR LIQUID CHEMICAL SPILLS: WASTES FROM PAINTS, STAINS, SEALANTS, GLUES. LIMES, PESTICIDES, HERBICIDES, WOOD PRESERVATIVES AND SOLVENTS; ASBESTOS FIBERS, PAINT FLAKES OR STUCCO FRAGMENTS; FUELS, OILS, LUBRICANTS, AND HYDRAULIC, RADIATOR OR BATTERY FLUIDS; FERTILIZERS, VEHICLES/EQUIPMENT WASH WATER AND CONCRETE WASH WATER; CONCRETE, DETERGENT OR FLOATABLE WASTES; WASTES FROM ANY ENGINE/EQUIPMENT STEAM CLEANING OR CHEMICAL DEGREASING: AND SUPER-CHLORINATED POTABLE WATER LINE FLUSHING.
- PHYSICALLY SEPARATED FROM POTENTIAL STORM WATER RUNOFF, WITH ULTIMATE DISPOSAL IN ACCORDANCE WITH LOCAL, STATE AND FEDERAL REQUIREMENTS. 10. DEWATERING OF CONTAMINATED GROUNDWATER, OR DISCHARGING CONTAMINATED SOILS VIA SURFACE EROSION IS PROHIBITED. DEWATERING

DURING CONSTRUCTION, PERMITTEE SHALL DISPOSE OF SUCH MATERIALS IN A SPECIFIED AND CONTROLLED TEMPORARY AREA ON SITE.

- OF NON-CONTAMINATED GROUNDWATER REQUIRES A NATIONAL POLLUTANT DISCHARGE ELIMINATION SYSTEM PERMIT FROM THE RESPECTIVE STATE REGIONAL WATER QUALITY CONTROL BOARD.
- GRADED AREAS ON THE PERMITTED AREA PERIMETER MUST DRAIN AWAY FROM THE FACE OF SLOPES AT THE CONCLUSION OF EACH working day. Drainage is to be directed toward desilting facilities.
- 12. THE PERMITTEE AND CONTRACTOR SHALL BE RESPONSIBLE AND TAKE NECESSARY PRECAUTIONS TO PREVENT PUBLIC TRESPASS ONTO AREAS WHERE IMPOUNDED WATER CREATES A HAZARDOUS CONDITION.
- 13. THE PERMITTEE AND CONTRACTOR SHALL INSPECT THE EROSION CONTROL WORK AND INSURE THAT THE WORK IS IN ACCORDANCE WITH
- 14. THE PERMITTEE SHALL NOTIFY ALL GENERAL CONTRACTORS, SUBCONTRACTORS, MATERIAL SUPPLIERS, LESSEES, AND PROPERTY OWNERS: THAT DUMPING OF CHEMICALS INTO THE STORM DRAIN SYSTEM OR THE WATERSHED IS PROHIBITED
- 15. EQUIPMENT AND WORKERS FOR EMERGENCY WORK SHALL BE MADE AVAILABLE AT ALL TIMES DURING THE RAINY SEASON. NECESSARY MATERIALS SHALL BE AVAILABLE ON SITE AND STOCKPILED AT CONVENIENT LOCATIONS TO FACILITATE RAPID CONSTRUCTION OF TEMPORARY DEVICES WHEN RAIN IS IMMINENT.
- 16. ALL REMOVABLE EROSION PROTECTIVE DEVICES SHALL BE IN PLACE AT THE END OF EACH WORKING DAY WHEN THE 5-DAY RAIN
- 17. SEDIMENTS FROM AREAS DISTURBED BY CONSTRUCTION SHALL BE RETAINED ON SITE USING AN EFFECTIVE COMBINATION OF EROSION AND SEDIMENT CONTROLS TO THE MAXIMUM EXTENT PRACTICABLE, AND STOCKPILES OF SOIL SHALL BE PROPERLY CONTAINED TO MINIMIZE sediment transport from the site to the streets, drainage facilities of adjacent properties via runoff, vehicle tracking,
- 18. APPROPRIATE BMPS FOR CONSTRUCTION—RELATED MATERIALS, WASTES, SPILLS OR RESIDUES SHALL BE IMPLEMENTED AND RETAINED ON SITE TO MINIMIZE TRANSPORT FROM THE SITE TO STREETS, DRAINAGE FACILITIES, OR ADJOINING PROPERTY BY WIND OR RUNOFF.

CALIFORNIA CIVIL CODE (SECTION 832)

LATERAL AND SUBJACENT SUPPORT; EXCAVATION; DEGREE OF CARE; DAMAGES; PROTECTION OF OTHER STRUCTURES.

EACH COTERMINOUS OWNER IS ENTITLED TO THE LATERAL AND SUBJACENT SUPPORT WHICH HIS LAND RECEIVES FROM THE ADJOINING LAND, SUBJECT TO THE RIGHT OF THE OWNER OF THE ADJOINING LAND TO MAKE PROPER AND USUAL EXCAVATIONS ON THE SAME FOR PURPOSES OF CONSTRUCTION OR IMPROVEMENT, UNDER THE FOLLOWING CONDITIONS:

- 1. ANY OWNER OF LAND OR HIS LESSEE INTENDING TO MAKE OR TO PERMIT AN EXCAVATION SHALL GIVE REASONABLE NOTICE TO THE OWNER OR OWNERS OF ADJOINING LANDS AND OF BUILDINGS OR OTHER STRUCTURES, STATING THE DEPTH TO WHICH SUCH EXCAVATION IS INTENDED TO BE MADE, AND WHEN THE EXCAVATING WILL BEGIN.
- 2. IN MAKING ANY EXCAVATION, ORDINARY CARE AND SKILL SHALL BE USED, AND REASONABLE PRECAUTIONS TAKEN TO SUSTAIN THE ADJOINING LAND AS SUCH. WITHOUT REGARD TO ANY BUILDING OR OTHER STRUCTURE WHICH MAY BE THEREON, AND THERE SHALL BE NO LIABILITY FOR DAMAGE DONE TO ANY SUCH BUILDING OR OTHER STRUCTURE BY REASON OF THE EXCAVATION, EXCEPT AS OTHERWISE PROVIDED OR ALLOWED BY LAW.
- 3. IF AT ANY TIME IT APPEARS THE EXCAVATION IS TO BE OF A GREATER DEPTH THAN ARE THE WALLS OR FOUNDATIONS OF ANY ADJOINING BUILDING OR OTHER STRUCTURE AND IS TO BE SO CLOSE AS TO ENDANGER THE BUILDING OR OTHER STRUCTURE IN ANY WAY, THEN THE OWNER OF THE BUILDING OR OTHER STRUCTURE MUST BE ALLOWED AT LEAST 30 DAYS IF HE SO DESIRES, IN WHICH TO TAKE MEASURES TO PROTECT THE SAME FROM ANY DAMAGE. OR IN WHICH TO EXTEND THE FOUNDATIONS THEREOF, AND HE MUST BE GIVEN FOR THE SAME PURPOSE REASONABLE LICENSE TO ENTER ON THE LAND ON WHICH THE EXCAVATION IS TO BE OR IS BEING MADE.
- 4. IF THE EXCAVATION IS INTENDED TO BE OR IS DEEPER THAN THE STANDARD DEPTH OF FOUNDATIONS. WHICH DEPTH IS DEFINED TO BE A DEPTH OF *** NINE FEET BELOW THE ADJACENT CURB LEVEL. AT THE POINT WHERE THE JOINT PROPERTY LINE INTERSECTS THE CURB AND IF ON THE LAND OF THE COTERMINOUS OWNER THERE IS ANY BUILDING OR OTHER STRUCTURE THE WALL OR FOUNDATION OF WHICH GOES TO STANDARD DEPTH OR DEEPER THAN THE OWNER OF THE LAND ON WHICH THE EXCAVATION IS BEING MADE SHALL, IF GIVEN THE NECESSARY LICENSE TO ENTER THE ADJOINING LAND, PROTECT THE SAID ADJOINING LAND ANY SUCH BUILDING OR OTHER STRUCTURE THEREON WITHOUT COST TO THE OWNER THEREOF, FROM ANY DAMAGE BY REASON OF THE EXCAVATION. AND SHALL BE LIABLE TO THE OWNER OF SUCH PROPERTY FOR ANY SUCH DAMAGE, EXCEPTING ONLY FOR MINOR SETTLEMENT CRACKS IN BUILDINGS OR OTHER

RETAINING WALLS ARE SHOWN FOR INFORMATION ONLY, AND ARE TO BE INSPECTED BY OTHERS UNDER A SEPARATE PERMIT.



GOVERNMENT CODE REQUIRES A DIGALERT IDENTIFICATION NUMBER BE ISSUED BEFORE A "PERMIT TO EXCAVATE" WILL BE VALID. FOR YOUR DIGALERT I.D. NUMBER CALL UNDERGROUND SERVICE ALERT TOLL FREE 1-800-422-4133 TWO WORKING DAYS BEFORE YOU DIG.

SECTION 4216/4217 OF THE

EARTHWORK ESTIMATE

EXCAVATION (CUT) 3,740 CY EMBANKMENT (FILL) 60 CY SOIL EXPORT 3,680 CY

CONSTRUCTION NOTES AND QUANTITY ESTIMATE

HARDSCAPE AND DRAINAGE IMPROVEMENTS

1 — CONSTRUCT CONC. DRIVEWAY AND HARDSCAPE. SEE DETAIL ON SHEET C3.	4,020 S.F.
2 — CONSTRUCT CONC. PAVERS. SEE DETAIL ON SHEET C3.	1,340 S.F.
3-INSTALL 6" Ø PVC DRAIN PIPE SYSTEM (SCH. 40)	285 L.F.
4 - INSTALL 4" Ø PVC DRAIN PIPE SYSTEM (SCH. 40 OR SDR35.)	370 L.F.
5 — CONSTRUCT 24" WIDE CONC. V-DITCH. SEE DETAIL ON SHEET C3.	120 L.F.
6 - INSTALL 6" ATRIUM GRATE NDS TYPE 90 W/ RISER & ADAPTOR OR EQUAL.	5 EA.
7-INSTALL 6" FLAT GRATE NDS TYPE 40 W/ RISER & ADAPTOR OR EQUAL.	2 EA.
8 - INSTALL 12" ATRIUM GRATE NDS TYPE 1280 W/ RISER & ADAPTOR OR EQUAL.	6 EA.
9-INSTALL 18" SQ. DRAINBOX (BROOKS 1818CB) W/ TRAFFIC RATED GRATE.	2 EA.
10-INSTALL 18" ATRIUM GRATE NDS TYPE 1881 W/ RISER & ADAPTOR OR EQUAL.	3 EA.
11)-INSTALL 24" SQ. DRAINBOX (BROOKS 2424CB) W/ TRAFFIC GRATE (NDS 2415).	1 EA.
12-INSTALL DRAINAGE SPREADER DEVICE. SEE DETAIL ON SHEET C3.	40 L.F.
13-INSTALL SUBDRAIN PER SOILS REPORT. SEE DETAIL ON SHEET C3.	165 L.F.
14-INSTALL 5" WIDE TRENCH DRAIN W/ TRAFFIC GRATE (NDS 864 OR EQUAL).	40 L.F.
15-INSTALL 6" SQ. DRAINBOX (BROOKS 66CB) W/ TRAFFIC RATED GRATE.	2 EA.
NOTE: QUANTITIES SHOWN HEREON ARE ESTIMATED FOR PERMIT PURPOSES ONLY.	CONTRACTOR


SHEET INDEX

PRECISE GRADING PLAN

SECTIONS AND DETAILS

EROSION CONTROL PLAN

TITLE SHEET

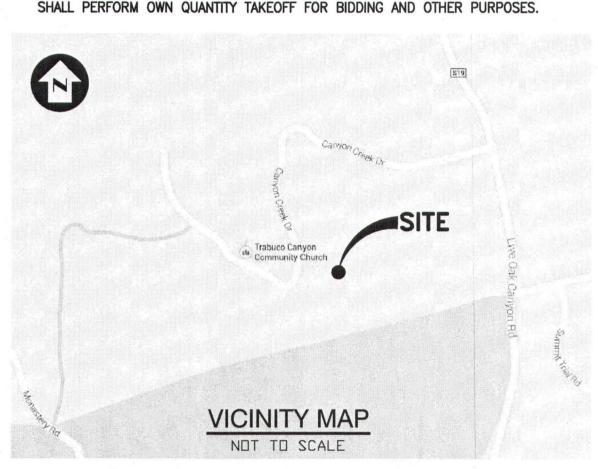

DEVELOPMENT STATISTICS

SITE AREA	1.45 AC	63,345	SF
DISTURBED AREA	0.52 AC	22,600	SF
IMPERVIOUS AREA		1	
PRE-PROJECT	0.00 AC	0	SF
NEW OR REPLACEMENT	0.22 AC	9,730	SF
POST-PROJECT	0.22 AC	9,730	SF

TRABUCO CANYON WATER DISTRICT

SOUTHERN CALIFORNIA EDISON

UTILITY COMPANIES

SILMOD PROPANE

TELEPHONE: PACIFIC BELL OWNER

ELECTRIC:

MR. & MRS. JOHN REED 30122 CANYON CREEK ROAD TRABUCO CANYON, CA 92679 TEL: (949) 888-8069, (619) 861-9599 EMAIL: republicanj@yahoo.com

ARCHITECT JAY CRAWFORD 470 WALD

IRVINE, CA 92618 TEL: (949) 453-9893

GEOLOGIC AND SOILS ENGINEER

G.A. NICOLL AND ASSOCIATES, INC. 3002 DOW AVENUE, SUITE 206 TUSTIN, CA 92780 TEL: (949) 250-9111

LEGAL DESCRIPTION PARCEL 3. P.M.B. 12/33 TRABUCO CANYON, ORANGE COUNTY, CA BASIS OF BEARINGS BEING THE CENTERLINE OF CANYON

P.M.B. 12/33, SHOWN HEREON AS

(714) 649-4400

(949) 858-0277

(800) 655-4555

(800) 288-2020

JOB ADDRESS

30122 CANYON CREEK DRIVE

TRABUCO CANYON, CA 92679

BENCH MARK

CREEK ROAD, PER PARCEL 3,

N 19°10'36" W.

ORANGE COUNTY SURVEYOR'S B.M. DESIGNATED 3W-47-77 ELEV. 1199.572 NAVD 88 DATUM, 1990 ADJ.

COUNTY OF ORANGE PLAN CHECK NO

ENGINEERING, INC

PLANS PREPARED BY:

C4

CIVIL ENGINEERING LAND SURVEYING STORMWATER QUALITY 139 Avenida Navarro

9 4 9 . 4 9 2 . 8 5 8 6 www.toalengineering.com

San Clemente, CA 92672

CIVIL

CALEB RIOS R.C.E. 57587 DATE: 10.22-16


PREPARED FOR:


MR. JOHN REED 30122 CANYON CREEK DRIVE TRABUCO CANYON, CA 92679 TEL: (619) 861-9599 EMAIL: republicanj@yahoo.com

S

H. SCALE: 11-2-16 N/A SURVEY DATE: V. SCALE: 10-24-13 N/A DRN.: P.G. DWG. NO. CHD.: M.F.B.

APPD.: C.R. JOB NO. SHEET OF 15176

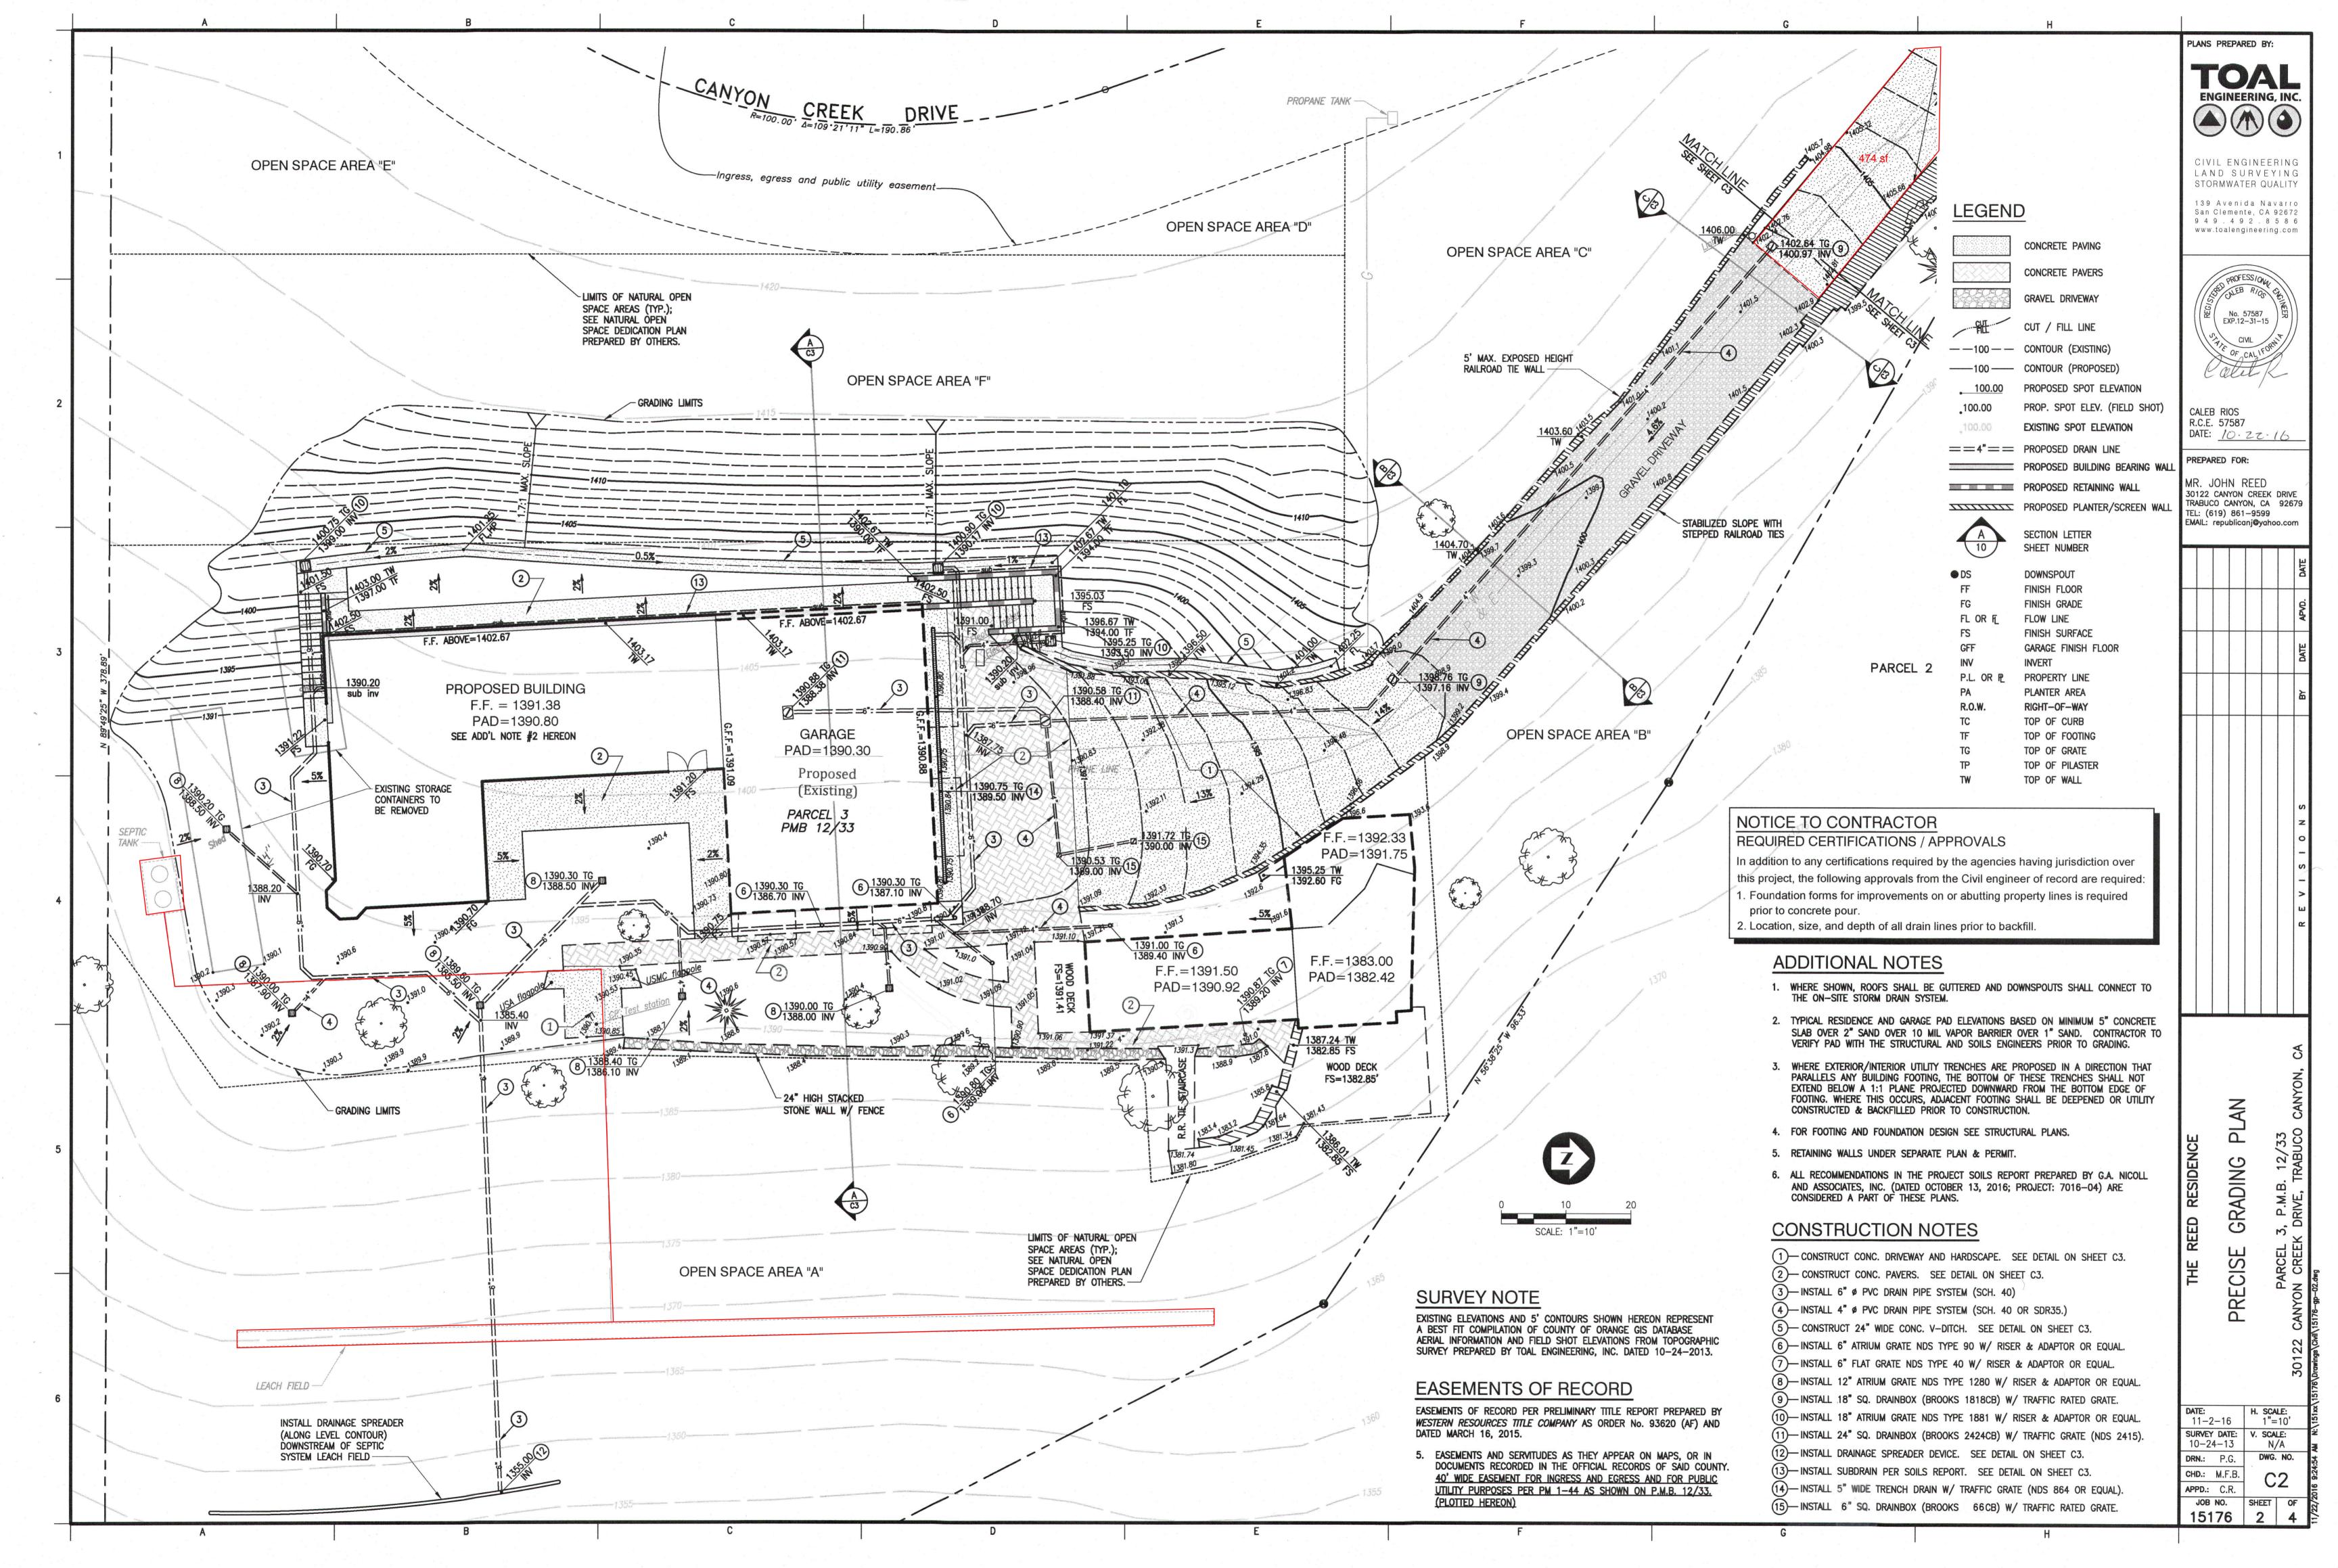

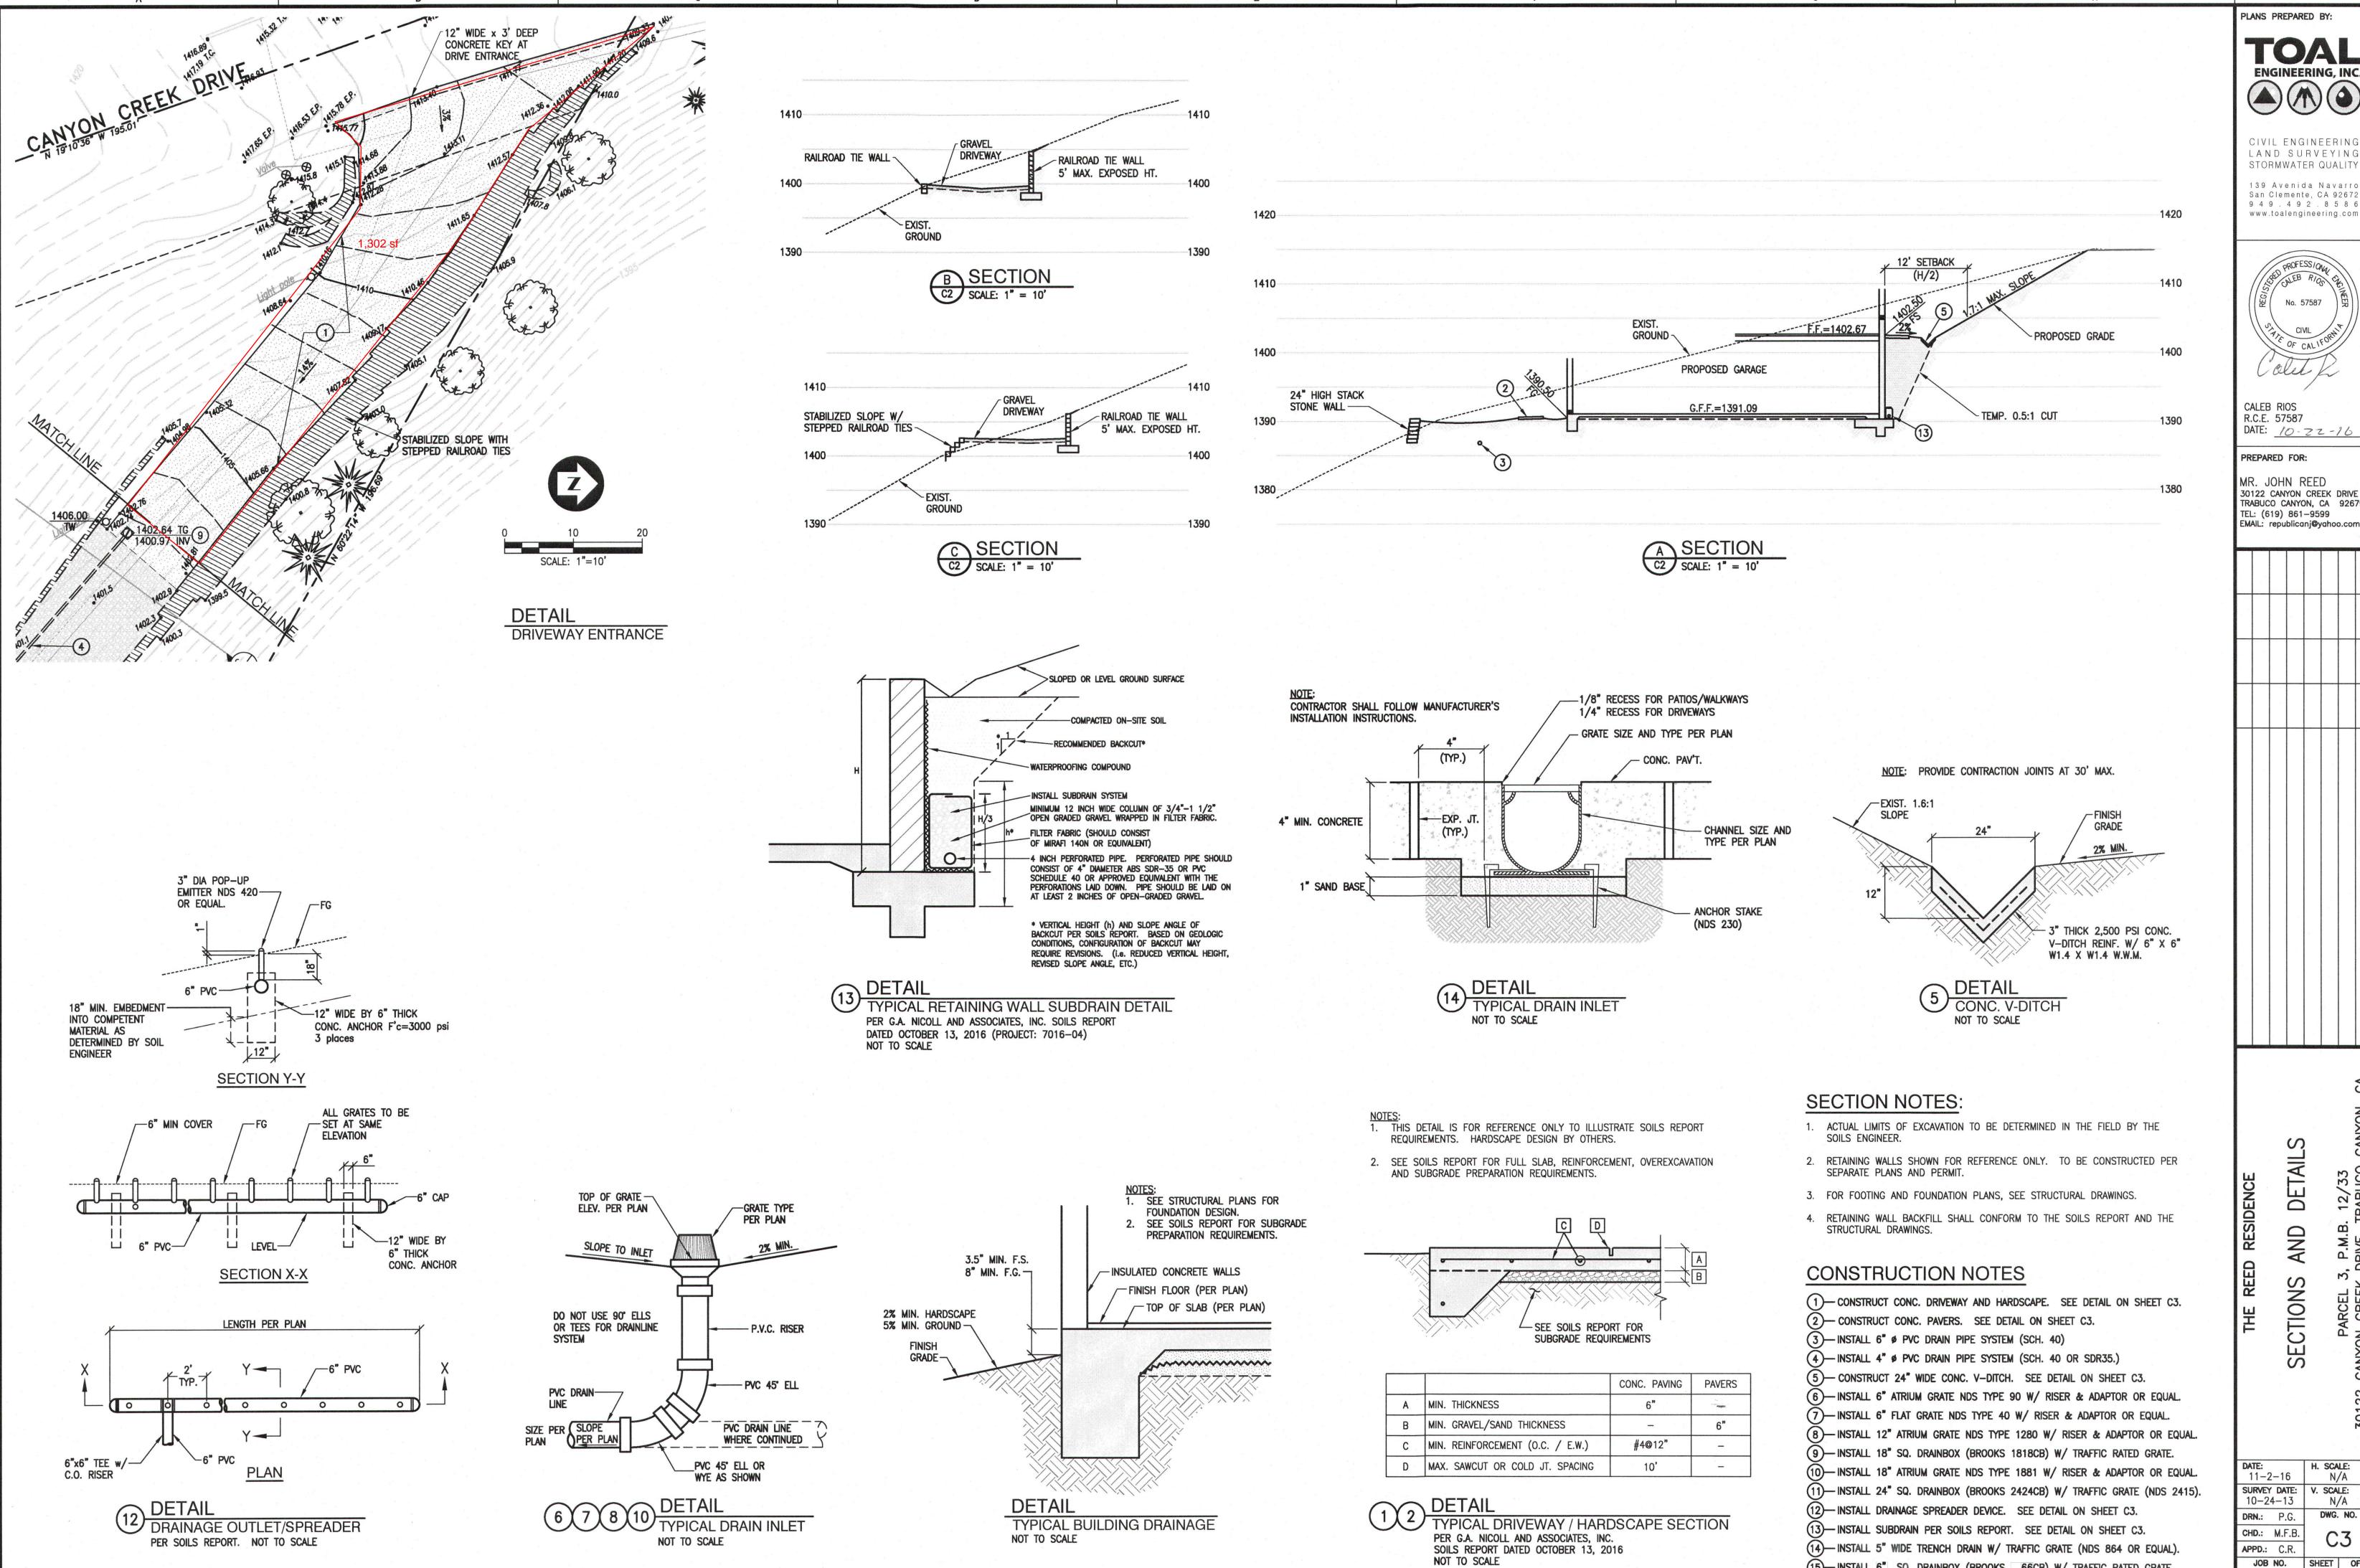

ENGINEERING, INC

CIVIL ENGINEERING LAND SURVEYING STORMWATER QUALITY 139 Avenida Navarro

No. 57587 Olec

DATE: 10-22-16

PREPARED FOR: MR. JOHN REED

30122 CANYON CREEK DRIVE TRABUCO CANYON, CA 92679 TEL: (619) 861-9599 EMAIL: republicanj@yahoo.com

(15)—INSTALL 6" SQ. DRAINBOX (BROOKS 66CB) W/ TRAFFIC RATED GRATE.

SECTIONS H. SCALE: N/A V. SCALE: N/A


DWG. NO.

SHEET OF

15176

DETAIL

AND

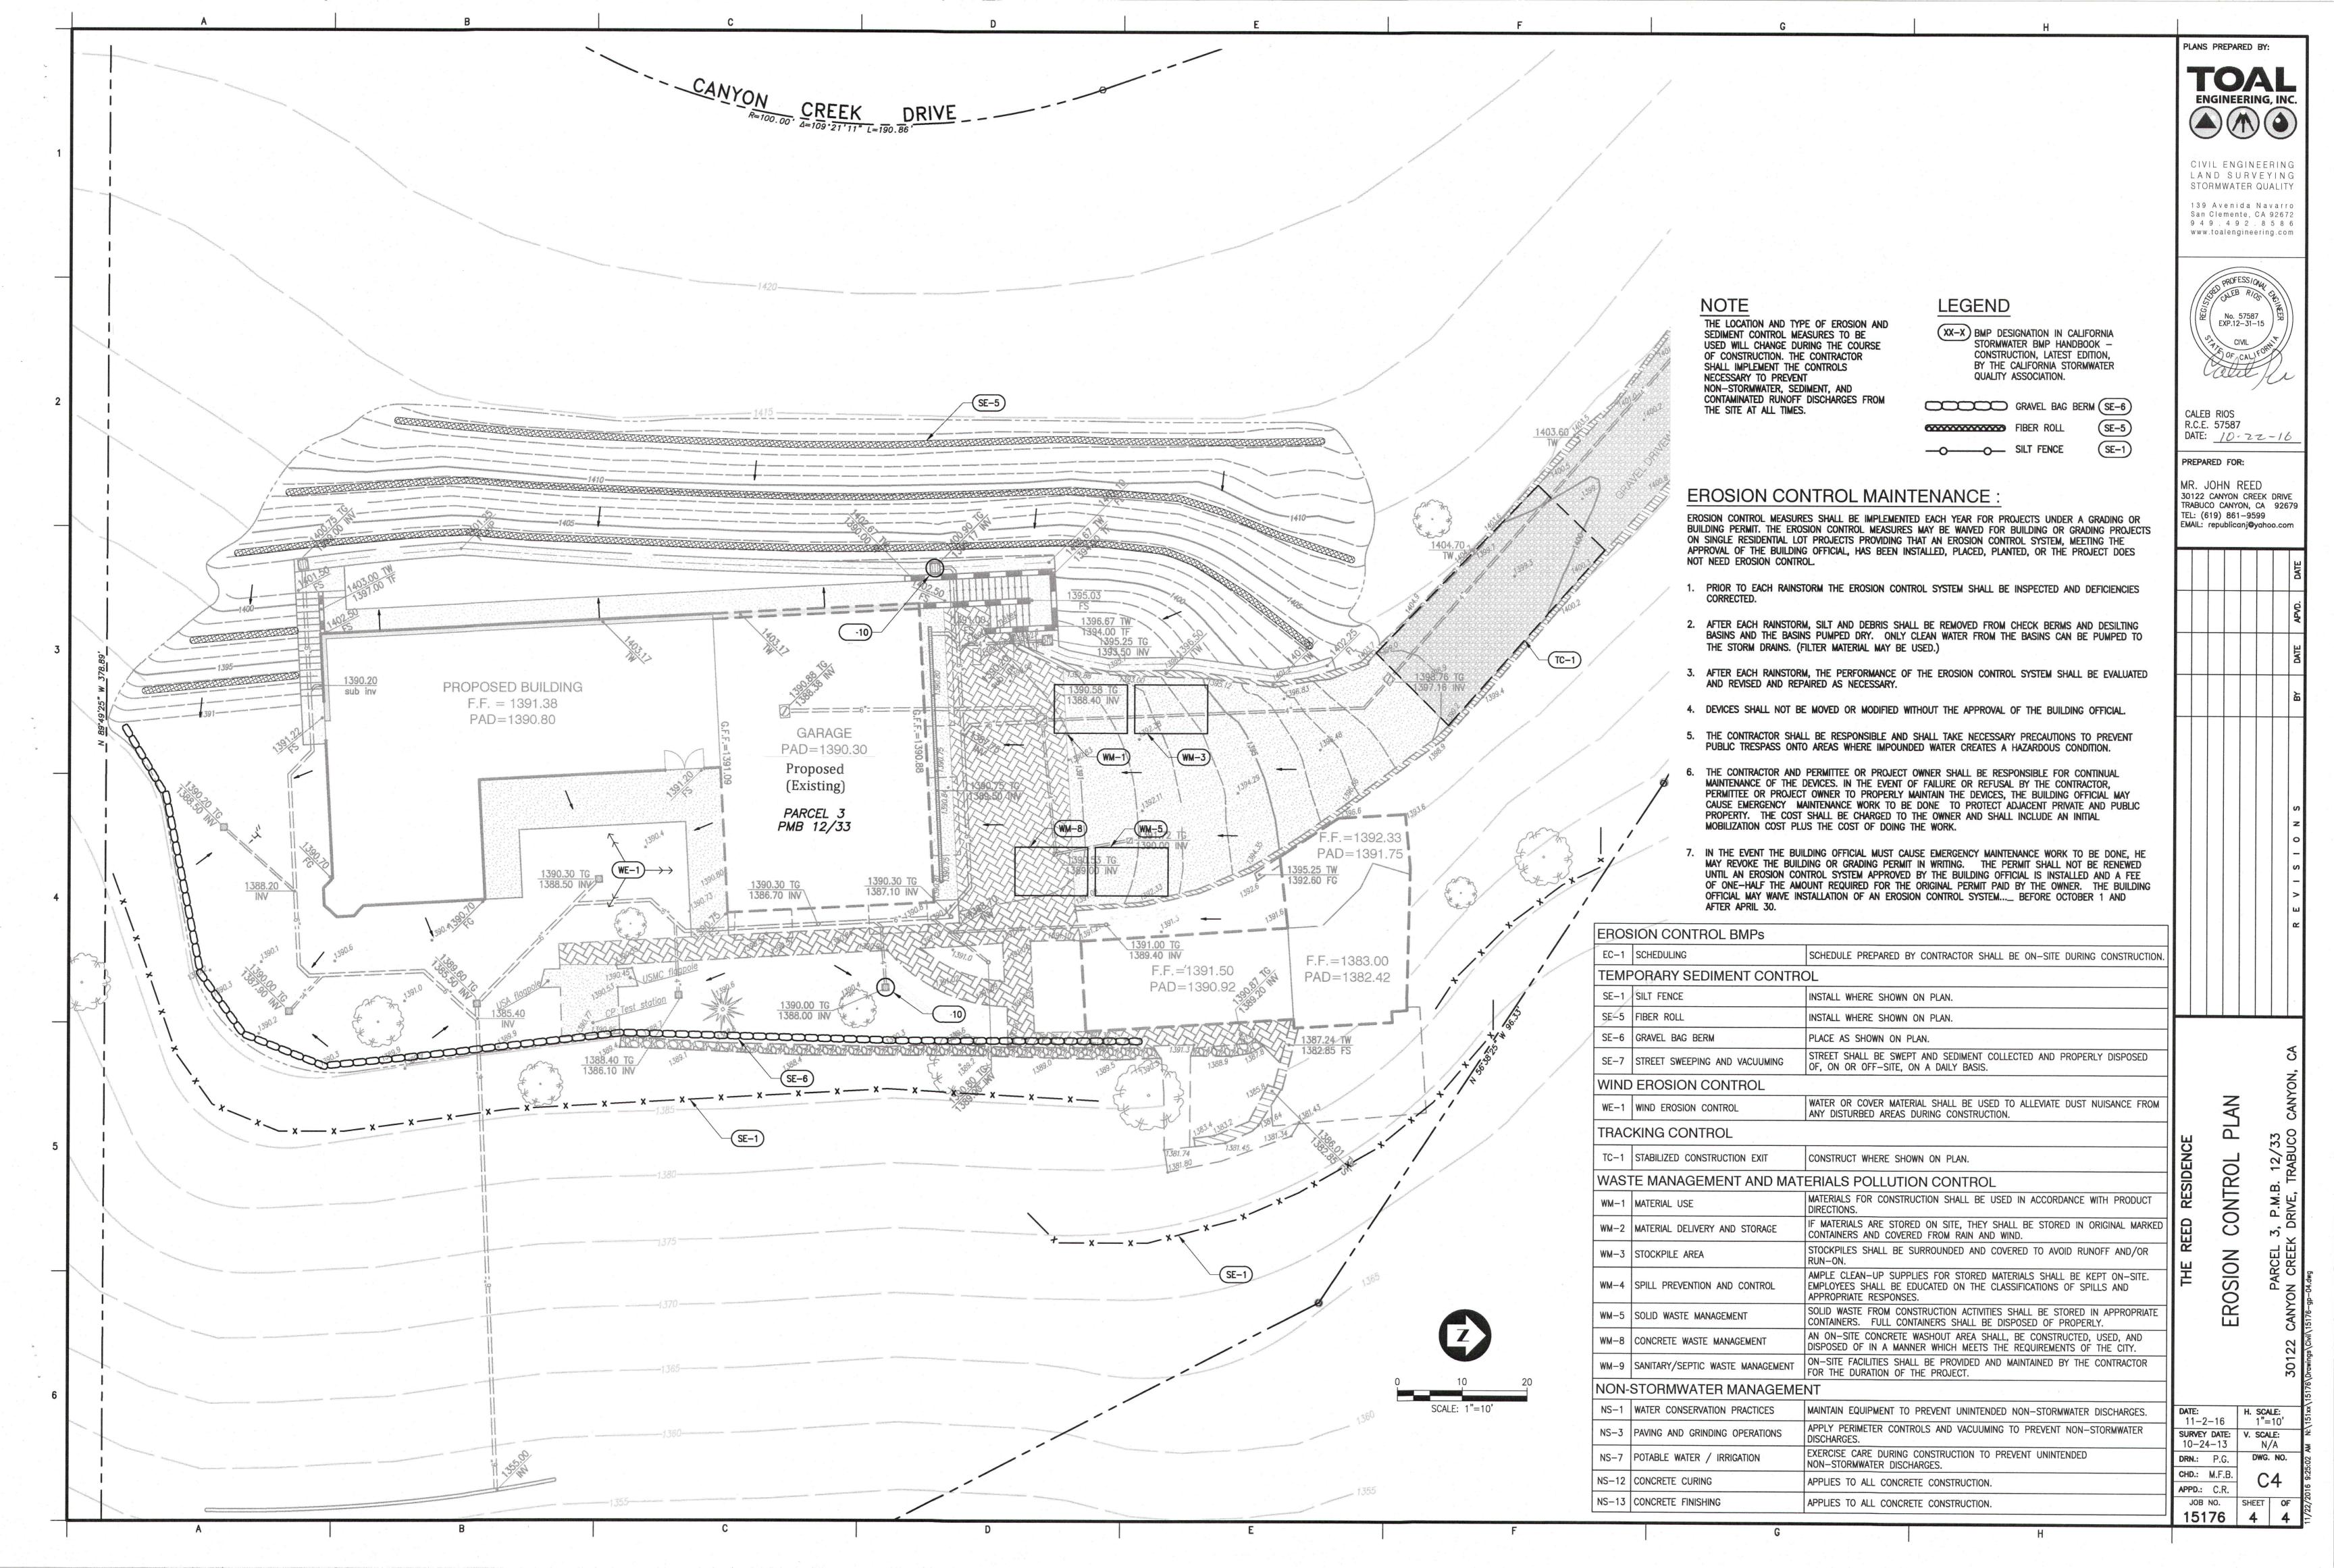

- CONSTRUCTION CONTRACTOR AGREES THAT IN ACCORDANCE WITH GENERALLY ACCEPTED CONSTRUCTION PRACTICES CONSTRUCTION CONTRACTOR WILL BE REQUIRED TO ASSUME SOLE AND COMPLETE RESPONSIBILITY FOR JOB SITE CONDITIONS DURING THE COURSE OF CONSTRUCTION OF THE PROJECT, INCLUDING SAFETY OF ALL PERSONS AND PROPERTY; THAT THIS REQUIREMENT SHALL BE MADE TO APPLY CONTINUOUSLY AND NOT BE LIMITED TO NORMAL WORKING HOURS, AND CONSTRUCTION CONTRACTOR FURTHER AGREES TO DEFEND, INDEMNIFY AND HOLD DESIGN PROFESSIONAL HARMLESS FROM ANY AND ALL LIABILITY. REAL OR ALLEGED. IN CONNECTION WITH THE PERFORMANCE OF WORK ON THIS PROJECT, EXCEPTING LIABILITY ARISING FROM THE SOLE NEGLIGENCE OF DESIGN PROFESSIONAL.
- 2. ALL EXISTING TOPOGRAPHY AND EXISTING GRADES SHOULD BE FIELD VERIFIED PRIOR TO CONSTRUCTION.
- 3. THE EXISTENCE AND LOCATION OF ANY UNDERGROUND UTILITIES OR STRUCTURES SHOWN ON THESE PLANS ARE OBTAINED BY A SEARCH OF AVAILABLE RECORDS. TO THE BEST OF OUR KNOWLEDGE, THERE ARE NO EXISTING UTILITIES EXCEPT THOSE SHOWN ON THESE PLANS. THE CONTRACTOR IS REQUIRED TO TAKE ALL PRECAUTIONARY MEASURES TO PROTECT THE UTILITIES SHOWN, AND ANY OTHER LINES OR STRUCTURES NOT SHOWN ON THESE PLANS, AND IS RESPONSIBLE FOR THE PROTECTION OF, AND ANY DAMAGE TO, THESE LINES OR STRUCTURES. (ALL UTILITIES HAVE BEEN INSTALLED).
- EARTHWORK AND OTHER CONSTRUCTION ITEM QUANTITIES ARE ESTIMATES FOR AGENCY SUBMITTAL OF THIS PLAN AND ARE NOT TO BE USED FOR CONSTRUCTION COST ESTIMATES FOR BIDDING PURPOSES. CONTRACTOR(S) TO DEVELOP OWN QUANTITIES FOR BIDDING PURPOSES.
- A SOILS INVESTIGATION MUST BE MADE BY A QUALIFIED SOILS ENGINEER AND/OR GEOLOGIST. SOILS AND EARTH ACCEPTABILITY AE NOT UNDER THE PURVIEW OF THE RESPONSIBILITY OF DESIGN ENGINEER OF THIS PLAN. THE DESIGN ENGINEER DOES NOT TEST OR OBSERVE SOILS CONDITIONS PRIOR TO, DURING OR AFTER CONSTRUCTION AND HAS NO RESPONSIBILITY FOR SOILS (EARTH) STRUCTURES. (N/A)
- 6. IF THIS PROJECT IS STAKED BY SURVEY CREWS OTHER THAN THOSE CREWS UNDER THE DIRECT SUPERVISION OF THE SIGNATORY ENGINEER, THE SIGNATORY ENGINEER WILL NO LONGER BE THE ENGINEER OF RECORD AND WILL HAVE NO RESPONSIBILITY AS TO THE FINAL CONSTRUCTED PROJECT. THE SIGNATORY ENGINEER WILL NOT BE RESPONSIBLE FOR ERRORS OR OMISSIONS THAT COULD HAVE BEEN CORRECTED DURING THE CONSTRUCTION OF THIS PROJECT, IF THE STAKING HAD BEEN DONE BY SURVEY CREWS UNDER HIS DIRECT SUPERVISION.
- AN EASEMENT SEARCH WAS CONDUCTED FOR THIS PROJECT. THERE IS ONLY ONE ROAD EASEMENT AS NOTED ON THE TOPOGRAPHIC SURVEY.
- 8. ALL RETAINING WALL DESIGNS, T.W., T.F., STRUCTURAL, THICKNESS, SUBDRAINS, ETC. ARE TO BE BUILT PER STRUCTURAL ENGINEER, AND NOT BY INFORMATION SHOWN ON THIS PLAN. DESIGN OF RETAINING WALLS IS BY OTHERS, NOT TOAL
- 9. ALL SURFACE DRAINAGE, INCLUDING SHEET, SWALE OR DRAINAGE PIPES WILL NEED TO BE MAINTAINED FOR THE LIFE OF THE PROJECT. IT IS UP TO THE OWNER OF THE PROPERTY TO PERIODICALLY INSPECT AND MAINTAIN THE DRAINAGE TO ASSURE THAT NO BLOCKAGE OCCURS. CARE SHOULD BE TAKEN SO AS TO NOT OVER WATER, THEREBY CAUSING SOILS SATURATION.

GRADING NOTES

- ALL WORK SHALL BE IN ACCORDANCE WITH THE GRADING CODE OF THE COUNTY OF ORANGE AND ANY SPECIAL REQUIREMENTS OF THE PERMIT. A COPY OF THE GRADING CODE AND MANUAL SHALL BE RETAINED ON THE JOB SITE WHILE WORK IS IN PROGRESS. WHEN REFERENCED ON THE PLANS, A COPY OF OCPW STANDARD PLANS SHALL BE
- GRADING SHALL NOT BE STARTED WITHOUT FIRST NOTIFYING THE CITY GRADING INSPECTOR. A PRE-GRADING MEETING ON THE SITE IS REQUIRED BEFORE START OF GRADING WITH THE FOLLOWING PEOPLE PRESENT: OWNER, GRADING CONTRACTOR, DESIGN CIVIL ENGINEER, SOIL ENGINEER, GEOLOGIST, DISTRICT GRADING INSPECTOR AND WHEN REQUIRED THE ARCHAEOLOGIST AND PALEONTOLOGIST. THE REQUIRED INSPECTIONS FOR GRADING WILL BE EXPLAINED AT THIS MEETING. (GRADING 7 CU. YDS.; NO PRE-GRADING MEETING REQUIRED).
- ISSUANCE OF A GRADING PERMIT DOES NOT ELIMINATE THE NEED FOR PERMITS FROM OTHER AGENCIES WITH REGULATORY RESPONSIBILITIES FOR CONSTRUCTION ACTIVITIES ASSOCIATED WITH THE WORK AUTHORIZED ON THIS PLAN. (GRADING PERMIT NOT REQUIRED).
- (4) THE GRADING PERMIT AND AN APPROVED COPY OF THE GRADING PLAN SHALL BE ON THE PERMITTED SITE WHILE WORK IS IN PROGRESS. (NOT REQUIRED).
- PRELIMINARY SOIL AND GEOLOGY REPORTS AND ALL SUBSEQUENT REPORTS AS APPROVED BY THE OC PLANNING, GRADING SECTION, ARE CONSIDERED A PART OF THE APPROVED GRADING PLAN. (NOT REQUIRED).
- (6) THE SOIL ENGINEER AND THE ENGINEERING GEOLOGIST SHALL PERFORM SUFFICIENT INSPECTIONS AND BE AVAILABLE DURING GRADING AND CONSTRUCTION TO VERIFY COMPLIANCE WITH THE PLANS. SPECIFICATIONS AND THE CODE WITHIN
- (7) THE CIVIL ENGINEER SHALL BE AVAILABLE DURING GRADING TO VERIFY COMPLIANCE WITH THE PLANS, SPECIFICATIONS, CODE AND ANY SPECIAL CONDITIONS OF THE PERMIT WITHIN THEIR PURVIEW. (NOT REQUIRED).
- THE ENGINEERING GEOLOGIST AND SOIL ENGINEER SHALL, AFTER CLEARING AND PRIOR TO THE PLACEMENT OF FILL IN CANYONS, INSPECT EACH CANYON FOR AREAS OF ADVERSE STABILITY AND TO DETERMINE THE PRESENCE OR ABSENCE OF SUBSURFACE WATER OR SPRING FLOW. IF NEEDED, SUBDRAINS WILL BE DESIGNED AND CONSTRUCTED PRIOR TO THE PLACEMENT OF FILL IN EACH RESPECTIVE CANYON. (NO FILL).
- (9) SUBDRAIN OUTLETS SHALL BE COMPLETED AT THE BEGINNING OF THE SUBDRAIN CONSTRUCTION.
- THE EXACT LOCATION OF THE SUBDRAINS SHALL BE SURVEYED IN THE FIELD FOR LINE/GRADE AND SHOWN ON AS-GRADED PLANS.
- (11) AREAS TO RECEIVE FILL SHALL BE PROPERLY PREPARED AND APPROVED IN WRITING BY THE SOILS ENGINEER AND THE BUILDING OFFICIAL PRIOR TO PLACING FILL. (NOT REQUIRED. NO FILL.)
- (12) FILLS SHALL BE BENCHED INTO COMPETENT MATERIAL PER O.C.P.W. STANDARD PLAN NO. 1322. (N/A)
- ALL EXISTING FILLS SHALL BE APPROVED BY THE BUILDING OFFICIAL OR REMOVED PRIOR TO PLACING ADDITIONAL FILLS. (THERE ARE NO FILLS).
- (14) FILLS SHALL BE COMPACTED THROUGHOUT TO A MINIMUM OF 90% RELATIVE DENSITY, AGGREGATE BASE FOR ASPHALTIC AREAS SHALL BE COMPACTED TO MINIMUM OF 95% RELATIVE DENSITY. MAXIMUM DENSITY SHALL BE DETERMINED BY UNIFORM BUILDING CODE STANDARD NO. 70-1 OR APPROVED EQUIVALENT, AND FIELD DENSITY BY UNIFORM BUILDING CODE STANDARD NO. 70-2 OR APPROVED EQUIVALENT. (N/A)
- CUT AND FILL SLOPES SHALL BE NO STEEPER THAN 2 FOOT HORIZONTAL TO 1 FOOT VERTICAL (2:1) EXCEPT WHERE SPECIFICALLY APPROVED OTHERWISE. (N/A)
- ALL CUT SLOPES SHALL BE INVESTIGATED BOTH DURING AND AFTER GRADING BY THE ENGINEERING GEOLOGIST TO DETERMINE IF ANY SLOPE STABILITY PROBLEM EXISTS. SHOULD EXCAVATION DISCLOSE ANY GEOLOGICAL HAZARDS OR POTENTIAL GEOLOGICAL HAZARDS, THE ENGINEERING GEOLOGIST SHALL SUBMIT RECOMMENDED TREATMENT TO THE BUILDING OFFICAL FOR APPROVAL. (N/A)
- WHERE SUPPORT OR BUTTRESSING OF CUT AND NATURAL SLOPE IS DETERMINED TO BE NECESSARY BY THE ENGINEERING GEOLOGIST AND SOIL ENGINEER. THE SOIL ENGINEER SHALL SUBMIT DESIGN. LOCATIONS AND CALCULATIONS TO THE BUILDING OFFICAL PRIOR TO CONSTRUCTION. THE ENGINEERING GEOLOGIST AND SOIL ENGINEER SHALL INSPECT AND PROVIDE RECOMMENDATIONS AS NECESSARY FOR THE CONSTRUCTION OF THE BUTTRESSING AND CERTIFY TO THE STABILITY OF SLOPE AND ADJACENT STRUCTURES UPON COMPLETION. (N/A)
- WHEN CUT PADS ARE BROUGHT NEAR GRADE, THE ENGINEERING GEOLOGIST SHALL DETERMINE IF THE BEDROCK IS EXTENSIVELY FRACTURED OR FAULTED AND WILL READILY TRANSMIT WATER. IF CONSIDERED NECESSARY BY THE ENGINEERING GEOLOGIST AND SOIL ENGINEER A COMPACTED FILL BLANKET WILL BE PLACED. (N/A)
- (19) ALL TRENCH BACKFILLS SHALL BE TESTED AND APPROVED BY THE SOIL ENGINEER PER THE GRADING CODE. (N/A)
- ANY EXISTING IRRIGATION LINES AND CISTERNS SHALL BE REMOVED, OR CRUSHED IN PLACE, AND APPROVED BY THE BUILDING OFFICIAL AND SOIL ENGINEER. (N/A)
- ANY EXISTING WATER WELLS SHOULD BE ABANDONED IN COMPLIANCE WITH THE SPECIFICATIONS APPROVED BY ORANGE COUNTY, HEALTH CARE AGENCY, AND DIVISION OF ENVIRONMENTAL HEALTH. (N/A)
- ANY EXISTING CESSPOOLS AND SEPTIC TANKS SHALL BE ABANDONED IN COMPLIANCE WITH THE UNIFORM PLUMBING CODE TO THE APPROVAL OF OC PLANNING/BUILDING INSPECTION. (N/A)

EXPORT SOIL MUST BE TRANSPORTED TO A LEGAL DUMP OR TO A PERMITTED SITE APPROVED BY THE DISTRICT

- STOCKPILING OF EXCESS MATERIAL SHALL BE APPROVED BY THE BUILDING OFFICAL PRIOR TO EXCAVATION.
- GRADING INSPECTOR. (N/A) THE PERMITTEE SHALL COMPLY WITH THE GRADING CODE REQUIREMENTS FOR HAUL ROUTES WHEN AN EXCESS OF
- 5,000 CUBIC YARDS OR EARTH IS TRANSPORTED TO OR FROM A PERMITTED SITE ON PUBLIC ROADWAYS. (N/A)
- THE PERMITTEE IS RESPONSIBLE FOR DUST CONTROL MEASURES.
- THE PERMITTEE SHALL GIVE REASONABLE NOTICE TO THE OWNER OF ADJOINING LANDS AND BUILDINGS PRIOR TO BEGINNING EXCAVATIONS WHICH MAY AFFECT THE LATERAL AND SUBJACENT SUPPORT OF THE ADJOINING PROPERTY. THE NOTICE SHALL STATE THE INTENDED DEPTH OF EXCAVATION AND WHEN THE EXCAVATION WILL COMMENCE. THE ADJOINING OWNER SHALL BE ALLOWED AT LEAST 30 DAYS AND REASONABLE ACCESS ON THE PERMITTED PROPERTY TO PROTECT HIS STRUCTURE, IF HE SO DESIRES, UNLESS OTHERWISE PROTECTED BY LAW.
- ALL CONCRETE STRUCTURES THAT COME IN CONTACT WITH THE ON-SITE SOILS SHALL BE CONSTRUCTED WITH TYPE V CEMENT, UNLESS DEEMED UNNECESSARY BY SOLUBLE SULPHATE-CONTENT TESTS CONDUCTED BY THE SOIL ENGINEER.

PRECISE GRADING PLAN

THE REED RESIDENCE & FAMILY GUEST HOUSE

30122 CANYON CREEK DRIVE (PARCEL 3, PMB 12/33) ORANGE COUNTY, CALIFORNIA

GRADING NOTES (cont.)

- SLOPES EXCEEDING 5 FEET IN HEIGHT SHALL BE PLANTED WITH AN APPROVED PLANT MATERIAL. IN ADDITION, SLOPES EXCEEDING 15 FEET IN HEIGHT SHALL BE PROVIDED WITH AN APPROVED IRRIGATION SYSTEM, UNLESS OTHERWISE APPROVED BY THE BUILDING OFFICIAL.
- ALL EXISTING DRAINAGE COURSES THROUGH THIS SITE SHALL REMAIN OPEN UNTIL FACILITIES TO HANDLE STORM WATER ARE APPROVED AND FUNCTIONAL; HOWEVER, IN ANY CASE, THE PERMITTEE SHALL BE HELD LIABLE FOR ANY DAMAGE DUE TO OBSTRUCTING NATURAL DRAINAGE PATTERNS.
- (31) SANITARY FACILITIES SHALL BE MAINTAINED ON THE SITE.
- (32) THE LOCATION AND PROTECTION OF ALL UTILITIES IS THE RESPONSIBILITY OF THE PERMITTEE.
- APPROVED PROTECTIVE MEASURES AND TEMPORARY DRAINAGE PROVISIONS SHALL BE USED TO PROTECT ADJOINING PROPERTIES DURING GRADING. (N/A)
- GRADING OPERATIONS INCLUDING MAINTENANCE OF EQUIPMENT WITHIN ONE-HALF MILE OF A HUMAN OCCUPANCY SHALL NOT BE CONDUCTED BETWEEN THE HOURS OF 8:00 P.M. AND 7:00 A.M. DAILY, ON SUNDAY OR ON A FEDERAL HOLIDAY.
- (A) ALL CONSTRUCTION VEHICLES OR EQUIPMENT, FIXED OR MOBILE, OPERATED WITHIN 1,000' OR A DWELLING SHALL BE EQUIPPED WITH PROPERLY OPERATING AND MAINTAINED MUFFLERS. (B) ALL OPERATIONS SHALL COMPLY WITH ORANGE COUNTY CODIFIED ORDINANCE DIVISION 6 (NIIISE
- (C) STOCKPILING AND/OR VEHICLE STAGING AREAS SHALL BE LOCATED AS FAR AS PRACTICABLE FROM DWELLINGS AND WITHIN THE LIMITS OR GRADING PERMIT.
- GRADING AND EXCAVATION SHALL BE HALTED DURING PERIODS OF HIGH WINDS. ACCORDING TO AQMD MEASURES F-4, HIGH WINDS ARE DEFINED AS 30 MPH OR GREATER. THIS LEVEL OCCURS ONLY UNDER UNUSUALLY EXTREME CONDITIONS, SUCH AS SANTA ANA WIND CONDITIONS.
- ASPHALT SECTIONS MUST BE PER CODE: PARKING STALLS = 3" A/C OVER 6" A/B, DRIVES 3: A/C OVER 10" (COMM) 12" (INDUSTRIAL). OR: PRIOR TO ROUGH GRADE RELEASE FOR BUILDING PERMITS BY THE DISTRICT GRADING INSPECTOR. THE SOIL ENGINEER SHALL SUBMIT FOR APPROVAL, PAVEMENT SECTION RECOMMENDATIONS BASED ON "R" VALUE ANALYSIS OF THE SUBGRADE SOILS, AND EXPECTED TRAFFIC INDICES. (N/A)
- ASPHALT CONCRETE SHALL BE CONSTRUCTED PER THE REQUIREMENTS OF OCPW STANDARD PLAN
- AGGREGATE BASE SECTION SHALL BE CONSTRUCTED PER OCPW STANDARD PLAN 1804.
- ROOF GUTTERS SHALL BE INSTALLED TO PREVENT ROOF DRAINAGE FROM FALLING ON MANUFACTURED
- THE CIVIL ENGINEER, AS A CONDITION OF ROUGH GRADE APPROVAL, SHALL PROVIDE A BLUE TOP WITH ACCOMPANYING WITNESS STAKE, SET AT THE CENTER OF EACH PAD REFLECTING THE PAD ELEVATION FOR PRECISE PERMITS AND A BLUE TOP WITH WITNESS STAKE SET AT THE DRAINAGE SWALE HIGH POINT REFLECTING THE HIGH POINT ELEVATION FOR PRELIMINARY PERMITS. (N/A)
- PRIOR TO FINAL APPROVAL. THE CIVIL ENGINEER SHALL CERTIFY TO THE BUILDING OFFICIAL THE AMOUNT OF EARTH MOVED DURING THE GRADING OPERATION. (N/A)
- THE ENGINEERING GEOLOGIST SHALL PERFORM PERIODIC INSPECTIONS AND SUBMIT A COMPLETE REPORT AND MAP UPON COMPLETION OF THE ROUGH GRADING. (N/A)
- (43) THE GRADING CONTRACTOR SHALL SUBMIT A STATEMENT OF COMPLIANCE TO THE APPROVED GRADING PLAN PRIOR TO FINAL APPROVAL. (N/A)
- THE COMPACTION REPORT AND APPROVAL FROM THE SOIL ENGINEER SHALL INDICATE THE TYPE OF FIELD TESTING PERFORMED. THE METHOD OF OBTAINING THE IN-PLACE DENSITY SHALL BE IDENTIFIED WHETHER SAND CONE, DRIVE RING, OR NUCLEAR, AND SHALL BE NOTED FOR EACH TEST. SUFFICIENT MAXIMUM DENSITY DETERMINATIONS SHALL BE PERFORMED TO VERIFY THE ACCURACY OF THE MAXIMUM DENSITY CURVES USED BY THE FIELD TECHNICIAN. (N/A)
- IN THE EVENT THAT SOIL CONTAMINATION IS DISCOVERED DURING EXCAVATION AND REMOVAL OF AN EXISTING TANK, WORK SHALL BE STOPPED UNTIL A SITE ASSESSMENT AND MITIGATION PLAN HAS BEEN PREPARED, SUBMITTED AND APPROVED BY HCA/ENVIRONMENTAL HEALTH AND OC PLANNING/GRADING.

(619) 861-9599

EROSION CONTROL NOTES

JOHN REED (46) IN CASE OF EMERGENCY CALL:_ (949) 888-8069

- (47) EQUIPMENT AND WORKERS FOR EMERGENCY WORK SHALL BE MADE AVAILABLE AT ALL TIMES DURING THE RAINY SEASON. NECESSARY MATERIALS SHALL BE AVAILABLE ON SITE AND STOCKPILED AT CONVENIENT LOCATIONS TO FACILITATE RAPID CONSTRUCTION OF TEMPORARY DEVICES WHEN RAIN IS IMMINENT. (WILL NOT WORK ON GRADING DURING RAINY SEASON).
- (48) EROSION CONTROL DEVICES SHALL NOT BE MOVED OR MODIFIED WITHOUT THE APPROVAL OF THE BUILDING OFFICAL.
- (49) ALL REMOVABLE EROSION PROTECTIVE DEVICES SHALL BE IN PLACE AT THE END OF EACH WORKING DAY WHEN THE 5-DAY RAIN PROBABILITY FORECAST EXCEEDS 40%.
- (50) AFTER A RAINSTORM ALL SILT AND DEBRIS SHALL BE REMOVED FROM STREETS, CHECK BERMS & BASINS. (51) GRADED AREAS ON THE PERMITTED AREA PERIMETER MUST DRAIN AWAY FROM THE FACE OF SLOPES AT
- THE CONCLUSION OF EACH WORKING DAY. DRAINAGE TO BE DIRECTED TOWARD DESILTING FACILITIES.
- (52) THE PERMITTEE AND CONTRACTOR SHALL BE RESPONSIBLE AND SHALL TAKE NECESSARY PRECAUTIONS TO PREVENT PUBLIC TRESPASS ONTO AREAS WHERE IMPOUNDED WATER CREATES A HAZARDOUS CONDITION.
- (53) THE PERMITTEE AND CONTRACTOR SHALL INSPECT THE EROSION CONTROL WORK AND INSURE THAT THE WORK IS IN ACCORDANCE WITH THE APPROVED PLANS.

ENVIRONMENTAL NOTES

- (54) THE PERMITTEE SHALL NOTIFY ALL GENERAL CONTRACTORS, SUBCONTRACTORS, MATERIAL SUPPLIERS, LESSEESS, AND PROPERTY OWNERS THAT DUMPING OF CHEMICALS INTO THE STORM DRAIN SYSTEM OR THE WATERSHED IS PROHIBITED.
- (55) PERMITTEE SHALL MAINTAIN CONSTRUCTION SITE IN SUCH A CONDITION THAT AN ANTICIPATED STORM DOES NOT CARRY WASTES OR POLLUTANTS OFF THE SITE. POTENTIAL POLLUTANTS INCLUDE BUT ARE NOT LIMITED TO: SOLID OR LIQUID CHEMICAL SPILLS; WASTES FROM PAINTS, STAINS, SEALANTS, GLUES, LIMES, PESTICIDES, HERBICIDES, WOOD PRESERVATIVES AND SOLVENTS; ASBESTOS FIBERS, PAINTS FLAKES OR STUCCO FRAGMENTS; FUELS, OILS, LUBRICANTS, AND HYDRAULIC, RADIATOR, OR BATTERY FLUIDS; FERTILIZERS, VEHICLE/EQUIPMENT WASH WATER AND CONCRETE WASH WATER; CONCRETE, DETERGENT OR FLOATABLE WATES; WASTES FROM ANY ENGINE/EQUIPMENT STEAM CLEANING OR CHEMICAL DEGREASING; AND SUPERCHLORINATED POTABLE WATER LINE FLUSHINGS. DURING CONSTRUCTION, PERMITTEE SHALL DISPOSE OF SUCH MATERIALS IN A SPECIFIED AND CONTROLLED TEMPORARY AREA ON-SITE, PHYSICALLY SEPARATED FROM POTENTIAL STORMWATER RUNOFF, WITH ULTIMATE DISPOSAL IN ACCORDANCE WITH LOCAL, STATE. AND FEDERAL REQUIREMENTS.
- (56) PERMITTEE MAY DISCHARGE MATERIAL OTHER THAN STORMWATER ONLY WHEN NECESSARY FOR PERFORMANCE AND COMPLETION OF CONSTRUCTION PRACTICES AND WHERE THEY DO NOT: CAUSE OR CONTRIBUTE TO A VIOLATION OF ANY WATER QUALITY STANDARD: CAUSE OR THREATEN TO TO CAUSE POLLUTION, CONTAMINATION, OR NUISANCE: OR CONTAIN A HAZARDOUS SUBSTANCE IN A QUANTITY REPORTABLE UNDER FEDERAL REGULATIONS 40 CFR PARTS 117 AND 302.

ENVIRONMENTAL NOTES (cont.)

- (57) DEWATERING OF CONTAMINATED GROUNDWATER. OR DISCHARGING CONTAMINATED SOILS VIA SURFACE EROSION IS PROHIBITED. DEWATERING OF NON-CONTAMINATED GROUNDWATER REQUIRES A NATIONAL POLLUTANT DISCHARGE ELIMINATION SYSTEM PERMIT FROM THE RESPECTIVE STATE REGIONAL WATER QUALITY CONTROL BOARD.
- (58) SPECIAL NOTE: SURVEY MONUMENTS SHALL BE PRESERVED AND REFERENCED BEFORE CONSTRUCTION AND REPLACED AFTER CONSTRUCTION PURSUANT TO SECTION 8771 OF THE BUSINESS AND PROFESSIONS CODE.
- (59) THIS LOT WAS GRADED IN THE 1960'S. IT WAS USED AS A BORROW PIT TO PROVIDE FILL FOR TE CONSTRUCTION OF CANYON CREEK ROAD. CONSEQUENTLY, THE HOUSE BEING BUILT WILL WEIGH LESS THAN THE MATERIAL REMOVED TO BUILD CANYON CREEK ROAD, THIS WILL PRECLUDE LONG-TERM SETTLEMENT OF THE STRUCTURE.

NATIONAL POLLUTION DISCHARGE ELIMINATION SYSTEM (NPDES) NOTES:

THE SITE TO STREETS, DRAINAGE FACILITIES, OR ADJOINING PROPERTIES BY WIND OR RUNOFF.

- 1. IN THE CASE OF EMERGENCY, CALL _____ JOHN REED _____ AT TELEPHONE # ____ (619) 861-9599
- 2. SEDIMENT FROM AREAS DISTURBED BY CONSTRUCTION SHALL BE RETAINED ON SITE USING STRUCTURAL CONTROLS TO THE MAXIMUM EXTENT PRACTICABLE.
- 3. STOCKPILES OF SOIL SHALL BE PROPERLY CONTAINED TO MINIMIZE SEDIMENT TRANSPORT FROM THE SITE TO STREETS, DRAINAGE FACILITIES OR ADJACENT PROPERTIES VIA RUNOFF, VEHICLE TACKING, OR WIND.
- 4. APPROPRIATE BMP'S FOR CONSTRUCTION-RELATED MATERIALS, WASTES, AND SPILLS SHALL BE IMPLEMENTED TO MINIMIZE TRANSPORT FROM
- 5. RUNOFF FROM EQUIPMENT AND VEHICLE WASHING SHALL BE CONTAINED AT CONSTRUCTION SITES UNLESS TREATED TO REDUCE OR REMOVE
- 6. ALL CONSTRUCTION CONTRACTOR AND SUBCONTRACTOR PERSONNEL ARE TO BE MADE AWARE OF THE REQUIRED BEST MANAGEMENT
- PRACTICES AND GOOD HOUSEKEEPING MEASURES FOR THE PROJECT SITE AND ANY ASSOCIATED CONSTRUCTION STAGING AREAS.
- 7. AT THE END OF EACH DAY OF CONSTRUCTION ACTIVITY ALL CONSTRUCTION DEBRIS AND WASTE MATERIALS SHALL BE COLLECTED AND PROPERLY DISPOSED IN TRASH OR RECYCLE BINS.
- CONSTRUCTION SITES SHALL BE MAINTAINED IN SUCH A CONDITION THAT AN ANTICIPATED STORM DOES NOT CARRY WASTES OR POLLUTANTS OFF THE SITE. DISCHARGES OF MATERIAL OTHER THAN STORMWATER ONLY WHEN NECESSARY FOR PERFORMANCE AND COMPLETION OF CONSTRUCTION PRACTICES AND WHERE THEY DO NOT: CAUSE OR CONTRIBUTE TO A VIOLATION OF ANY WATER QUALITY STANDARD; CAUSE OR THREATEN TO CAUSE POLLUTION, CONTAMINATION, OR NUISANCE; OR CONTAIN A HAZARDOUS SUBSTANCE IN A QUANTITY REPORTABLE UNDER FEDERAL REGULATIONS 40 CFR PARTS 117 & 302.
- 9. POTENTIAL POLLUTANTS INCLUDE BUT ARE NOT LIMITED TO: SOLID OR LIQUID CHEMICAL SPILLS: WASTES FROM PAINTS, STAINS, SEALANTS GLUES, LIMES, PESTICIDES, HERBICIDES, WOOD PRESERVATIVES AND SOLVENTS; ASBESTOS FIBERS, PAINT FLAKES OR STUCCO FRAGMENTS; FUELS, OILS, LUBRICANTS, AND HYDRAULIC, RADIATOR OR BATTERY FLUIDS; FERTILIZERS, VEHICLES/EQUIPMENT WASH WATER AND CONCRETE WASH WATER; CONCRETE, DETERGENT OR FLOATABLE WASTES; WASTES FROM ANY ENGINE/EQUIPMENT STEAM CLEANING OR CHEMICAL DEGREASING; AND SUPER-CHLORINATED POTABLE WATER LINE FLUSHING.
- DURING CONSTRUCTION. PERMITTEE SHALL DISPOSE OF SUCH MATERIALS IN A SPECIFIED AND CONTROLLED TEMPORARY AREA ON SITE. PHYSICALLY SEPARATED FROM POTENTIAL STORM WATER RUNOFF, WITH ULTIMATE DISPOSAL IN ACCORDANCE WITH LOCAL, STATE AND
- 10. DEWATERING OF CONTAMINATED GROUNDWATER, OR DISCHARGING CONTAMINATED SOILS VIA SURFACE EROSION IS PROHIBITED. DEWATERING OF NON-CONTAMINATED GROUNDWATER REQUIRES A NATIONAL POLLUTANT DISCHARGE ELIMINATION SYSTEM PERMIT FROM THE RESPECTIVE STATE REGIONAL WATER QUALITY CONTROL BOARD.
- 11. GRADED AREAS ON THE PERMITTED AREA PERIMETER MUST DRAIN AWAY FROM THE FACE OF SLOPES AT THE CONCLUSION OF EACH WORKING DAY. DRAINAGE IS TO BE DIRECTED TOWARD DESILTING FACILITIES.
- 12. THE PERMITTEE AND CONTRACTOR SHALL BE RESPONSIBLE AND TAKE NECESSARY PRECAUTIONS TO PREVENT PUBLIC TRESPASS ONTO AREAS WHERE IMPOUNDED WATER CREATES A HAZARDOUS CONDITION.
- 13. THE PERMITTEE AND CONTRACTOR SHALL INSPECT THE EROSION CONTROL WORK AND INSURE THAT THE WORK IS IN ACCORDANCE WITH THE APPROVED PLANS.
- 14. THE PERMITTEE SHALL NOTIFY ALL GENERAL CONTRACTORS, SUBCONTRACTORS, MATERIAL SUPPLIERS, LESSEES, AND PROPERTY OWNERS: THAT DUMPING OF CHEMICALS INTO THE STORM DRAIN SYSTEM OR THE WATERSHED IS PROHIBITED.
- 15. EQUIPMENT AND WORKERS FOR EMERGENCY WORK SHALL BE MADE AVAILABLE AT ALL TIMES DURING THE RAINY SEASON. NECESSARY MATERIALS SHALL BE AVAILABLE ON SITE AND STOCKPILED AT CONVENIENT LOCATIONS TO FACILITATE RAPID CONSTRUCTION OF TEMPORARY DEVICES WHEN RAIN IS IMMINENT.
- 16. ALL REMOVABLE EROSION PROTECTIVE DEVICES SHALL BE IN PLACE AT THE END OF EACH WORKING DAY WHEN THE 5-DAY RAIN PROBABILITY FORECAST EXCEEDS 40%.
- 17. SEDIMENTS FROM AREAS DISTURBED BY CONSTRUCTION SHALL BE RETAINED ON SITE USING AN EFFECTIVE COMBINATION OF EROSION AND SEDIMENT CONTROLS TO THE MAXIMUM EXTENT PRACTICABLE, AND STOCKPILES OF SOIL SHALL BE PROPERLY CONTAINED TO MINIMIZE SEDIMENT TRANSPORT FROM THE SITE TO THE STREETS, DRAINAGE FACILITIES OF ADJACENT PROPERTIES VIA RUNOFF, VEHICLE TRACKING,
- 18. APPROPRIATE BMPS FOR CONSTRUCTION-RELATED MATERIALS, WASTES, SPILLS OR RESIDUES SHALL BE IMPLEMENTED AND RETAINED ON SITE TO MINIMIZE TRANSPORT FROM THE SITE TO STREETS, DRAINAGE FACILITIES, OR ADJOINING PROPERTY BY WIND OR RUNOFF.

CALIFORNIA CIVIL CODE (SECTION 832)

LATERAL AND SUBJACENT SUPPORT; EXCAVATION; DEGREE OF CARE; DAMAGES; PROTECTION OF OTHER STRUCTURES.

EACH COTERMINOUS OWNER IS ENTITLED TO THE LATERAL AND SUBJACENT SUPPORT WHICH HIS LAND RECEIVES FROM THE ADJOINING LAND, SUBJECT TO THE RIGHT OF THE OWNER OF THE ADJOINING LAND TO MAKE PROPER AND USUAL EXCAVATIONS ON THE SAME FOR PURPOSES OF CONSTRUCTION OR IMPROVEMENT, UNDER THE FOLLOWING CONDITIONS:

- 1. ANY OWNER OF LAND OR HIS LESSEE INTENDING TO MAKE OR TO PERMIT AN EXCAVATION SHALL GIVE REASONABLE NOTICE TO THE OWNER OR OWNERS OF ADJOINING LANDS AND OF BUILDINGS OR OTHER STRUCTURES, STATING THE DEPTH TO WHICH SUCH EXCAVATION IS INTENDED TO BE MADE, AND WHEN THE EXCAVATING WILL BEGIN.
- 2. IN MAKING ANY EXCAVATION, ORDINARY CARE AND SKILL SHALL BE USED, AND REASONABLE PRECAUTIONS TAKEN TO SUSTAIN THE ADJOINING LAND AS SUCH, WITHOUT REGARD TO ANY BUILDING OR OTHER STRUCTURE WHICH MAY BE THEREON, AND THERE SHALL BE NO LIABILITY FOR DAMAGE DONE TO ANY SUCH BUILDING OR OTHER STRUCTURE BY REASON OF THE EXCAVATION, EXCEPT AS OTHERWISE PROVIDED OR ALLOWED BY LAW.



SECTION 4216/4217 OF THE GOVERNMENT CODE REQUIRES A DIGALERT IDENTIFICATION NUMBER BE ISSUED BEFORE A "PERMIT TO EXCAVATE" WILL BE VALID. FOR YOUR DIGALERY I.D. NUMBER CALL UNDERGROUND SERVICE ALERT TOLL FREE 1-800-422-4133 TWO WORKING DAYS BEFORE YOU DIG.

RETAINING WALLS ARE SHOWN FOR INFORMATION ONLY, AND ARE TO BE INSPECTED BY OTHERS UNDER A SEPARATE PERMIT

COL. & COL. JOHN REED 30122 CANYON CREEK ROAD TRABUCO CANYON, CA 92679 TEL: (949) 888-8069, (619) 861-9599

EMAIL: republicanj@yahoo.com

ARCHITECT LOHRBACH STUDIO 31742 S. COAST HIGHWAY LAGUNA BEACH, CA 92651 TEL: (949) 661-5068

LEGAL DESCRIPTION PARCAL 3, P.M.B. 12/33 TRABUCO CANYON, ORANGE COUNTY, CALIFORNIA

JOB ADDRESS 30122 CANYON CREEK DRIVE TRABUCO CANYON, CA 92679

BASIS OF BEARINGS CREEK ROAD, PER PARCEL 3,

BEING THE CENTERLINE OF CANYON P.M.B. 12/33, SHOWN HEREON AS N 19°10'36" W.

DESIGNATED 3W-47-77 ELEV. 1199.572 NAVD 88 DATUM, 1990 ADJ.

BENCH MARK ORANGE COUNTY SURVEYOR'S B.M. COUNTY OF ORANGE PLAN CHECK NO.



THESE PLANS ARE PREPARED

R.C.E. 57587 Exp. 12-31-15 UNDE B. 12/: TRABU

 \circ

50

C1

C2

SHEET INDEX

PRECISE GRADING PLAN

TITLE SHEET

CALIFORNIA CIVIL CODE (SECTION 832) (cont.)

CRACKS IN BUILDINGS OR OTHER STRUCTURES.

EXCAVATION (CUT)

EMBANKMENT (FILL)

SOIL EXPORT

GRANULAR BACKFILL (IMPORT)

CONSTRUCTION NOTES AND QUANTITY ESTIMATE

<u>EARTHWORK ESTIMATE</u> EXCLUDES BUILDING FOOTPRINT

3. IF AT ANY TIME IT APPEARS THE EXCAVATION IS TO BE OF A GREATER DEPTH THAN ARE THE WALLS OR

FOUNDATIONS OF ANY ADJOINING BUILDING OR OTHER STRUCTURE AND IS TO BE SO CLOSE AS TO ENDANGER THE

BUILDING OR OTHER STRUCTURE IN ANY WAY, THEN THE OWNER OF THE BUILDING OR OTHER STRUCTURE MUST BE

ALLOWED AT LEAST 30 DAYS IF HE SO DESIRES, IN WHICH TO TAKE MEASURES TO PROTECT THE SAME FROM ANY

DAMAGE, OR IN WHICH TO EXTEND THE FOUNDATIONS THEREOF, AND HE MUST BE GIVEN FOR THE SAME PURPOSE

4. IF THE EXCAVATION IS INTENDED TO BE OR IS DEEPER THAN THE STANDARD DEPTH OF FOUNDATIONS, WHICH DEPTH

JOINT PROPERTY LINE INTERSECTS THE CURB AND IF ON THE LAND OF THE COTERMINOUS OWNER $\,$ THERE IS ANY BUILDING OR OTHER STRUCTURE THE WALL OR FOUNDATION OF WHICH GOES TO STANDARD DEPTH OR DEEPER THAN

ENTER THE ADJOINING LAND, PROTECT THE SAID ADJOINING LAND AND ANY SUCH BUILDING OR OTHER STRUCTURE THEREON WITHOUT COST TO THE OWNER THEREOF, FROM ANY DAMAGE BY REASON OF THE EXCAVATION, AND SHALL

BE LIABLE TO THE OWNER OF SUCH PROPERTY FOR ANY SUCH DAMAGE, EXCEPTING ONLY FOR MINOR SETTLEMENT

6 CY

3 CY

0 CY

0 CY

THE OWNER OF THE LAND ON WHICH THE EXCAVATION IS BEING MADE SHALL. IF GIVEN THE NECESSARY LICENSE TO

IS DEFINED TO BE A DEPTH OF *** NINE FEET BELOW THE ADJACENT CURB LEVEL, AT THE POINT WHERE THE

REASONABLE LICENSE TO ENTER ON THE LAND ON WHICH THE EXCAVATION IS TO BE OR IS BEING MADE.

UNDER THE DIRECTION OF

SHEET C1 OF 2

15176

