GRANADOS RESIDENCE

Frank & Sandra Granados 17312 Lobdell Lane Silverado, CA. 92676



GENERAL NOTES

1. IT IS THE CLIENTS RESPONSIBILITY TO NOTIFY THE DESIGNER IN WRITING PRIOR OR DURING CONSTRUCTION OF ANY ERRORS IN THE PLANS AND SPECIFICATIONS OF WHICH A CONTRACTOR THOROUGHLY KNOWLEDGEABLE WITH THE BUILDING CODE AND METHODS OF CONSTRUCTION SHOULD REASONABLY BE AWARE. WRITTEN INSTRUCTIONS ADDRESSING SUCH ERRORS SHALL BE RECEIVED FROM THE DESIGNER PRIOR TO PROCEEDING THE WORK.

2. FIELD VERIFY EXISTING CONDITIONS AND CORRECT THEM AS NECESSARY FOR CONSTRUCTION OF THIS PROJECT AND PROTECT ALL UTILITIES FROM DAMAGE.

3. THESE PLANS ARE FOR GENERAL CONSTRUCTION PURPOSES ONLY. IT IS THE RESPONSIBILITY OF THE CONTRACTOR TO SELECT VERIFY, RESOLVE AND INSTALL ALL MATERIALS AND EQUIPMENT. THE ARCHITECT AND ENGINEER SHALL NOT BE OBSERVING THE CONSTRUCTION OF THIS PROJECT. THE CONTRACTOR IS RESPONSIBLE FOR THE CONSTRUCTION OF THIS PROJECT.

4. THERE SHALL BE NO TRENCHES OR EXCAVATIONS 5 FEETS OR MORE IN DEPTH INTO WHICH A PERSON IS REQUIRED TO DESCEND, OR OBTAIN PERMIT FROM STATE OF CALIFORNIA, DIVISION OR OCCUPATIONAL SAFETY AND HEALTH (Cal/OSHA). THIS PERMIT AND ANY OTHER SAFETY PERMIT SHALL BE OBTAINED PRIOR TO COMMENCE OF ANY WORK' CONTACT Cal/OSHA AT 714-558-4451 FOR ADDITIONAL INFORMATION.

5. PROVIDE MANDATORY MASSEURE CHECKLIST AND NOTES AS REQUIRED IN CHAPTER 4 OF THE 2019 CALIFORNIA GREEN BUILDING CODE ON PLANS.

ABBREVIATIONS

| & | AND | DBL. | DOUBLE | GA. | GAUGE | 0/ | OVER | OUT | OUEET |
|-------------|--------------------|---------|---------------------------|------------------|---------------------|---------------|-------------------------|---------------|--|
| / | ANGLE | | | | | 0/ | | SHT. | SHEET |
| _ | . , | DEPT. | DEPARTMENT | GALV. | GALVANIZED | O.A. | OVERALL | SIM. | SIMILAR |
| Ø | AT | D.F. | DRINKING FOUNTAIN | G.B. | GRAB BAR | OBS. | OBSCURE | SKYLT. | SKYLIGHT |
| <u> </u> | CENTERLINE | DET. | DETAIL | GL. | GLASS | O.C. | ON CENTER | SL. | SLOPE |
| Ø | DIAMETER OR ROUND | DIA. | DIAMETER | GND. | GROUND | O.D. | OUTSIDE DIAMETER (DIM.) | S.N.D. | SANITARY NAPKIN DISPENSER |
| • | POUND OR NUMBER | DIM. | DIMENSION | GR. | GRADE | OFF. | OFFICE | | |
| | | * | | | | | | S.N.R. | SANITARY NAPKIN RECEPTACLE |
| (E) | EXISTING | DN. | DOWN | GYP. | GYPSUM | O.H.C. | OVERHEAD CABINET | SP. | SPACE |
| | | D.O. | DOOR OPENING | GYP. BD. | GYPSUM BOARD | OPNG. | OPENING | SPEC. | SPECIFICATIONS |
| A.B. | ANCHOR BOLT | DR. | DOOR | G.B. | GYPSUM BOARD | OPP. | OPPOSITE | SQ. | SQUARE |
| ABV. | ABOVE | DS. | DOWNSPOUT | · - 1 | | | | S.SK. | SERVICE SINK |
| ACOUS. | ACOUSTICAL | D.S.P. | DRY STANDPIPE | H.B. | HOSE BIBB | DDCCT | DDECAGE | | The state of the s |
| | | | | | | PRCST. | PRECAST | S.ST. | STAINLESS STEEL |
| A.D. | AREA DRAIN | D₩ | DISHWASHER | H.C. | HOLLOW CORE | PL. | PLATE | STA. | STATION |
| ADJ. | ADJUSTABLE | DWG'S | DRAWINGS | HD₩D. | HARDWOOD | P.LAM. | PLASTIC LAMINATE | STD. | STANDARD |
| A.F.F. | ABOVE FINISH FLOOR | D₩R. | DRAWER | HDWE. | HARDWARE | PLAS. | PLASTER | STL. | STEEL |
| AGGR. | AGGREGATE | - * * * | | H.M. | HOLLOW METAL | PLYWD. | PLYWOOD | STOR. | STORAGE |
| AL. | ALUMINUM | _ | EAST | HORIZ. | HORIZONTAL | PNL. | PANEL | | |
| | | E., | | | | | | STRL. | STRUCTURAL |
| ĄLUM. | ALUMINUM | EA. | EACH | HR. | HOUR | PTD. | PAINTED | STRUCT'L | STRUCTURAL |
| | ANGLE | E.J. | EXPANSION JOINT | HGT. | HEIGHT | PLUMB. | PLUMBING | STRUCT | STRUCTURE |
| APPROX. | APPROXIMATE | | | H.V.A.C | HEATING VENTILATING | PLYWD. | PLYWOOD | SUSP. | SUSPENDED |
| ARCH. | ARCHITECT | EL. | ELEVATION | ,.,, | AIR CONDITIONING | P_ | PROPERTY LINE | SW . | SOLID WOOD |
| ARCH'L. | ARCHITECTURAL | | | HORZ | HORIZONTAL | PR. | PAIR | | |
| | | ELEC. | ELECTRICAL | | , | | | SYM. | SYMMETRICAL |
| ASPH. | ASPHALT | ELEV. | ELEVATOR | I.D. | INSIDE DIAMETER | PT. | POINT | | |
| | | EMER. | EMERGENCY | INSUL. | INSULATION | PREFAB | PREFABRICATED | T.B. | TOWEL BAR |
| | | ENCL. | ENCLOSED | INT. | INTERIOR | P.T.D. | PAPER TOWEL DISPENSER | T.C. | TOP OF CURB |
| BD. | BOARD | E.P. | ELECTRICAL PANELBOARD | | | P.T.D/R | COMBINATION PAPER TOWEL | | TELEPHONE |
| BITUM. | BITUMINOUS | | | IANI | IAAUTOD | 1.1.0/11 | | | |
| | | EQ. | EQUAL | JAN. | JANITOR | | DISPENSER & RECEPTACLE | TER. | TERRAZZO |
| BLDG. | BUILDING | EQPT. | EQUIPMENT | JT. | JOINT | PTN. | PARTITION | T.& G. | TONGUE AND GROOVE |
| BLK. | BLOCK | E.W.C. | ELECTRIC WATER COOLER | | | P.T.R. | PAPER TOWEL RECEPTACLE | THK. | THICK |
| BLKG. | BLOCKING | EXST. | EXISTING | LAB. | LABORATORY | | | T.O.C. | TOP OF CURB |
| BLT. | BOLT | EXP. | EXPANSION | LAM. | LAMINATE | | | T.O.P. | TOP OF PARAPET |
| BM. | BEAM | | | | LAVATORY | Q.T. | QUARRY TILE | | |
| * | | EXPO. | EXPOSED | LAV. | | | | T.P. | TOP OF PAVEMENT |
| ВОТ. | BOTTOM | EXT. | EXTERIOR | LKR. | LOCKER | R. | RISER | T.P.D. | TOILET PAPER DISPENSER |
| | | | | LT. | LIGHT | | | TRD. | TREAD |
| CAB. | CABINET | F.A. | FIRE ALARM | | | RAD. | RADIUS | T. V . | TELEVISION |
| C.B. | CATCH BASIN | F.B. | FLAT BAR | MAX. | MAXIMUM | R | RADIUS | T.W. | TOP OF WALL |
| CEM. | CEMENT | | | | | R.D. | ROOF DRAIN | | |
| | | F.D. | FLOOR DRAIN | M.C. | MEDICINE CABINET | REF. | REFERENCE | TYP. | TYPICAL |
| CER. | CERAMIC | FDN. | FOUNDATION | M.B. | MACHINE BOLT | REFR. | REFRIGERATOR | | |
| C.I. | CAST IRON | F.E. | FIRE EXTINGUISHER | MECH. | MECHANICAL | | | UNF. | UNFINISHED |
| C.G. | CORNER GUARD | F.E.C. | FIRE EXTINGUISHER CABINET | MEMB. | MEMBRANE | REV | REVERSE | U.O.N. | UNLESS OTHERWISE NOTED |
| CLG. | CEILING | F.F. | FINISH FLOOR | MET. | METAL | REINF | REINFORCE, REINFORCED | UR. | URINAL |
| CLKG. | CAULKING | | | | | RGTR. | REGISTER | Qn. | OUNAL |
| | | F.G. | FINISH GRADE | MFG | MANUFACTURING | REQ. | REQUIRED | | |
| CLO. | CLOSET | F.H.C. | FIRE HOSE CABINET | MFR. | MANUFACTURER | RESIL. | RESILIENT | VERT | VERTICAL |
| CLR | CLEAR | FIN. | FINISH | MH. | MANHOLE | | | VEST. | VESTIBULE |
| C.O. | CASED OPENING | FL. | FLOOR | MIN. | MINIMUM | RM. | ROOM | , -, | , -, -, -, -, |
| COL. | COLUMN | | FLASHING | MIR. | MIRROR | R.O. | ROUGH OPENING | W. | WEST |
| CONC. | CONCRETE | FLASH. | 7 1 -1 | | , | RŴD. | REDWOOD | | |
| | | FLUOR. | FLUORESCENT | MISC. | MISCELLANEOUS | R.W.L. | RAIN WATER LEADER | W / | WITH |
| CONN. | CONNECTION | F.O.C. | FACE OF CONCRETE | M.O. | MASONRY OPENING | | TOTAL ANTICK CENDER | W.C. | WATER CLOSET |
| CONSTR. | CONSTRUCTION | F.O.F. | FACE OF FINISH | MTD. | MOUNTED | | | WD. | WOOD |
| CONT. | CONTINUOUS | F.O.M. | FACE OF MULLION | MUL. | MULLION | S. | SOUTH | W.H. | WATER HEATER |
| C.O.F. | CORNER OF FINISH | | | .4.— | | S.C. | SOLID CORE | | , , , , , , , , , , , , , , , , , , , |
| CORR. | CORRIDOR | F.O.S. | FACE OF STUDS | N. | NORTH | | | Ŵ٨O | WITHOUT |
| | | FPRF. | FIREPROOF | N.I.C. | NOT IN CONTRACT | S.C.D. | SEAT COVER DISPENSER | WP. | WATERPROOF |
| CTSK. | COUNTERSUNK | FRAM'G | FRAMING | | | SCHED. | SCHEDULE | WSCT. | WAINSCOT |
| CNTR. | COUNTER | F.S. | FULL SIZE | NO. OR • | NUMBER | S.D. | SOAP DISPENSER | WT. | WEIGHT |
| CTR. | CENTER | FT. | FOOT OR FEET | NOM. | NOMINAL | SECT. | SECTION | 4 F | 4 P |
| | | | | N.T.S. | NOT TO SCALE | S.F. | SQUARE FEET | | |
| | | FTG. | FOOTING | | | | | | |
| | | FURR. | FURRING | | | SH. | SHELF | | |
| | | FUT. | FUTURE | | | SHR. | SHOWER | | |
| | | | | | | | | | |
| | | | | | | | | | |

VICINITY MAP





PROJECT DATA

CONSULTANTS

GONZALO GUILLEN 718 S. HICKORY ST.

SANTA ANA. CA 92701 (714) 227-1189

170 EAST 17TH STREET SUITE 212

(949) 497-3804

CIVIL SOIL ENGINEER:

CONSULTANT:

CODE TABULATION

2019 CALIFORNIA RESIDENTIAL CODE 2019 CALIFORNIA PLUMBING CODE 2019 CALIFORNIA MECHANICAL CODE 2019 CALIFORNIA ELECTRICAL CODE 2019 CALIFORNIA FIRE CODE 2019 CALIFORNIA ENERGY CODE

TYPE OF CONSTR.: V-B SPRINKLERED OCCUPANCY GROUP: GARAGE:

THIS PROJECT SHALL COMPLY WITH ALL OTHER REGULATIONS AND ORDINANCES ADOPTED BY THE LOCAL GOVERNING

'THIS HOUSE TO BE FIRE SPRINKLERED'

SITE INFORMATION

A.P. # 866-052-17

LEGAL DESCRIPTION

PARCEL # 17, LOT 4 OF TRACT # 10936 BLOCK BOOK 866, PAGE 05 IN THE UNINCORPORATED TERRITORY OF ORANGE COUNTY, CALIFORNIA

SHEET INDEX

SONEX ENGINEERING CONSULTANTS. INC.

COSTA MESA, CA 92627

AREA TABULATION NEW AREA: **NEW 1ST FLOOR -NEW 2ND FLOOR** • 2,179 S.F. 6,663 S.F. TOTAL NEW LIVING -NEW GARAGE -

945 S.F. **NEW FRONT PORCH** · NEW LOGGIA -212 S.F. **NEW SITTING :** 132 S.F. NEW DECK -NEW COVERED PATIO -672 S.F.

ARCHITECTURAL PLUMBING

MECHANICAL

SE Sediment Control

WE Wind Erosion Control

▼ Secondary Category

GENERAL NOTES

CAL GREEN BUILDING STANDARDS NEW PLOT PLAN W/ NEW RESIDENCE

NEW FIRST FLOOR PLAN NEW SECOND FLOOR PLAN EXTERIOR ELEVATIONS & ROOF PLAN EXTERIOR ELEVATIONS

SECTIONS

UTILITY FIRST FLOOR PLAN UTILITY SECOND FLOOR PLAN COVERED PATIO

ARCHITECTURAL DETAILS ARCHITECTURAL DETAILS

<u>CIVIL</u>

<u>T-24</u>

STRUCTURAL

ELECTRICAL

DEFERRED SUBMITTALS

THE DEFERRED SUBMITTAL ITEMS SHALL BE SUBMITTED TO THE ARCHITECT OR ENGINEER OF RECORD WHO SHALL REVIEW AND APPROVE THEM. AND FORWARD THEM TO THE BUILDING OFFICIAL WITH A NOTATION INDICATING THAT THE DEFERRED SUBMITTAL DOCUMENTS HAVE BEEN REVIEWED AND APPROVED AND THAT THEY HAVE BEEN FOUND TO BE IN GENERAL CONFORMANCE WITH THE DESIGN OF THE BUILDING. THE DEFERRED SUBMITTAL ITEMS SHALL NOT BE INSTALLED UNTIL THEIR DESIGN AND SUBMITTAL DOCUMENTS HAVE BEEN APPROVED BY THE BUILDING OFFICIAL. PROVIDE AMPLE TIME FOR THE BUILDING OFFICIAL TO REVIEW THE DOCUMENTS PER C.B.C

-ROOF TRUSSES & FIRE SPRINKLERED

NPDES NOTES

or remove sediment and other pollutants.

NATIONAL POLLUTANT DISCHARGE ELIMINATION SYSTEM (NPDES) NOTES Notes must be shown as worded, on the title sheet of the plan

1. In the case of emergency, call_____at Work Phone #____or Home Phone #____ 2. Sediment from areas disturbed by construction shall be retained on site using structural controls to the maximum

3. Stockpiles of soil shall be properly contained to minimize sediment transport from the site to streets, drainage facilities or adjacent properties via runoff, vehicle tacking, or wind.

4. Appropriate BMP's for construction-related materials, wastes, spills shall be implemented to minimize transport from the site to streets, drainage facilities, or adjoining properties by wind or runoff. 5. Runoff from equipment and vehicle washing shall be contained at construction sites unless treated to reduce

6. All construction contractor and subcontractor personnel are to be made aware or the required best management practices and good housekeeping measures for the project site and any associated construction staging areas. 7. At the end of each day of construction activity all construction debris and waste materials shall be collected and properly disposed in trash or recycle bins.

8. Construction sites shall be maintained in such a condition that an anticipated storm does not carry wastes or pollutants off the site. Discharges of material other than stormwater only when necessary for performance and completion of construction practices and where they do not: cause or contribute to a violation of any water quality standard; cause or threaten to cause pollution, contamination, or nuisance; or contain a hazardous substance in a quantity reportable under Federal Regulations 40 CFR Parts 117 and 302.

or stucco fragments; fuels, oils, lubricants, and hydraulic, radiator or battery fluids; fertilizers, vehicle/equipment wash water and concrete wash water; concrete, detergent or floatable wastes; wastes from any engine/equipment steam cleaning or chemical degreasing and superchlorinated potable water line flushing. During construction, permittee shall dispose of such materials in a specified and controlled temporary area on

9. Potential pollutants include but are not limited to: solid or liquid chemical spills; wastes from paints, stains, sealants, glues, limes, pesticides, herbicides, wood preservatives and solvents; asbestos fibers, paint flakes

-site, physically separated from potential stormwater runoff, with ultimate disposal in accordance with local, 10. Dewatering of contaminated groundwater, or discharging contaminated soils via surface erosion is prohibited.

Dewatering of non-contaminated groundwater requires a National Pollutant Discharge Elimination System Permit from the respective State Regional Water Quality Control Board. 11. Graded areas on the permitted area perimeter must drain away from the face of slopes at the conclusion of each working day. Drainage is to be directed toward desilting facilities.

12. The permittee and contractor shall be responsible and shall take necessary precautions to prevent public trespass onto areas where impounded water creates a hazardous condition. 13. The permittee and contractor shall inspect the erosion control work and insure that the work is in accordance with the approved plans.

14. The permittee shall notify all general contractors, subcontractors, material suppliers, lessees, and property owners: that dumping of chemicals into the storm drain system or the watershed is prohibited. 15. Equipment and workers for emergency work shall be made available at all times during the rainy season. Necessary materials shall be available on site and stockpiled at convenient locations to facilitate rapid construction of temporary devices when rain is imminent. 16. All removable erosion protective devices shall be in place at the end of each working day when the 5-Day Rain Probability Forecast exceeds 40%.

17. Sediments from areas disturbed by construction shall be retained on site using an effective combination of erosion and sediment controls to the maximum extent practicable, and stockpiles of soil shall be properly containted to minimize sediment transport from the site to streets, drainage facilities of adjacent properties via runoff,

18. Appropriate BMPs for construction-related materials, wastes, spills or residues shall be implemented and retained on site to minimize transport from the site to streets, drainage facilities, or adjoining property by wind or


WE Wind Erosion Control ☑ Primary Category ✓ Secondary Category


A fiber roll consists of straw, coir, or other biodegradable materials bound into a tight tubular roll wrapped by netting, which can be photodegradable or natural. Additionally, gravel core fiber rolls are available, which contain an imbedded ballast material such as gravel or sand for additional weight when staking the rolls are not feasible (such as use as inlet its flow velocity, release the runoff as sheet flow, and provide sheet and rill erosion until vegetation is established. **Suitable Applications**


protection). When fiber rolls are placed at the toe and on the Potential Alternatives By interrupting the length of a slope, fiber rolls can also reduce SE-6 Gravel Bag Berm SE-8 Sandbag Barrier Fiber rolls may be suitable: SE-14 Biofilter Bags Along the toe, top, face, and at grade breaks of exposed and erodible slopes to shorten slope length and spread runoff as

■ At the end of a downward slope where it transitions to a Along the perimeter of a project. As check dams in unlined ditches with minimal grade. Down-slope of exposed soil areas.

 At operational storm drains as a form of inlet protection. Construction www.casqa.org

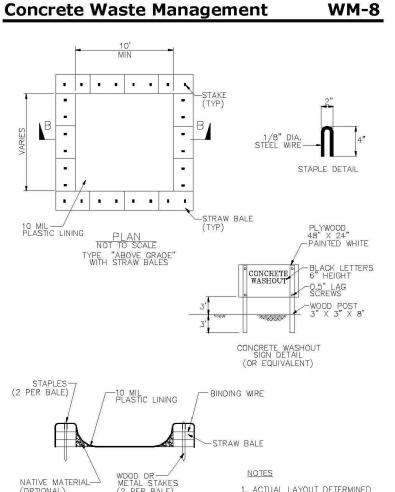


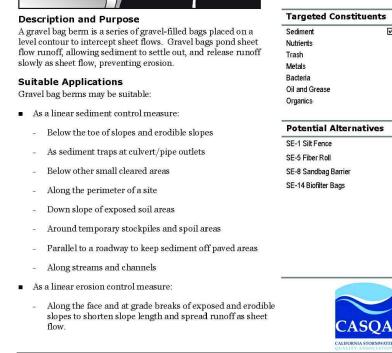

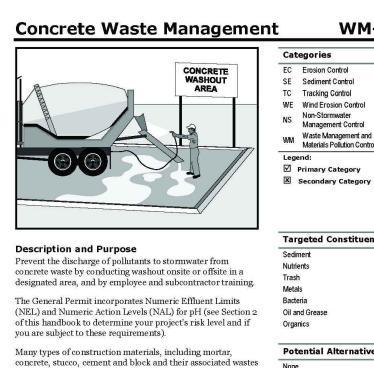

Construction www.casqa.org

concrete, stucco, cement and block and their associated wastes have basic chemical properties that can raise pH levels outside managing these materials to prevent them from coming into contact with stormwater flows and raising pH to levels outside Suitable Applications Concrete waste management procedures and practices are implemented on construction projects where: Concrete is used as a construction material or where concrete dust and debris result from demolition activities Slurries containing portland cement concrete (PCC) are generated, such as from saw cutting, coring, grinding, grooving, and hydro-concrete demolition.

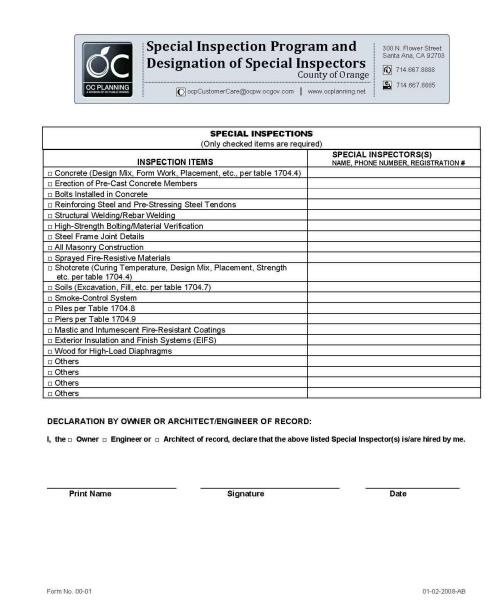



STRUCTURAL OBSERVATION (Only checked items are required) Firm or individual to be responsible for the Structural Observation: FRAME DIAPHRAGM Steel Moment Frame Concrete Footing, Stem Walls, Piers Concrete Caisson, Piles, Grade Beams Wood Concrete Moment Frame Wood pp'g/Retaining Foundation, Others: Masonry Wall Frame Others: Hillside Special Anchors

The structure is classified as Occupancy Category III or IV. The Height of the structure is greater then 75 feet (22,860 mm) above the base. The structure is assigned to Seismic Design Category E, is classified as Occupancy Category I or Π . DECLARATION BY OWNER I, the Owner of the project, declare that the above listed firm or individual

Engineer or Architect of record for the project, declare that the above listed firm or individual is designated by me to be responsible for the Structural Observation.

PLANOS

DRAFTING

GONZALO GUILLEN DESIGNER

718 S. Hickory St. Santa Ana, CA 92701 Tel. 714. 667.0892 Cell 714. 227.1189 Email: gplanos@sbcglobal.ne

Job Number: 07/2019

Drawn By: GONZALO


Checked By GONZALO

No. Date: Description:

As Shown:

 Design Drawings Construction Drawings

Sheet Title: TITLE SHEET

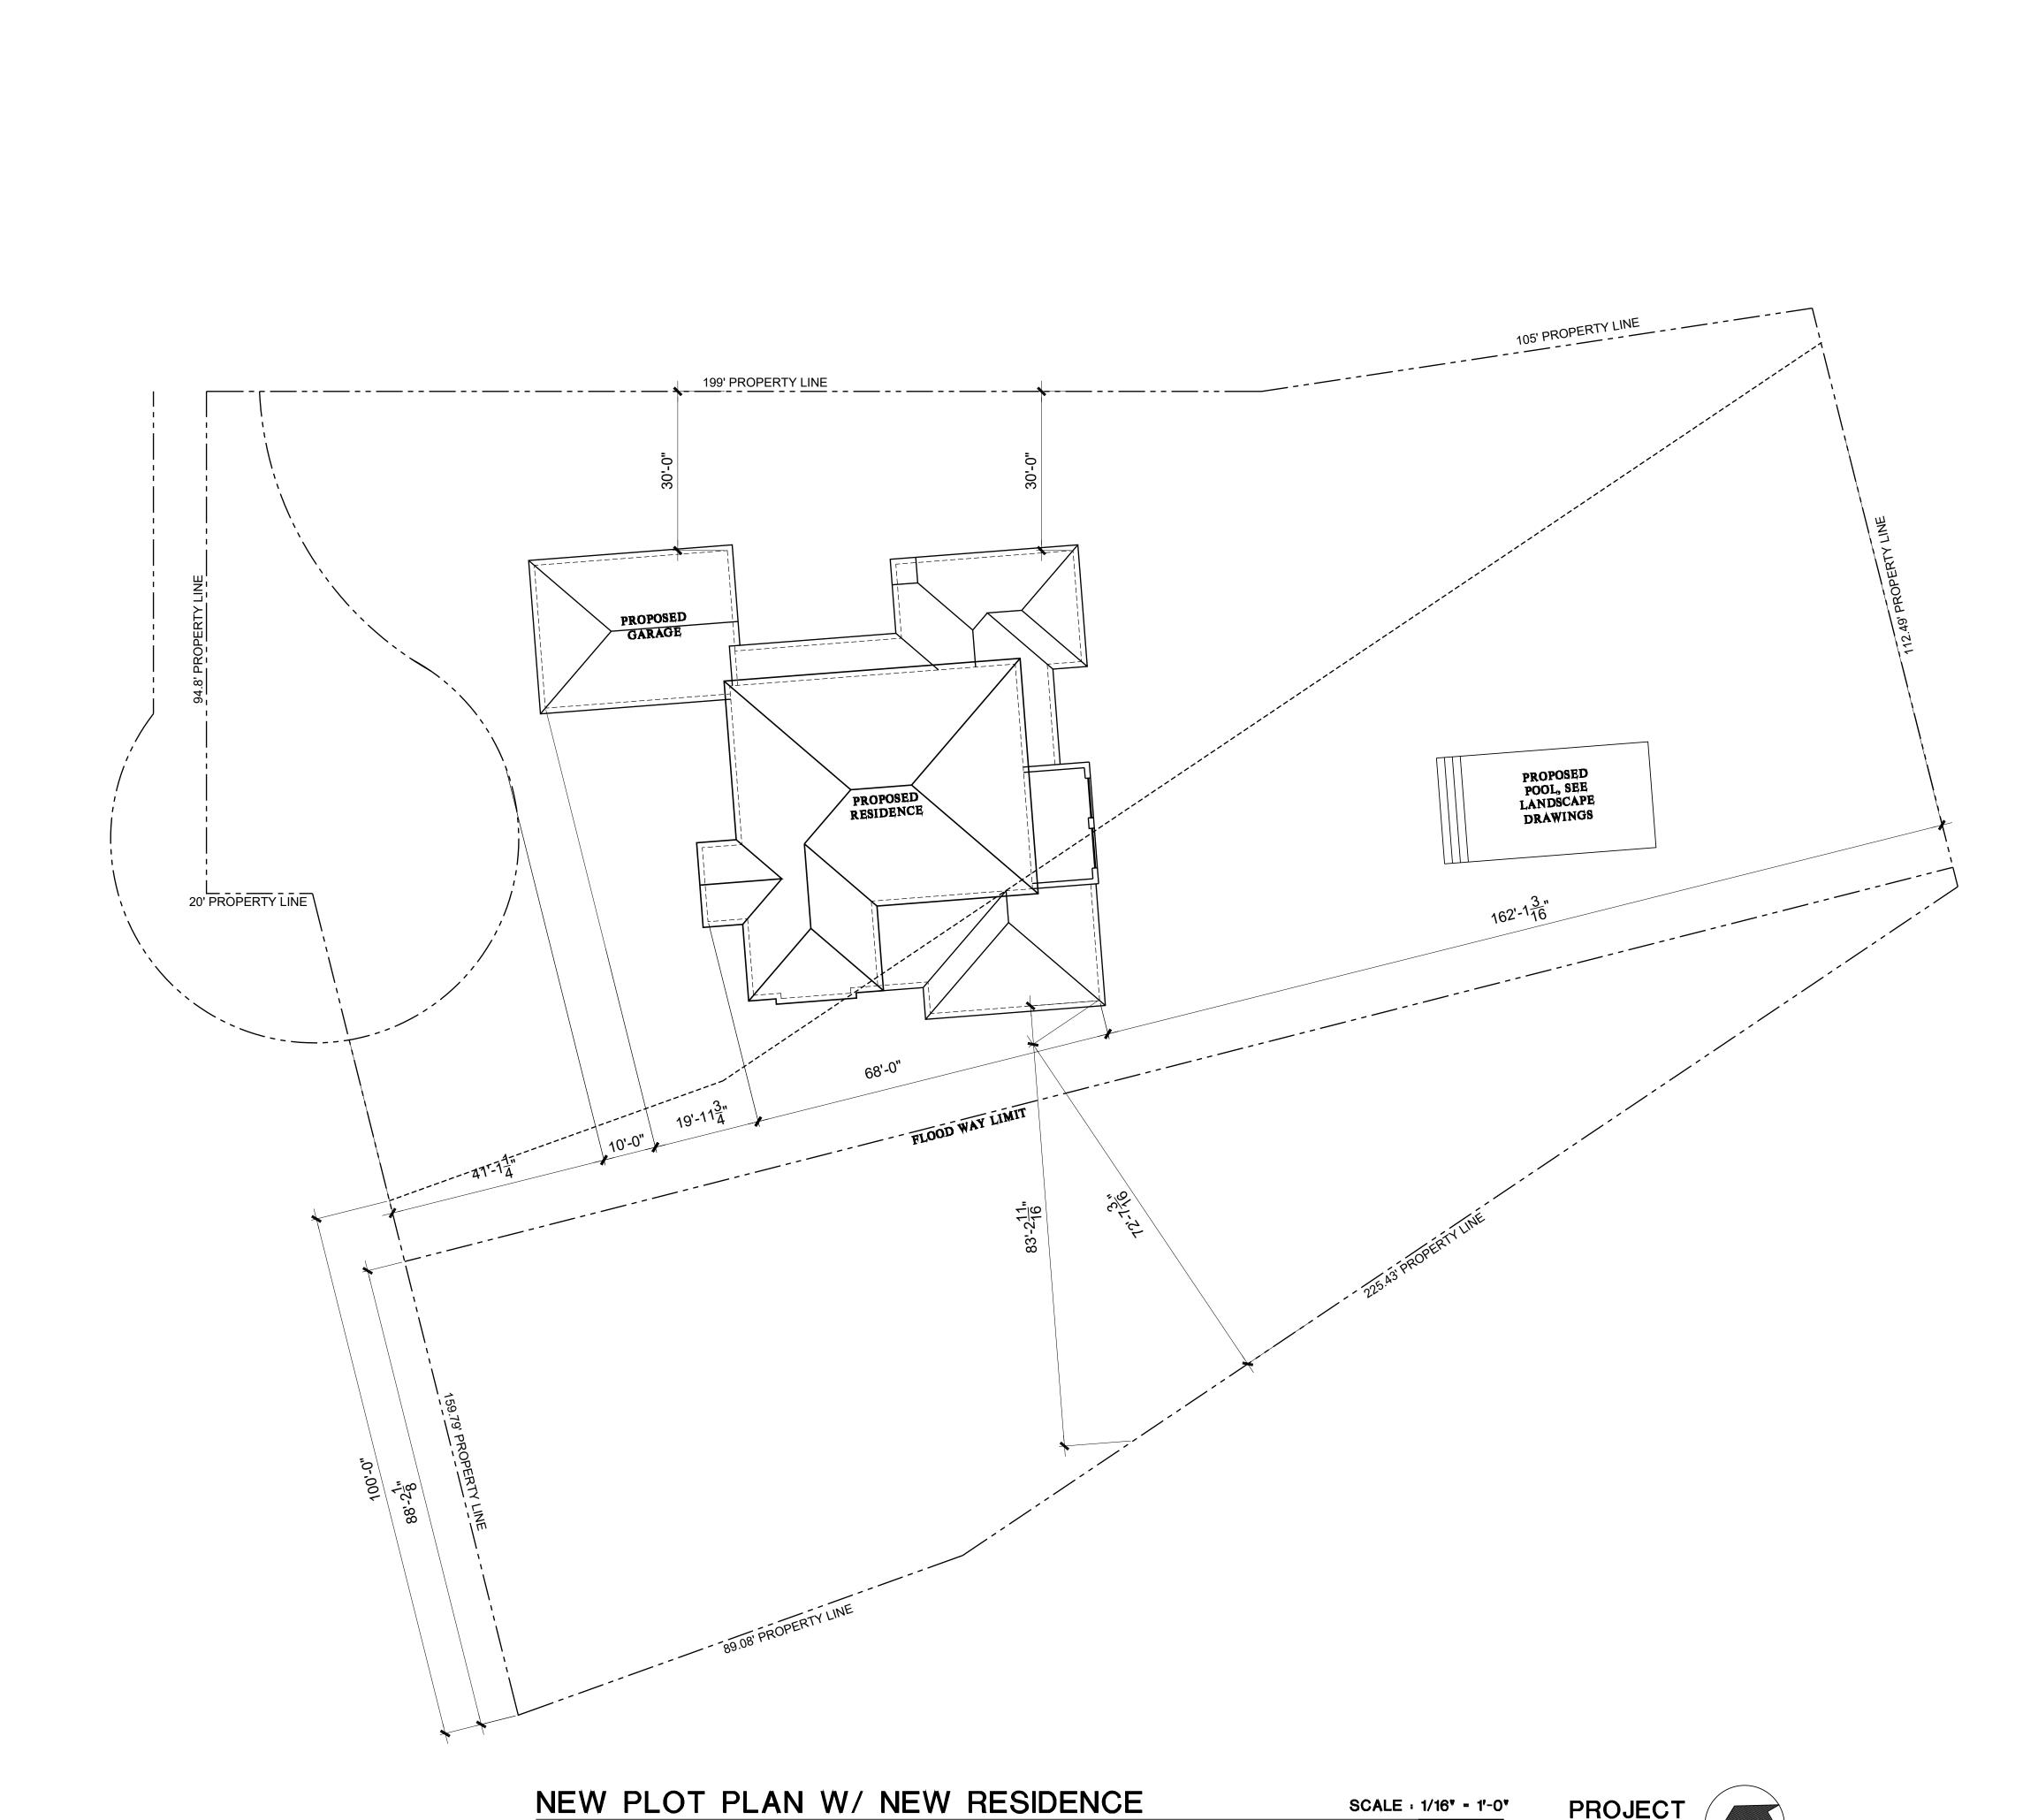

SCALE : 1/16" = 1'-0"

PROJECT NORTH



SITE NOTES

1. FIELD VERIFY EXISTING CONDITIONS AND CORRECT THEM AS NECESSARY FOR CONSTRUCTION OF THIS PROJECT AND PROTECT ALL UTILITIES FROM DAMAGE.

2. SALVAGE ALL EXISTING MATERIAL PER OWNER'S DIRECTION.

3. REFER TO CIVIL ENGINEER'S DRAWINGS FOR ADDITIONAL DIMENSIONS AND INFORMATION REGARDING CURBS, GUTTERS PAVING, ETC.

4. REFER TO GEOTECHNICAL REPORT FOR GRADING AND BACKFILL REQUIREMENTS.

5. REFER TO FLOOR PLANS FOR ADDITIONAL INFORMATION.

6. ARCHITECTURAL SITE PLAN IS NOT FOR CONSTRUCTION.

LEGEND

SYMBOL DESCRIPTION PROPERTY LINE

PLANOS

DRAFTING

GONZALO GUILLEN DESIGNER

718 S. Hickory St. Santa Ana, CA 92701

Tel. 714. 667.0892 Cell 714. 227.1189

Email: gplanos@sbcglobal.net

Job Number: 07/2019

Drawn By: GONZALO

Checked By GONZALO

No. Date: Description:


02/10/2020


As Shown:

Design Drawings Construction Drawings

Sheet Title:
PLOT PLAN

PP

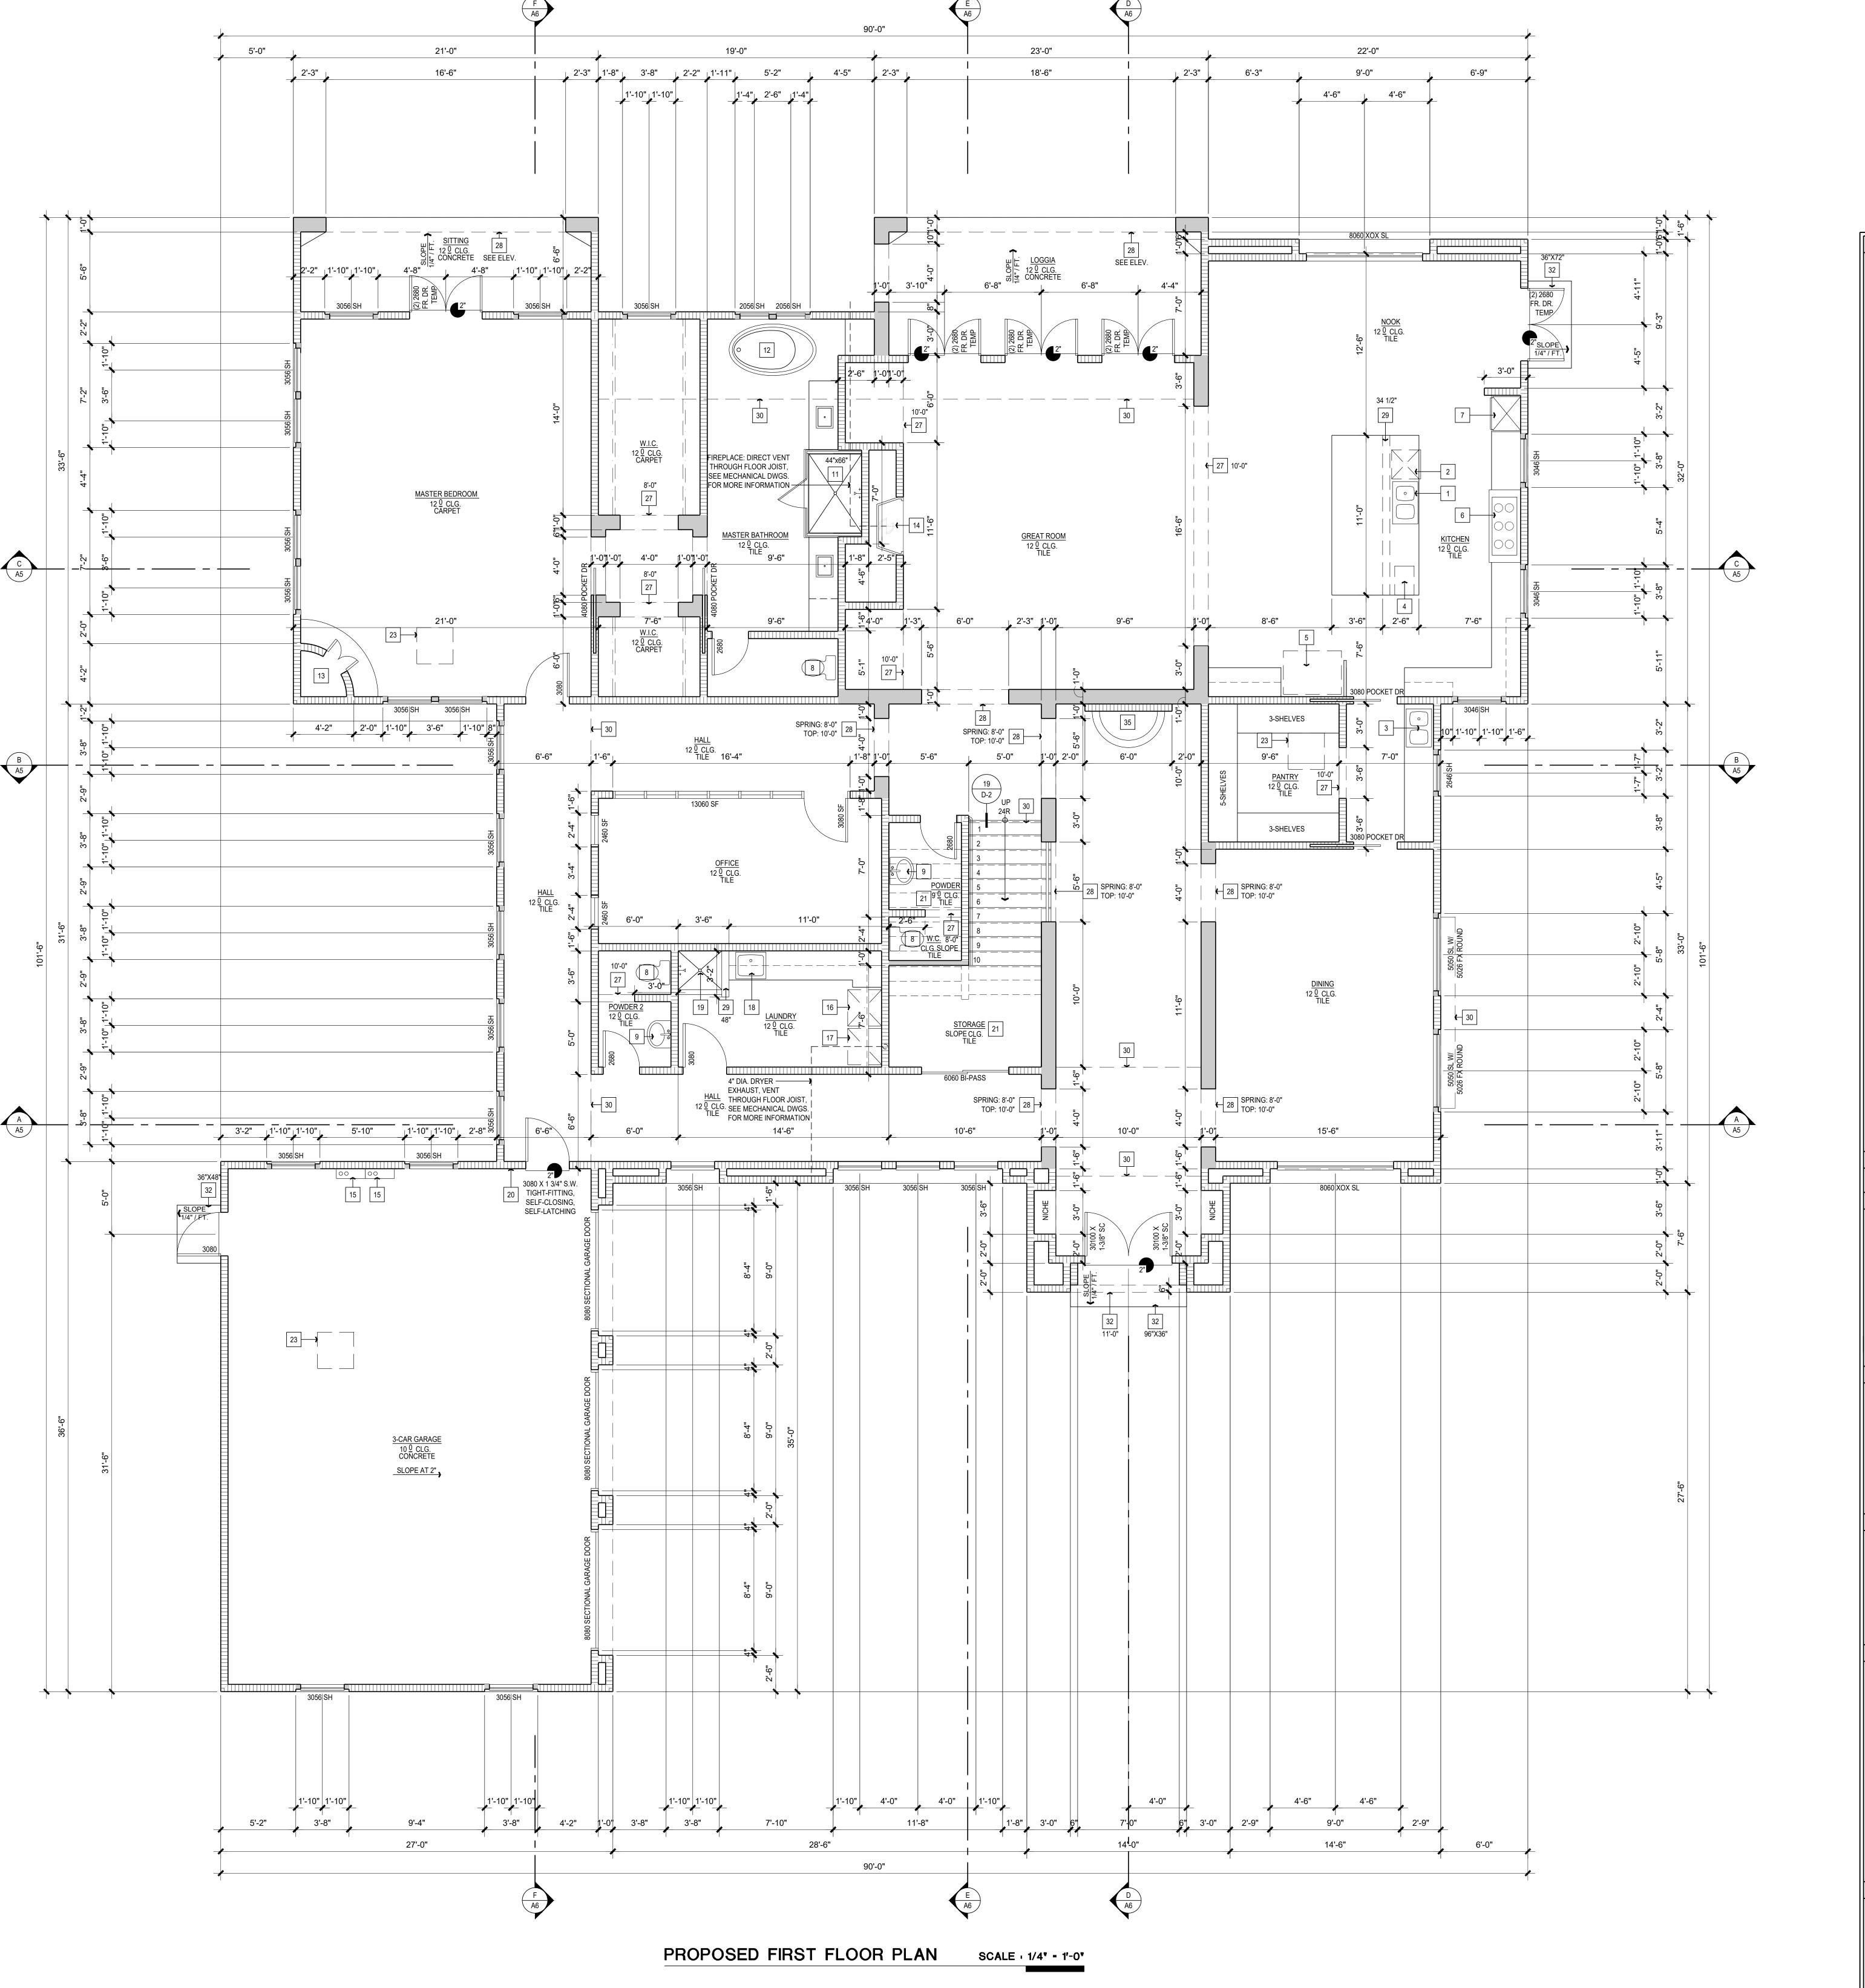

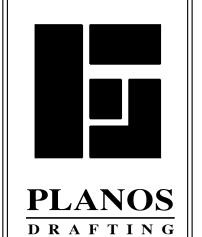

 Design Drawings Construction Drawings

718 S. Hickory St.

Santa Ana, CA 92701

Tel. 714. 667.0892

Cell 714. 227.1189

Email: gplanos@sbcglobal.net

Job Number: 07/2019

Drawn By: GONZALO

Checked By GONZALO

No. Date: Description:

Scale:

02/10/2020

As Shown:

GONZALO GUILLEN DESIGNER

DOUBLE SINK WITH GARBAGE DISPOSAL W/ AIR GAP FOR DISHWASHER DISHWASHER (24" WIDE X 24" DEEP W/ AIR GAP)

VERIFY DIMENSIONS WITH MANUFACTURER. 3 DOUBLE SINK

4 UNDER COUNTER MICROWAVE PER OWNER'S SPEC. 52" CLEAR REFRIGERATOR SPACE (PROVIDE RECESSED COLD WATER BIB AND SHUT-OFF FOR ICE-MAKER)

PER OWNER'S SPECIFICATIONS 6 RANGE PER OWNER'S SPECIFICATIONS

7 OVEN PER OWNER'S SPEC.

WATER CLOSETS-PROVIDE A MIN. 30" CLR. SPACE PER PLAN AND MAX. OF 1.6 GALLONS PER FLUSH

9 PEDESTAL SINK

SHWR UNIT W/ TEMP. GLASS ENCLOSURE DOOR AND PANELS MUST BE LABELED CATEGORY II. WALL COVERING SHALL BE CEMENT PLASTER TILE OR APPROVED EQUAL TO 72" ABOVE DRAIN. PROVIDE ANTI-SCALDING VALVE.

HOT MOP SHOWER, SEE FLOOR PLAN FOR SIZE. WALL COVERING SHALL BE CEMENT PLASTER TILE OR APPROVED EQUAL TO 72" ABOVE DRAIN. PROVIDE ANTI-SCALDING VALVE. PER CPC CODE

12 FREE STANDING TUB PER OWNER'S SPECS.

FIREPLACE: FACTORY BUILT DIRECT VENT, 12" DUCT THROUGH ROOF. FIREPLACE, INSTALL PER MAFR. SPEC AND CODE FIREPLACE 48X24: FACTORY BUILT 48" DIRECT VENT, 12" DUCT THROUGH

ROOF. DECORATIVE GAS HEATILATOR MANUFACTURER, UL # HTL-1014U-0311 OR EQUAL PROVIDE HEART PER MANUFACTURES SPECIFICATION AND PER CODE

TANKLESS WATER HEATER (TWH) PER THE C.P.C. SEE SPECIFICATIONS & DETAIL 20/D-1 WASHER SPACE : PROVIDE RECESSED WATER AND DRAIN CONNECTIONS. (RECESSED BOX IN GARAGE

FIREWALL SHALL BE METAL). AT SECOND FLOOR WASHER PROVIDE "SMITTY" PAN & 2" DRAIN TO OUTSIDE

DRYER SPACE : PROVIDE SMOOTH METAL DRYER VENT DUCT TO OUTSIDE WITH BACKDRAFT DAMPER PER CODE 5" DIA 14' MAX. LENGTH WITH 2 ELBOWS MAX.

18 LAUNDRY SINK

19 36"X36" DOG SHOWER PAN PER OWNERS SPECS

[20] THE GARAGE SHALL BE SEPARATED FROM THE RESIDENCE AND ITS ATTIC BY NOT LESS THAN 1/2" GYPSUM BOARD APPLIED TO THE GARAGE SIDE. GARAGES BENEATH HABITABLE ROOMS SHALL BE SEPARATED FROM ALL HABITABLE ROOMS ABOVE BY NOT LESS THAN 5/8" TYPE (X) GYPSUM BOARD OR EQUIVALENT. WHERE THE SEPARATION IS A FLOOR-CEILING ASSEMBLY, THE STRUCTURE

SUPPORTING THE SEPARATION SHALL ALSO BE PROTECTED BY NOT LESS THAN 1/2" GYPSUM BOARD OR EQUIVALENT PER CRC TABLE R302.6. - MINIMUM CLEAR UNOBSTRUCTED GARAGE AREA OF 10'-0" X 20'-0" & 7'-0" IN HEIGHT. "NO AFFIXED OBSTRUCTIONS SUCH AS, BUT NOT LIMITED TO WATER HEATERS, WASHERS AND DRYERS, SINKS, AND FURNACES SHALL INTRUDE INTO

THESE DESIGNATED PARKING AREAS. THE MEASUREMENT SHALL BE FROM THE FACE OF THE INTERIOR WALLS NOT INCLUDING STRUCTURE SUPPORT." 1/2" GYP. BOARD AT WALLS AND CEILING AT ENCLOSED USABLE SPACE UNDER

STAIRS PER CRC R302.7. F.A.U. ON MIN 24" HIGH PLATFORM: SWITCHED LIGHT, 110 V OUTLET, COMBUSTION AIR, CONDENSATE DRAIN LINE AND VENT TO OUTSIDE AIR PER

C.M.C. SECTION 307.3 AND CHAPTER 7. SEE SPECIFICATIONS & DETAIL 26/D-1 [23] 30" X 30" ATTIC ACCESS MIN. WITH 30" MIN CLEAR HEADROOM PROVIDED FAU MAY PASS THROUGH PER THE IRC. PROVIDE SWITCH LIGHT, 110 V OUTLET AND 24" PLATFORM TO

FAU. SEE DETAIL 22/D-1 24 +42" GUARDRAIL UNLESS OTHERWISE NOTED.

25 +42" TUBE STEEL OPEN RAIL/GUARDRAIL UNLESS OTHERWISE NOTED

26 +36" HANDRAIL/GUARDRAIL UNLESS OTHERWISE NOTED

27 FLAT SOFFIT - REFER TO PLAN FOR HEIGHT 28 ARCHED SOFFIT - REFER TO PLAN FOR HEIGHT

29 LOW WALL - REFER TO PLAN FOR HEIGHT

30 LINE OF FLOOR/WALL ABOVE 31 LINE OF WALL BELOW

GARAGE PER C.R.C.

32 CONCRETE LANDING; REFER TO FLOOR PLAN FOR SIZE

[33] DECK COATING, SLOPE 1/4" PER FOOT. ENDURO-KOTE ELASTOMERIC DECK COATING OR APPROVED EQUAL ESR-2245 AC CONDENSER UNIT ON CONCRETE PAD 3" ABOVE GRADE. PROVIDE 220V

WATERPROOF OUTLET W/ DISCONNECT AND 110V WATERPROOF OUTLET WITHIN 25' OF AC UNIT. SEE SPECIFICATIONS AND MANUFACTURER'S SPEC'S.

35 WATER FOUNTAIN PER OWNERS SPECS.

36 72" X 96" SKYLIGHT - PER OWNER'S SPEC. SEE DETAIL 23/D-1. ICC -ESR-2415

WALL LEGEND

2X4 STUDS AT 16" o.c. U.N.O.

2X6 STUDS AT 16" o.c. U.N.O. OCCUPANCY SEPARATION

ONE HOUR FIRE RATED (U / R-3) VERTICAL OCCUPANCY SEPARATION BETWEEN HOUSE & GARAGE. PROVIDE 1 LAYER 5/8" TYPE 'X' GYPSUM BOARD AT GARAGE SIDE OF WALLS

FROM THE SLAB THRU THE ATTIC TO THE ROOF SHEATING & FRAMING SUPPORTING FLOORS ABOVE PER C.R.C.

ONE HOUR FIRE RATED (U / R-3) HORIZONTAL OCCUPANCY SEPARATION BETWEEN HOUSE AND GARAGE. PROVIDE 2 LAYERS 5/8" TYPE 'X' GYPSUM BOARD AT CEILING OF

PROVIDE 1 LAYER 5/8" TYPE 'X' GYP. BOARD @ WALL/CLG. OF ACCESSIBLE AREAS UNDER

DUCTS PENETRATING WALL OR CEILING SEPARATIONS BETWEEN A GARAGE AND A

DWELLING UNIT SHALL BE CONSTRUCTED OF MINIMUM 26 GAGE SHEET METAL AND

SHALL HAVE NO OPENINGS INTO THE GARAGE. PER C.R.C.

DRYER VENT

DRYER VENT DUCTS SHALL COMPLY WITH CMC SECTION 504: 1. MOISTURE EXHAUST DUCTS SHALL TERMINATE ON THE OUTSIDE OF THE 2. BE EQUIPPED WITH A BACKDRAFT DAMPER (PENETRATIONS THROUGH A FIRE

WALL SHALL BE FIRE STOPPED APPROPRIATE TO THE FIRE RATING OF THE WALL BEING PENETRATED). 3. VENTS SHALL BE A MIN. 4 INCHES IN DIAMETER & CONSTRUCTED OF METAL W/

SMOOTH INTERIOR SURFACES. 4. UNLESS OTHERWISE PERMITTED, MOISTURE EXHAUST DUCTS SHALL NOT EXCEED A TOTAL COMBINED LENGTH OF 14 FEET INCLUDING TWO 90 DEG. ELBOWS.

5. LONGER RUNS OR RUNS WITH MORE THAN 2 ELBOWS MUST USE AN APPROVED BOOSTER FAN LOCATED AT A POINT NO CLOSER THAN 14'-0" FROM THE DRYER. 6. THE TERMINATION POINT SHALL NOT BE LESS THAN 3'-0" FROM A PROPERTY LINE

OR OPENING INTO THE BUILDING. EMERGENCY BEDROOM EGRESS

EXTERIOR WINDOWS DESIGNATED FOR EMERGENCY EGRESS & RESCUE SHALL BE LABELED WITH AN SYMBOL (EACH SLEEPING ROOM SHALL HAVE AT LEAST ONE).

ALL EMERGENCY EGRESS OPENINGS SHALL COMPLY WITH CRC CODE: 1. ESCAPE & RESCUE WINDOWS SHALL HAVE A MIN. NET CLEAR OPENABLE AREA OF 5.7

2. THE MIN. NET CLEAR OPENABLE HEIGHT DIMENSION SHALL BE 24 INCHES.

3. THE MIN. NET CLEAR OPENABLE WIDTH DIMENSION SHALL BE 20 INCHES. 4. FINISHED SILL HEIGHT SHALL NOT BE MORE THAN 44 INCHES ABOVE THE FLOOR.

5. THE EMERGENCY DOOR OR WINDOW SHALL BE OPERABLE FROM THE INSIDE TO PROVIDE A FULL, CLEAR OPENING WITHOUT THE USE OF SEPARATE TOOLS. 6. SEE DETAIL 21/D-2

FIBER-REINFORCED GYPSUM BACKERS SHALL BE USED AS A BASE FOR WALL TILE IN TUB AND SHOWER AREAS AND WALL AND CEILING PANELS IN SHOWER AREA PER CRC. 2. A MINIMUM 26 GA. CORROSION-RESISTANT OR PLASTIC WEEP SCREED WITH A

MINIMUM VERTICAL FLANGE OF 3 ½" SHALL BE PROVIDED AT OR BELOW FOUNDATION PLATE LINE ON EXTERIOR STUD WALLS. SCREED SHALL BE A MINIMUM OF 6" ABOVE

EARTH OR 2" ABOVE PAVED AREAS, PER CRC. 3. PROVIDE A MINIMUM 1" BUILDING WATER SUPPLY FOR EACH SINGLE FAMILY DWELLING, PER CPC.

4. CONDENSATE LINES FROM MECHANICAL EQUIPMENT SHALL DISCHARGE TO A PLUMBING FIXTURE OR STORM DRAIN BY MEANS OF AN INDIRECT WASTE PIPE. CONDENSATE LINES SHALL NOT TERMINATE IN LANDSCAPE OR YARD AREAS PER CMC. 5. ALL GARAGE DOORS SHALL BE PROVIDED WITH A U.L. LISTED AUTOMATIC

GARAGE DOOR OPENER. 6. TYPICAL 6" CLEAR FROM DOOR TO PERPENDICULAR WALL. 7. ALL EXTERIOR DOORS OF CONDITIONED SPACES SHALL BE FULLY


WEATHERSTRIPPED.


8. WATERCLOSETS TO BE MAXIMUM 1.28 GALLONS PER FLUSH PER CGBSC TABLE 4.303.2 9. SPECIFY GLAZING MATERIAL SHALL BE FULLY TEMPERED, HEAT-STRENGTHENED, WIRED, APPROVED RIGID PLASTIC, OR LAMINATED IN

ACCORDANCE WITH CRC R308.6.2 10. IRRIGATION CONTROLLERS MUST BE WEATHER (RAIN SENSOR) OR SOIL MOISTURE BASED CONTROLLERS.

FIRST FLOOR PLAN 2179 SQ. FT. SECOND FLOOR PLAN TOTAL LIVING 6663 SQ. FT. 945 SQ. FT. FRONT PORCH 18 SQ. FT. 212 SQ. FT. SITTING 132 SQ. FT. DECK 288 SQ. FT.

Sheet Title: **PROPOSED** FIRST FLOOR PLAN Sheet No.:

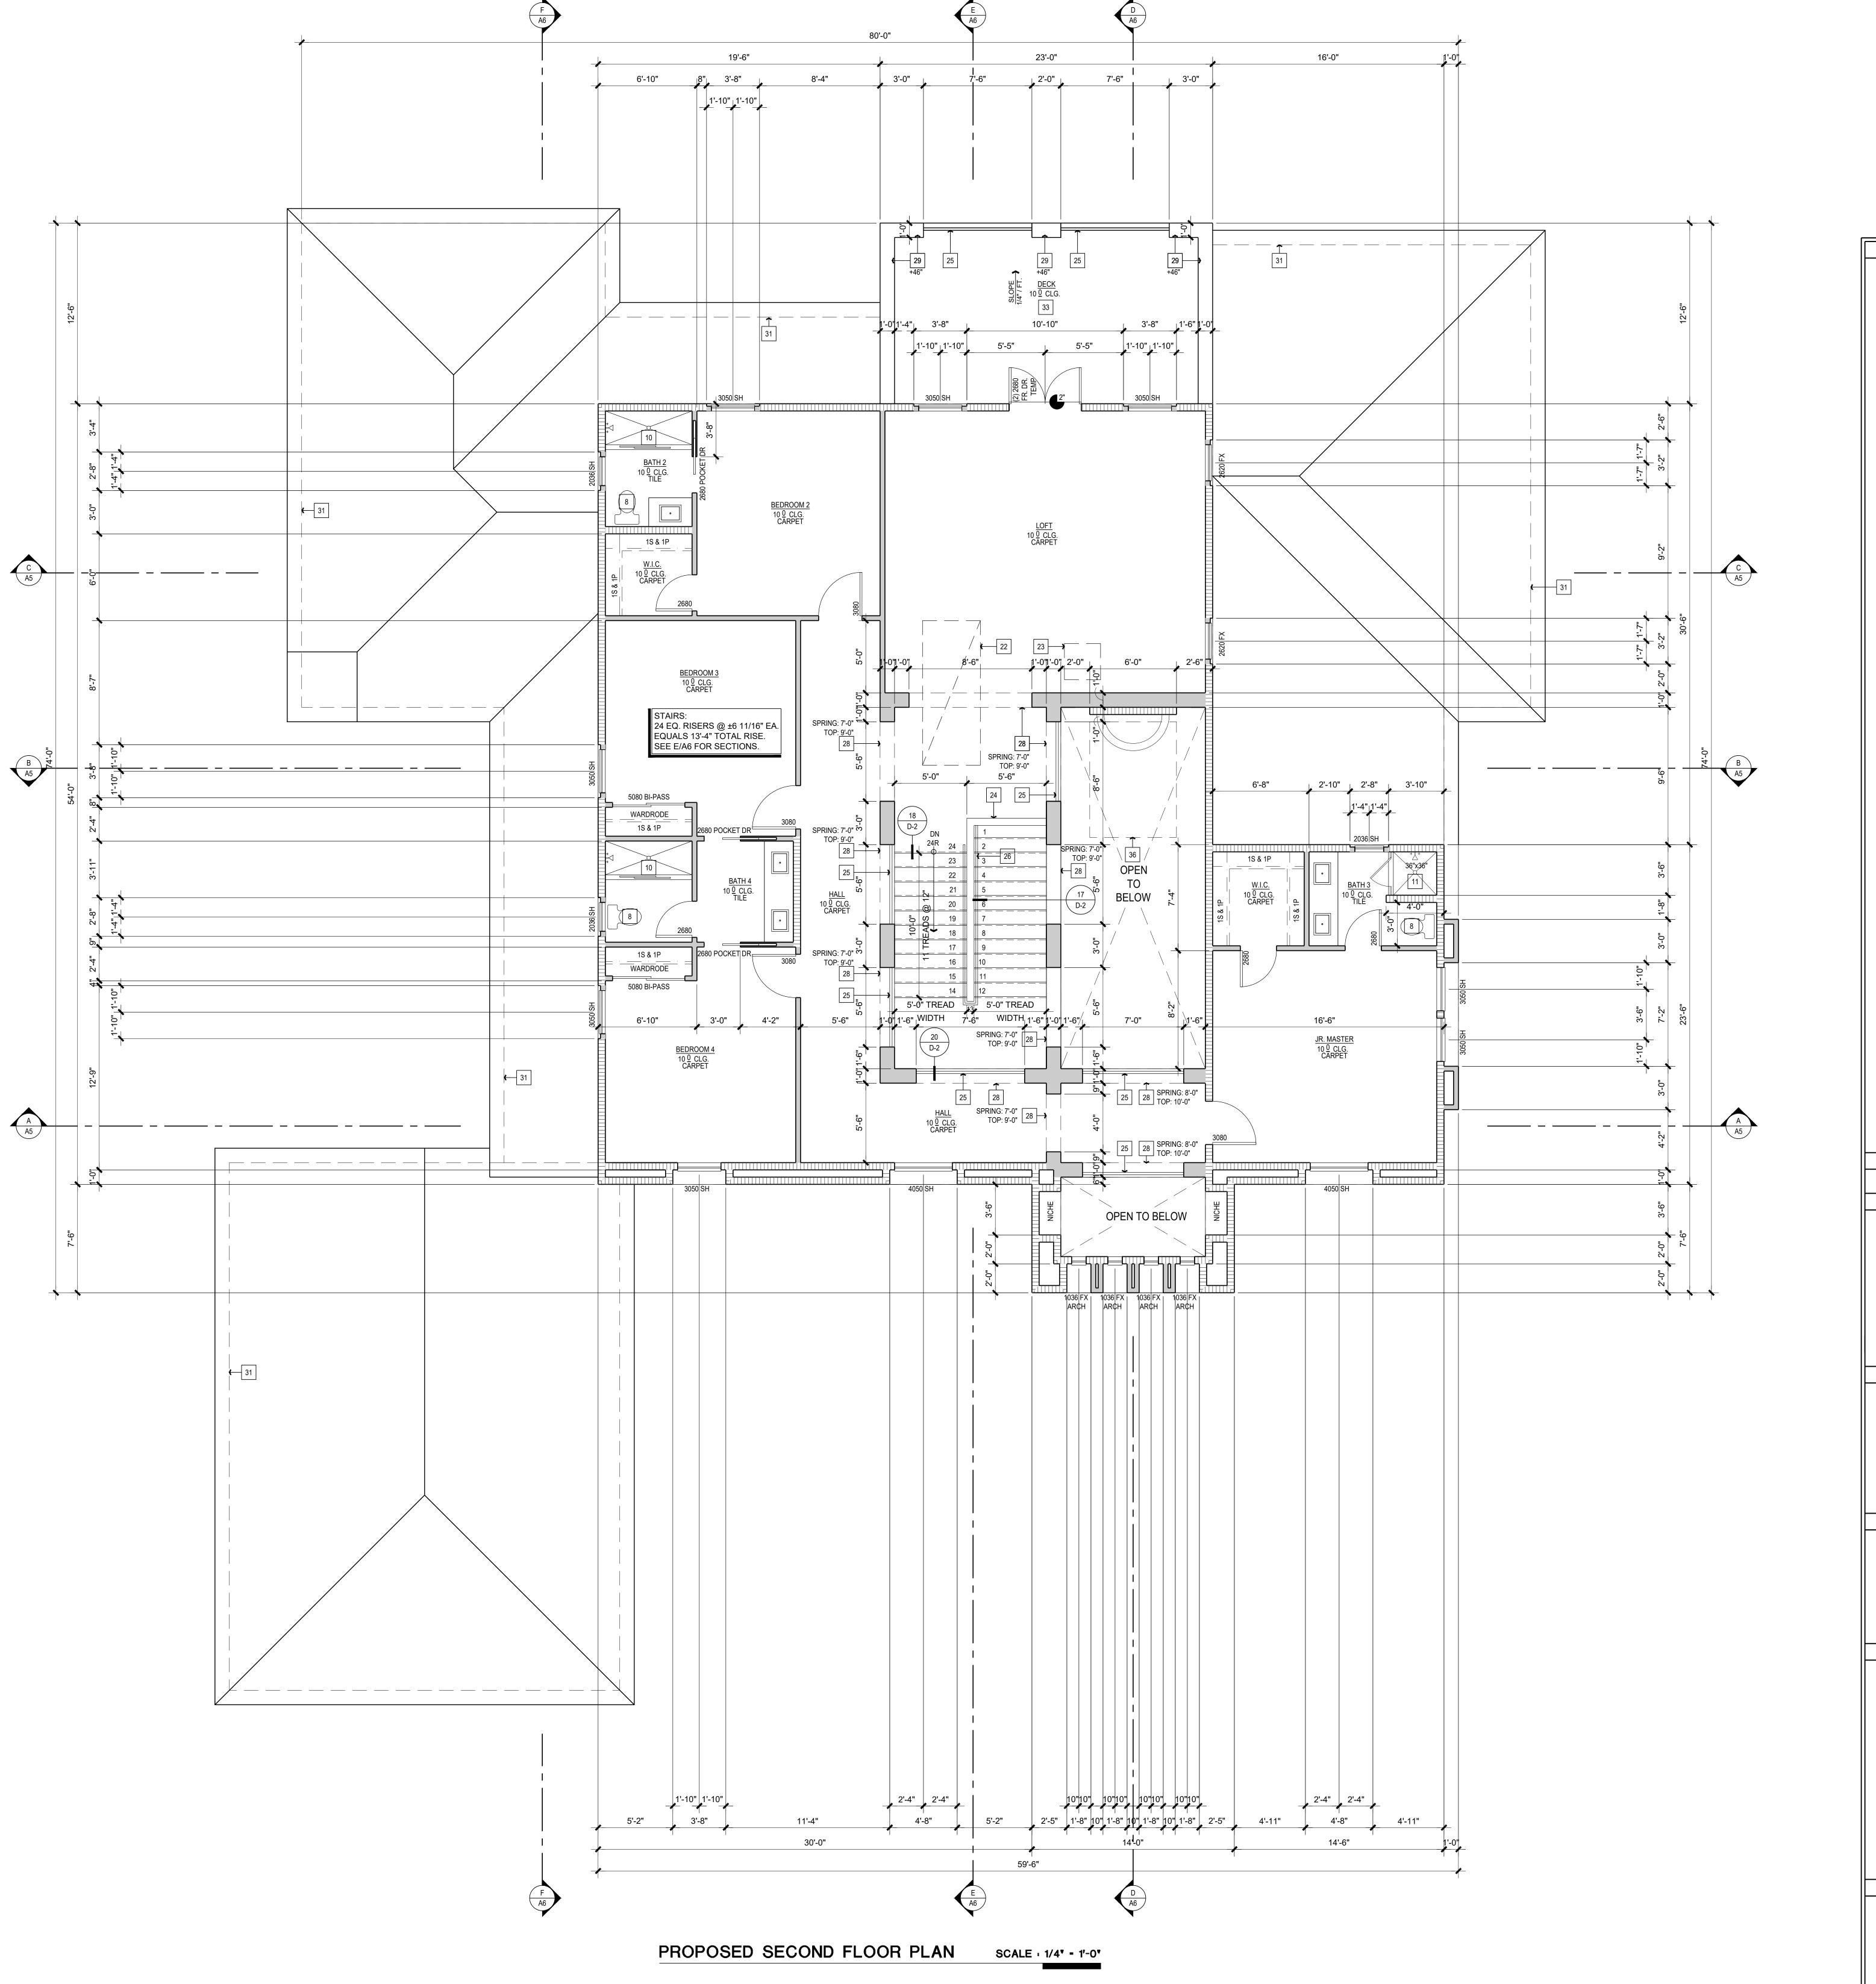

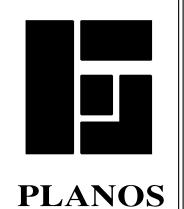

DRAFTING Design Drawings

Construction Drawings

GONZALO GUILLEN DESIGNER

718 S. Hickory St.

Santa Ana, CA 92701

Tel. 714. 667.0892

Cell 714. 227.1189

Email: gplanos@sbcglobal.net

Job Number: 07/2019

Drawn By: GONZALO

Checked By GONZALO

No. Date: Description:

Scale:

02/10/2020

As Shown:

DOUBLE SINK WITH GARBAGE DISPOSAL

── W/ AIR GAP FOR DISHWASHER DISHWASHER (24" WIDE X 24" DEEP W/ AIR GAP) VERIFY DIMENSIONS WITH MANUFACTURER.

3 DOUBLE SINK

4 UNDER COUNTER MICROWAVE PER OWNER'S SPEC. 52" CLEAR REFRIGERATOR SPACE (PROVIDE RECESSED

COLD WATER BIB AND SHUT-OFF FOR ICE-MAKER) PER OWNER'S SPECIFICATIONS

6 RANGE PER OWNER'S SPECIFICATIONS

7 OVEN PER OWNER'S SPEC. 8 WATER CLOSETS-PROVIDE A MIN. 30" CLR. SPACE

PER PLAN AND MAX. OF 1.6 GALLONS PER FLUSH 9 PEDESTAL SINK

SHWR UNIT W/ TEMP. GLASS ENCLOSURE DOOR AND PANELS MUST BE LABELED CATEGORY II. WALL COVERING SHALL BE CEMENT PLASTER TILE OR APPROVED EQUAL TO 72" ABOVE DRAIN. PROVIDE ANTI-SCALDING VALVE.

HOT MOP SHOWER, SEE FLOOR PLAN FOR SIZE. WALL COVERING SHALL BE CEMENT PLASTER TILE OR APPROVED EQUAL TO 72" ABOVE DRAIN. PROVIDE ANTI-SCALDING VALVE. PER CPC CODE

12 FREE STANDING TUB PER OWNER'S SPECS.

FIREPLACE: FACTORY BUILT DIRECT VENT, 12" DUCT THROUGH ROOF. FIREPLACE, INSTALL PER MAFR. SPEC AND CODE

FIREPLACE 48X24: FACTORY BUILT 48" DIRECT VENT, 12" DUCT THROUGH ROOF. DECORATIVE GAS HEATILATOR MANUFACTURER, UL # HTL-1014U-0311 OR EQUAL PROVIDE HEART PER MANUFACTURES SPECIFICATION AND PER CODE

TANKLESS WATER HEATER (TWH) PER THE C.P.C. SEE SPECIFICATIONS & DETAIL 20/D-1 WASHER SPACE : PROVIDE RECESSED WATER AND

DRAIN CONNECTIONS. (RECESSED BOX IN GARAGE FIREWALL SHALL BE METAL). AT SECOND FLOOR WASHER

PROVIDE "SMITTY" PAN & 2" DRAIN TO OUTSIDE DRYER SPACE : PROVIDE SMOOTH METAL DRYER VENT

DUCT TO OUTSIDE WITH BACKDRAFT DAMPER PER CODE 5" DIA 14' MAX. LENGTH WITH 2 ELBOWS MAX. 18 LAUNDRY SINK

19 36"X36" DOG SHOWER PAN PER OWNERS SPECS

[20] THE GARAGE SHALL BE SEPARATED FROM THE RESIDENCE AND ITS ATTIC BY NOT LESS THAN 1/2" GYPSUM BOARD APPLIED TO THE GARAGE SIDE. GARAGES BENEATH HABITABLE ROOMS SHALL BE SEPARATED FROM ALL HABITABLE ROOMS ABOVE BY NOT LESS THAN 5/8" TYPE (X) GYPSUM BOARD OR EQUIVALENT.

WHERE THE SEPARATION IS A FLOOR-CEILING ASSEMBLY, THE STRUCTURE

SUPPORTING THE SEPARATION SHALL ALSO BE PROTECTED BY NOT LESS THAN 1/2" GYPSUM BOARD OR EQUIVALENT PER CRC TABLE R302.6. - MINIMUM CLEAR UNOBSTRUCTED GARAGE AREA OF 10'-0" X 20'-0" & 7'-0" IN HEIGHT. "NO AFFIXED OBSTRUCTIONS SUCH AS, BUT NOT LIMITED TO WATER HEATERS, WASHERS AND DRYERS, SINKS, AND FURNACES SHALL INTRUDE INTO

THESE DESIGNATED PARKING AREAS. THE MEASUREMENT SHALL BE FROM THE FACE OF THE INTERIOR WALLS NOT INCLUDING STRUCTURE SUPPORT." 21 1/2" GYP. BOARD AT WALLS AND CEILING AT ENCLOSED USABLE SPACE UNDER STAIRS PER CRC R302.7.

F.A.U. ON MIN 24" HIGH PLATFORM: SWITCHED LIGHT, 110 V OUTLET, COMBUSTION AIR, CONDENSATE DRAIN LINE AND VENT TO OUTSIDE AIR PER C.M.C. SECTION 307.3 AND CHAPTER 7. SEE SPECIFICATIONS & DETAIL 26/D-1

[23] 30" X 30" ATTIC ACCESS MIN. WITH 30" MIN CLEAR HEADROOM PROVIDED FAU MAY PASS THROUGH PER THE IRC. PROVIDE SWITCH LIGHT, 110 V OUTLET AND 24" PLATFORM TO FAU. SEE DETAIL 22/D-1

24 +42" GUARDRAIL UNLESS OTHERWISE NOTED.

25 +42" TUBE STEEL OPEN RAIL/GUARDRAIL UNLESS OTHERWISE NOTED | 26 | +36" HANDRAIL/GUARDRAIL UNLESS OTHERWISE NOTED

27 FLAT SOFFIT - REFER TO PLAN FOR HEIGHT

28 ARCHED SOFFIT - REFER TO PLAN FOR HEIGHT 29 LOW WALL - REFER TO PLAN FOR HEIGHT

30 LINE OF FLOOR/WALL ABOVE

GARAGE PER C.R.C.

31 LINE OF WALL BELOW

32 CONCRETE LANDING; REFER TO FLOOR PLAN FOR SIZE [33] DECK COATING, SLOPE 1/4" PER FOOT. ENDURO-KOTE ELASTOMERIC DECK

COATING OR APPROVED EQUAL ESR-2245 AC CONDENSER UNIT ON CONCRETE PAD 3" ABOVE GRADE. PROVIDE 220V

WATERPROOF OUTLET W/ DISCONNECT AND 110V WATERPROOF OUTLET WITHIN 25' OF AC UNIT. SEE SPECIFICATIONS AND MANUFACTURER'S SPEC'S.

35 WATER FOUNTAIN PER OWNERS SPECS.

36 72" X 96" SKYLIGHT - PER OWNER'S SPEC. SEE DETAIL 23/D-1. ICC -ESR-2415

WALL LEGEND

2X4 STUDS AT 16" o.c. U.N.O.

2X6 STUDS AT 16" o.c. U.N.O. OCCUPANCY SEPARATION

ONE HOUR FIRE RATED (U / R-3) VERTICAL OCCUPANCY SEPARATION BETWEEN HOUSE & GARAGE. PROVIDE 1 LAYER 5/8" TYPE 'X' GYPSUM BOARD AT GARAGE SIDE OF WALLS FROM THE SLAB THRU THE ATTIC TO THE ROOF SHEATING & FRAMING SUPPORTING FLOORS ABOVE PER C.R.C.

ONE HOUR FIRE RATED (U / R-3) HORIZONTAL OCCUPANCY SEPARATION BETWEEN HOUSE AND GARAGE. PROVIDE 2 LAYERS 5/8" TYPE 'X' GYPSUM BOARD AT CEILING OF

PROVIDE 1 LAYER 5/8" TYPE 'X' GYP. BOARD @ WALL/CLG. OF ACCESSIBLE AREAS UNDER

DUCTS PENETRATING WALL OR CEILING SEPARATIONS BETWEEN A GARAGE AND A

DWELLING UNIT SHALL BE CONSTRUCTED OF MINIMUM 26 GAGE SHEET METAL AND

SHALL HAVE NO OPENINGS INTO THE GARAGE. PER C.R.C.

DRYER VENT

DRYER VENT DUCTS SHALL COMPLY WITH CMC SECTION 504: 1. MOISTURE EXHAUST DUCTS SHALL TERMINATE ON THE OUTSIDE OF THE

2. BE EQUIPPED WITH A BACKDRAFT DAMPER (PENETRATIONS THROUGH A FIRE WALL SHALL BE FIRE STOPPED APPROPRIATE TO THE FIRE RATING OF THE WALL

BEING PENETRATED). 3. VENTS SHALL BE A MIN. 4 INCHES IN DIAMETER & CONSTRUCTED OF METAL W/ SMOOTH INTERIOR SURFACES.

4. UNLESS OTHERWISE PERMITTED, MOISTURE EXHAUST DUCTS SHALL NOT EXCEED A TOTAL COMBINED LENGTH OF 14 FEET INCLUDING TWO 90 DEG. ELBOWS. 5. LONGER RUNS OR RUNS WITH MORE THAN 2 ELBOWS MUST USE AN APPROVED

6. THE TERMINATION POINT SHALL NOT BE LESS THAN 3'-0" FROM A PROPERTY LINE OR OPENING INTO THE BUILDING. **EMERGENCY BEDROOM EGRESS**

BOOSTER FAN LOCATED AT A POINT NO CLOSER THAN 14'-0" FROM THE DRYER.

EXTERIOR WINDOWS DESIGNATED FOR EMERGENCY EGRESS & RESCUE SHALL BE LABELED WITH AN SYMBOL (EACH SLEEPING ROOM SHALL HAVE AT LEAST ONE).

ALL EMERGENCY EGRESS OPENINGS SHALL COMPLY WITH CRC CODE

2. THE MIN. NET CLEAR OPENABLE HEIGHT DIMENSION SHALL BE 24 INCHES.

3. THE MIN. NET CLEAR OPENABLE WIDTH DIMENSION SHALL BE 20 INCHES. 4. FINISHED SILL HEIGHT SHALL NOT BE MORE THAN 44 INCHES ABOVE THE FLOOR.

5. THE EMERGENCY DOOR OR WINDOW SHALL BE OPERABLE FROM THE INSIDE TO PROVIDE A FULL, CLEAR OPENING WITHOUT THE USE OF SEPARATE TOOLS. 6. SEE DETAIL 21/D-2

FIBER-REINFORCED GYPSUM BACKERS SHALL BE USED AS A BASE FOR WALL TILE IN TUB AND SHOWER AREAS AND WALL AND CEILING PANELS IN SHOWER AREA PER CRC. 2. A MINIMUM 26 GA. CORROSION-RESISTANT OR PLASTIC WEEP SCREED WITH A

MINIMUM VERTICAL FLANGE OF 3 ½" SHALL BE PROVIDED AT OR BELOW FOUNDATION

1. ESCAPE & RESCUE WINDOWS SHALL HAVE A MIN. NET CLEAR OPENABLE AREA OF 5.7

PLATE LINE ON EXTERIOR STUD WALLS. SCREED SHALL BE A MINIMUM OF 6" ABOVE EARTH OR 2" ABOVE PAVED AREAS, PER CRC. 3. PROVIDE A MINIMUM 1" BUILDING WATER SUPPLY FOR EACH SINGLE FAMILY

DWELLING, PER CPC. 4. CONDENSATE LINES FROM MECHANICAL EQUIPMENT SHALL DISCHARGE TO A PLUMBING FIXTURE OR STORM DRAIN BY MEANS OF AN INDIRECT WASTE PIPE.

CONDENSATE LINES SHALL NOT TERMINATE IN LANDSCAPE OR YARD AREAS PER CMC. 5. ALL GARAGE DOORS SHALL BE PROVIDED WITH A U.L. LISTED AUTOMATIC GARAGE DOOR OPENER.


6. TYPICAL 6" CLEAR FROM DOOR TO PERPENDICULAR WALL. 7. ALL EXTERIOR DOORS OF CONDITIONED SPACES SHALL BE FULLY

WEATHERSTRIPPED. 8. WATERCLOSETS TO BE MAXIMUM 1.28 GALLONS PER FLUSH PER CGBSC TABLE 4.303.2 9. SPECIFY GLAZING MATERIAL SHALL BE FULLY TEMPERED,

HEAT-STRENGTHENED, WIRED, APPROVED RIGID PLASTIC, OR LAMINATED IN ACCORDANCE WITH CRC R308.6.2 10. IRRIGATION CONTROLLERS MUST BE WEATHER (RAIN SENSOR) OR SOIL MOISTURE BASED CONTROLLERS.

FIRST FLOOR PLAN 2179 SQ. FT. SECOND FLOOR PLAN TOTAL LIVING 6663 SQ. FT. 945 SQ. FT. FRONT PORCH 18 SQ. FT. 212 SQ. FT. SITTING 132 SQ. FT. DECK 288 SQ. FT.

Sheet Title: **PROPOSED** SECOND FLOOR PLAN

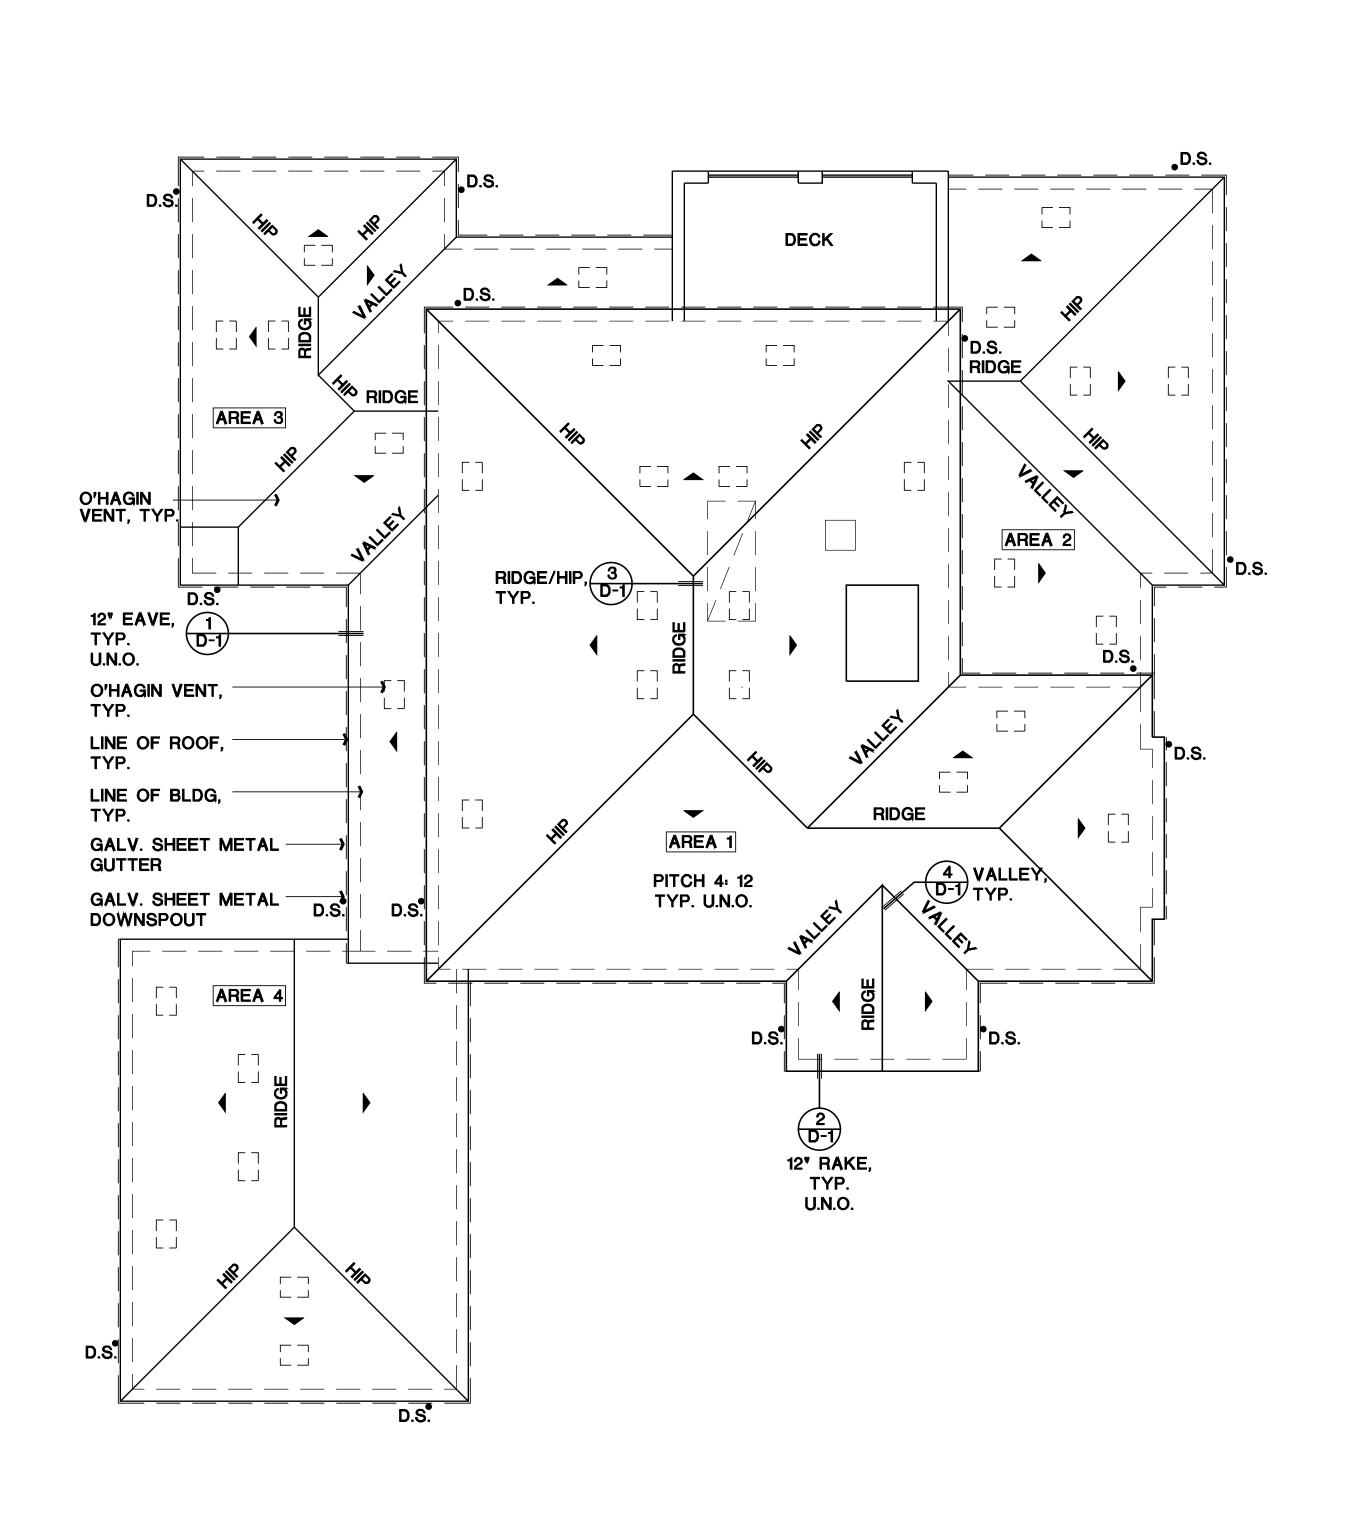





VENTILATION SCHEDULE

O'HAGIN CLOAKED VENT TILE:

NET FREE VENT.: 97.5 SQ. IN.(LOW 'S')

MODEL: 3.5"x22" - 1/4" SCREEN

NET FREE VENT.: 43.68 SQ. IN. PER BAY

AWARD METALS OR APPROVED EQUAL

STOCKTON PRODUCTS (OR APPROVED EQUAL)

MODEL: "S" #50046

SBCCI REPORT No. 9650A

AREA 3

(3)O'HAGIN VENTS AT

(3)O'HAGIN VENTS AT

(3)O'HAGIN VENTS AT

(3)O'HAGIN VENTS AT

TOTAL FREE AREA =

TOTAL FREE AREA =

ATTIC SQUARE FOOTAGE = 999 SQ. FT.

ATTIC SQUARE FOOTAGE = 983 SQ. FT.

999 SQ. FT. x 1/300 = 3.33 SQ. FT. (480 SQ. IN. - REQ.)

983 SQ. FT. x 1/300 = 3.27 SQ. FT. (472 SQ. IN. - REQ.)

97.5 SQ. IN. = 292.5 SQ. IN. HIGH

97.5 SQ. IN. = 292.5 SQ. IN. LOW 585 SQ. IN.

97.5 SQ. IN. = 292.5 SQ. IN. HIGH

97.5 SQ. IN. = 292.5 SQ. IN. LOW 585 SQ. IN.

1. ROOF MATERIAL: CONCRETE LOW 'S' EAGLE TILE, CLASS 'A' ER# 1900, REFER TO ROOF

9. INSTALLATION AND FASTENING REQUIREMENTS FOR CONCRETE TILE PER CRC R905.3

2. ALL ROOFING TO BE INSTALLED OVER MINIMUM (1), LAYER OF 30# ROOF FELT,

3. REFER TO EXTERIOR ELEVATIONS FOR ROOF TO WALL FLASHING DETAILS

WEATHERBOARD LAP INSTALL PER TILE MFR. SPECS.

4. REFER TO 9/AD.2 FOR TYPICAL VENT THROUGH ROOF DETAILS

5. REFER TO 8/AD.2 FOR TYPICAL RAKE TO WALL DIVERTER DETAIL

6. 12" TYPICAL ROOF OVERHANG AT EAVE, U.N.O.

7. 12" TYPICAL ROOF OVERHANG AT RAKE, U.N.O.

8. RADIANT BARRIER TYPICAL, REFER TO T24 SHEETS

PLANOS

DRAFTING

GONZALO GUILLEN DESIGNER

718 S. Hickory St.

8 PRECAST TRIM AS SELECTED BY OWNER & INSTALL PER MANUFACTURER

Sheet Title:

Sheet No.:

EXTERIOR

ELEVATIONS

10 TUBE STEEL RAILING/GUARDRAIL - REFER TO DETAIL 6/D-1

13 FOAM COAT SHUTTER, REFER TO SPEC'S & DETAIL 5/D-1

16 DECORATIVE RAILING ABOVE ENTRY DOOR, SEE DETAIL 17/D-1

18 72" X 96" SKYLIGHT - PER OWNER'S SPEC. SEE DETAIL 23/D-1. ICC -ESR-2415

LOCATION OF ILLUMINATED ADDRESS SIGN W/PHOTOCELL, VISIIBLE FROM STREET PER CRC

9 GARAGE DOOR AS SELECTED BY OWNER.


11 CORBEL AT POPOUT - REFER TO DETAIL 18/D-1

14 LIGHT FIXTURE - REFER TO ELECTRICAL PLANS

15 SPARK ARRESTOR.

12 FALSE PIPE VENTS - REFER TO DETAIL 11/D-1

 Design Drawings Construction Drawings

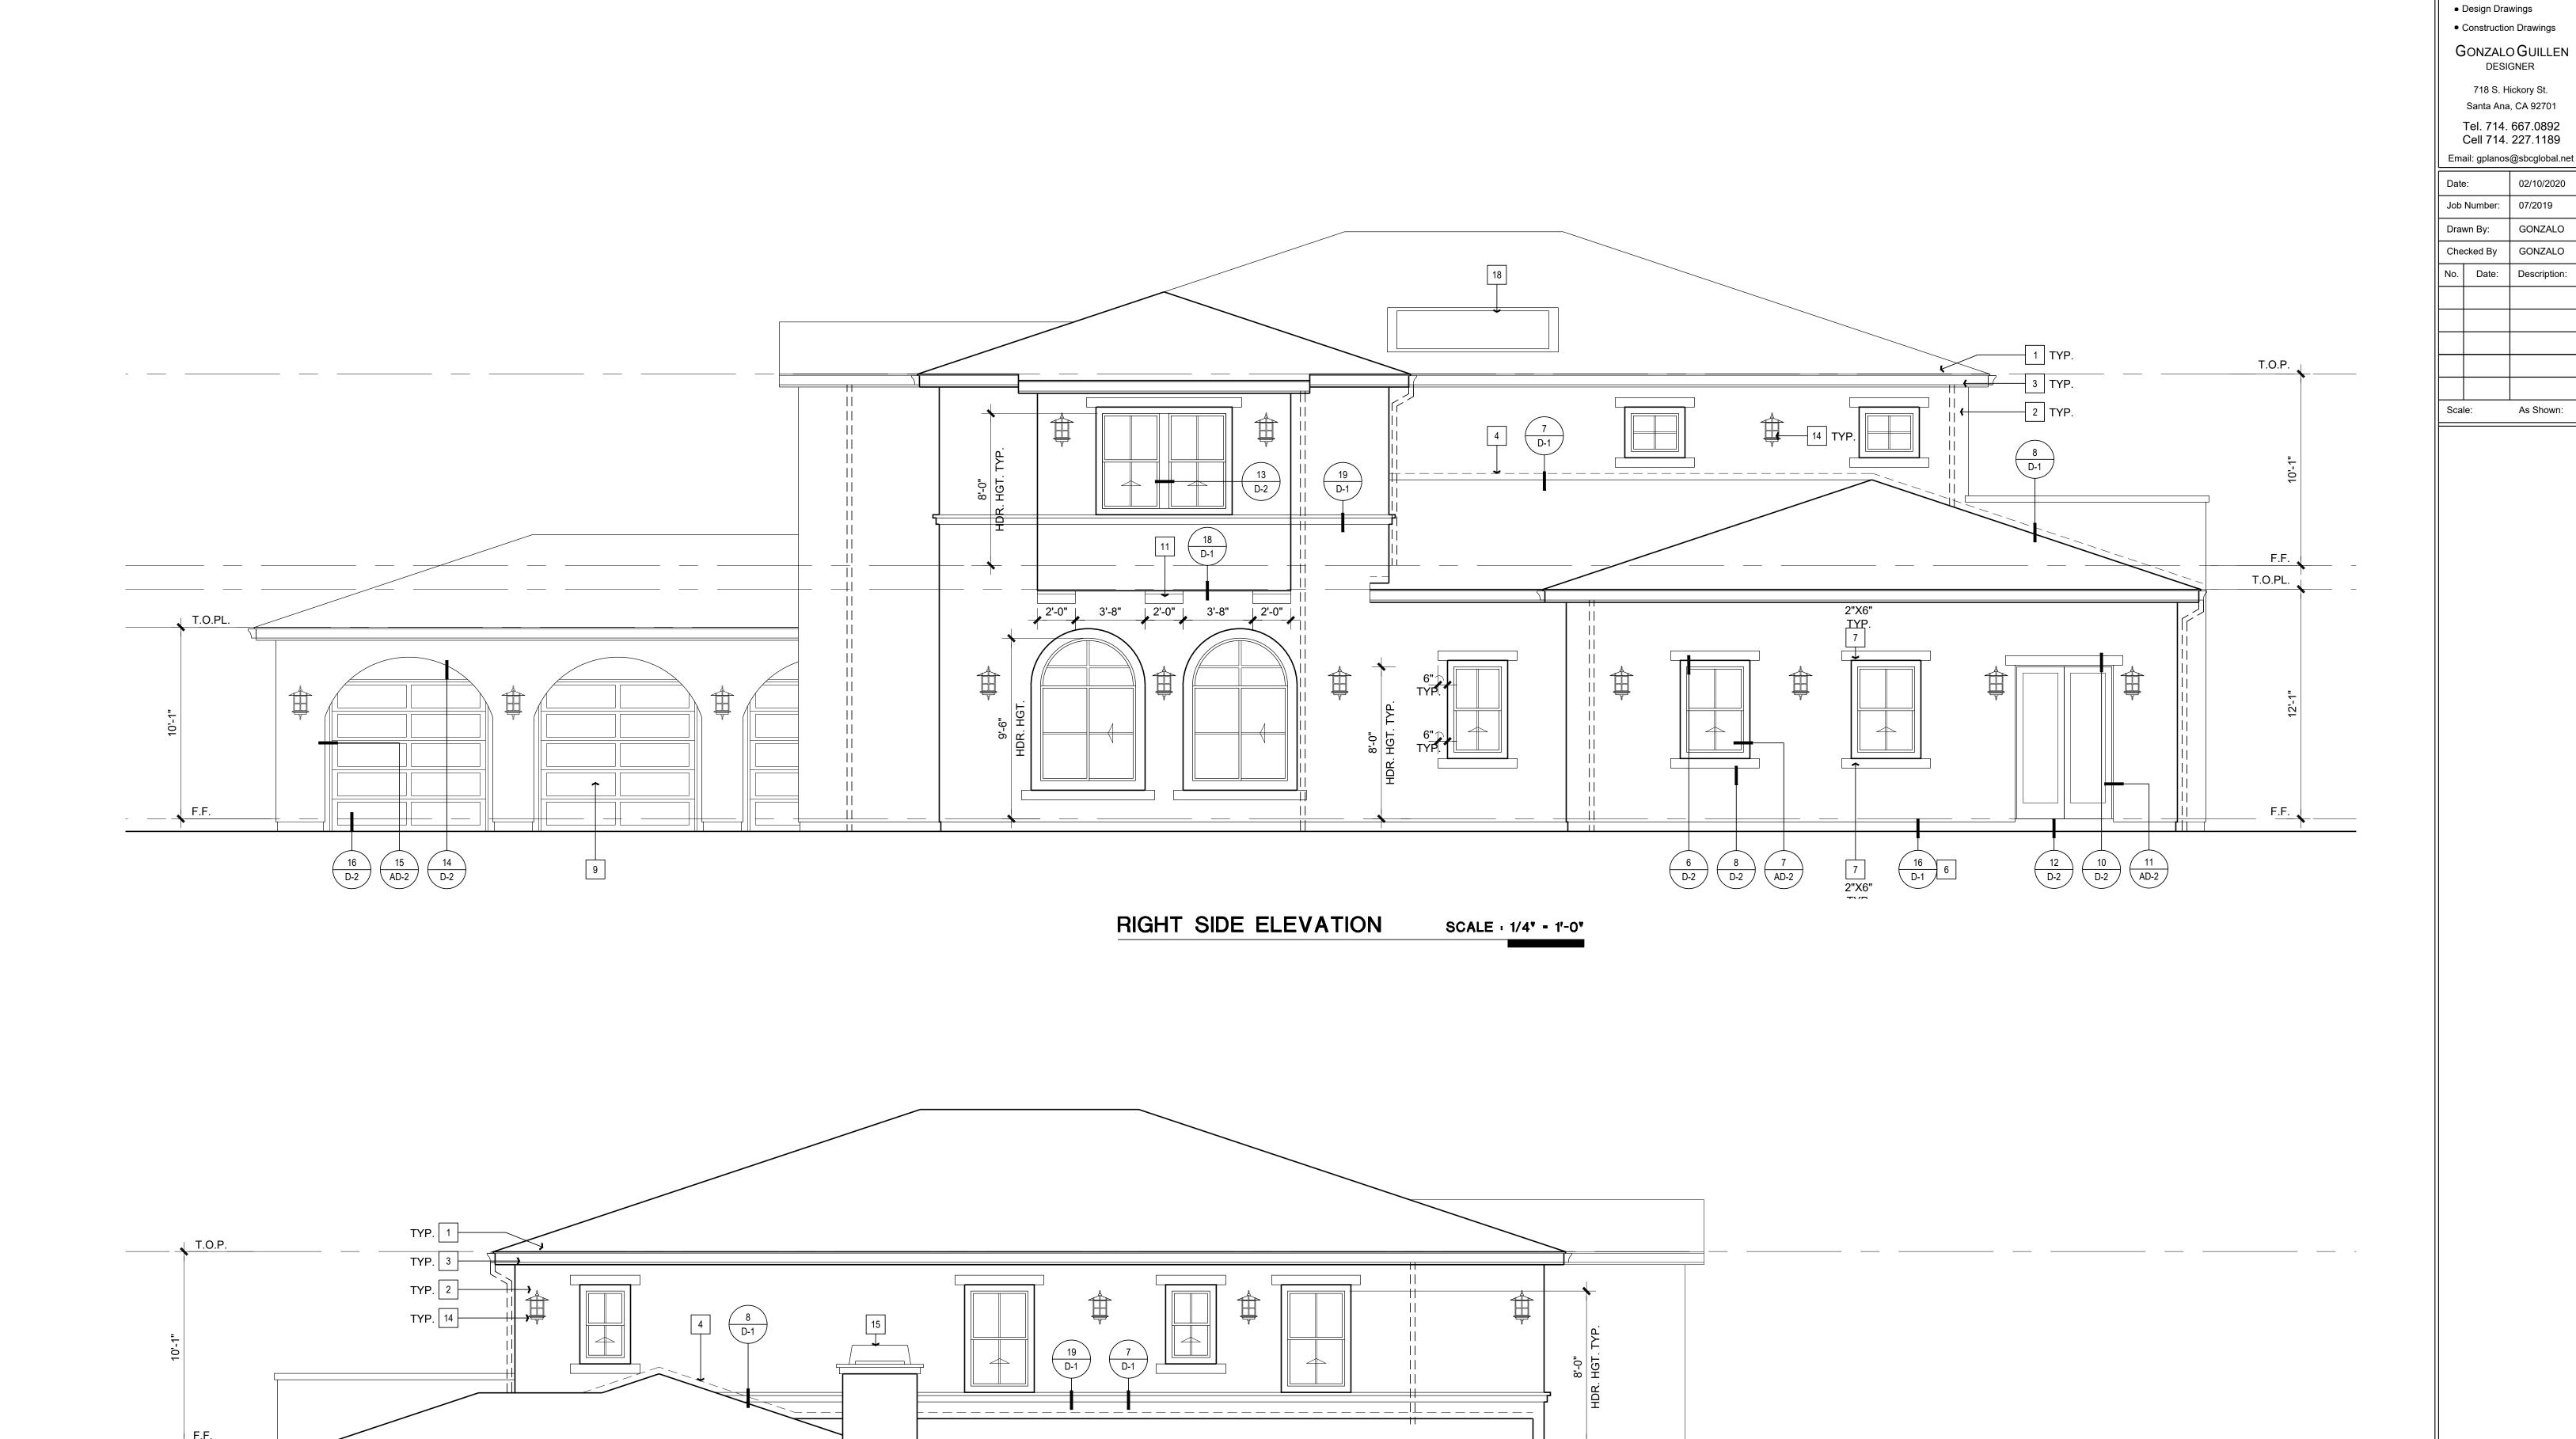

LEFT SIDE ELEVATION

SCALE : 1/4" = 1'-0"

7 2"X6" TYP.



- 1 ROOF MATERIAL REFER TO ROOF NOTES
- 2 THREE (3) COAT 7/8" CEMENT PLASTER, PAINT COLOR AS SELECTED BY OWNER.
- 3 BARGE BOARD/FASCIA
- 4 G.I. FLASHING
- 5 G.I. FLASHING & SADDLE/CRICKET 6 G.I. DRIP SCREED
- 7 EPS FOAM WITH THREE(3) COAT 7/8" CEMENT PLASTER, PAINT COLOR AS SELECTED BY OWNER
- 8 PRECAST TRIM AS SELECTED BY OWNER & INSTALL PER MANUFACTURER
- 9 GARAGE DOOR AS SELECTED BY OWNER.
- 10 TUBE STEEL RAILING/GUARDRAIL REFER TO DETAIL 6/D-1 11 CORBEL AT POPOUT - REFER TO DETAIL 18/D-1
- 12 FALSE PIPE VENTS REFER TO DETAIL 11/D-1
- 13 FOAM COAT SHUTTER, REFER TO SPEC'S & DETAIL 5/D-1
- 14 LIGHT FIXTURE REFER TO ELECTRICAL PLANS
- 15 SPARK ARRESTOR.
- 16 DECORATIVE RAILING ABOVE ENTRY DOOR, SEE DETAIL 17/D-1
- LOCATION OF ILLUMINATED ADDRESS SIGN W/PHOTOCELL, VISIIBLE FROM STREET PER CRC R319
- 18 72" X 96" SKYLIGHT PER OWNER'S SPEC. SEE DETAIL 23/D-1. ICC -ESR-2415

GRANADOS RESIDENCE
17312 LOBDELL LANE
SILVERADO, CA 92676

Sheet Title: **EXTERIOR ELEVATIONS**


PLANOS


DRAFTING


DESIGNER

As Shown:


Sheet No.:

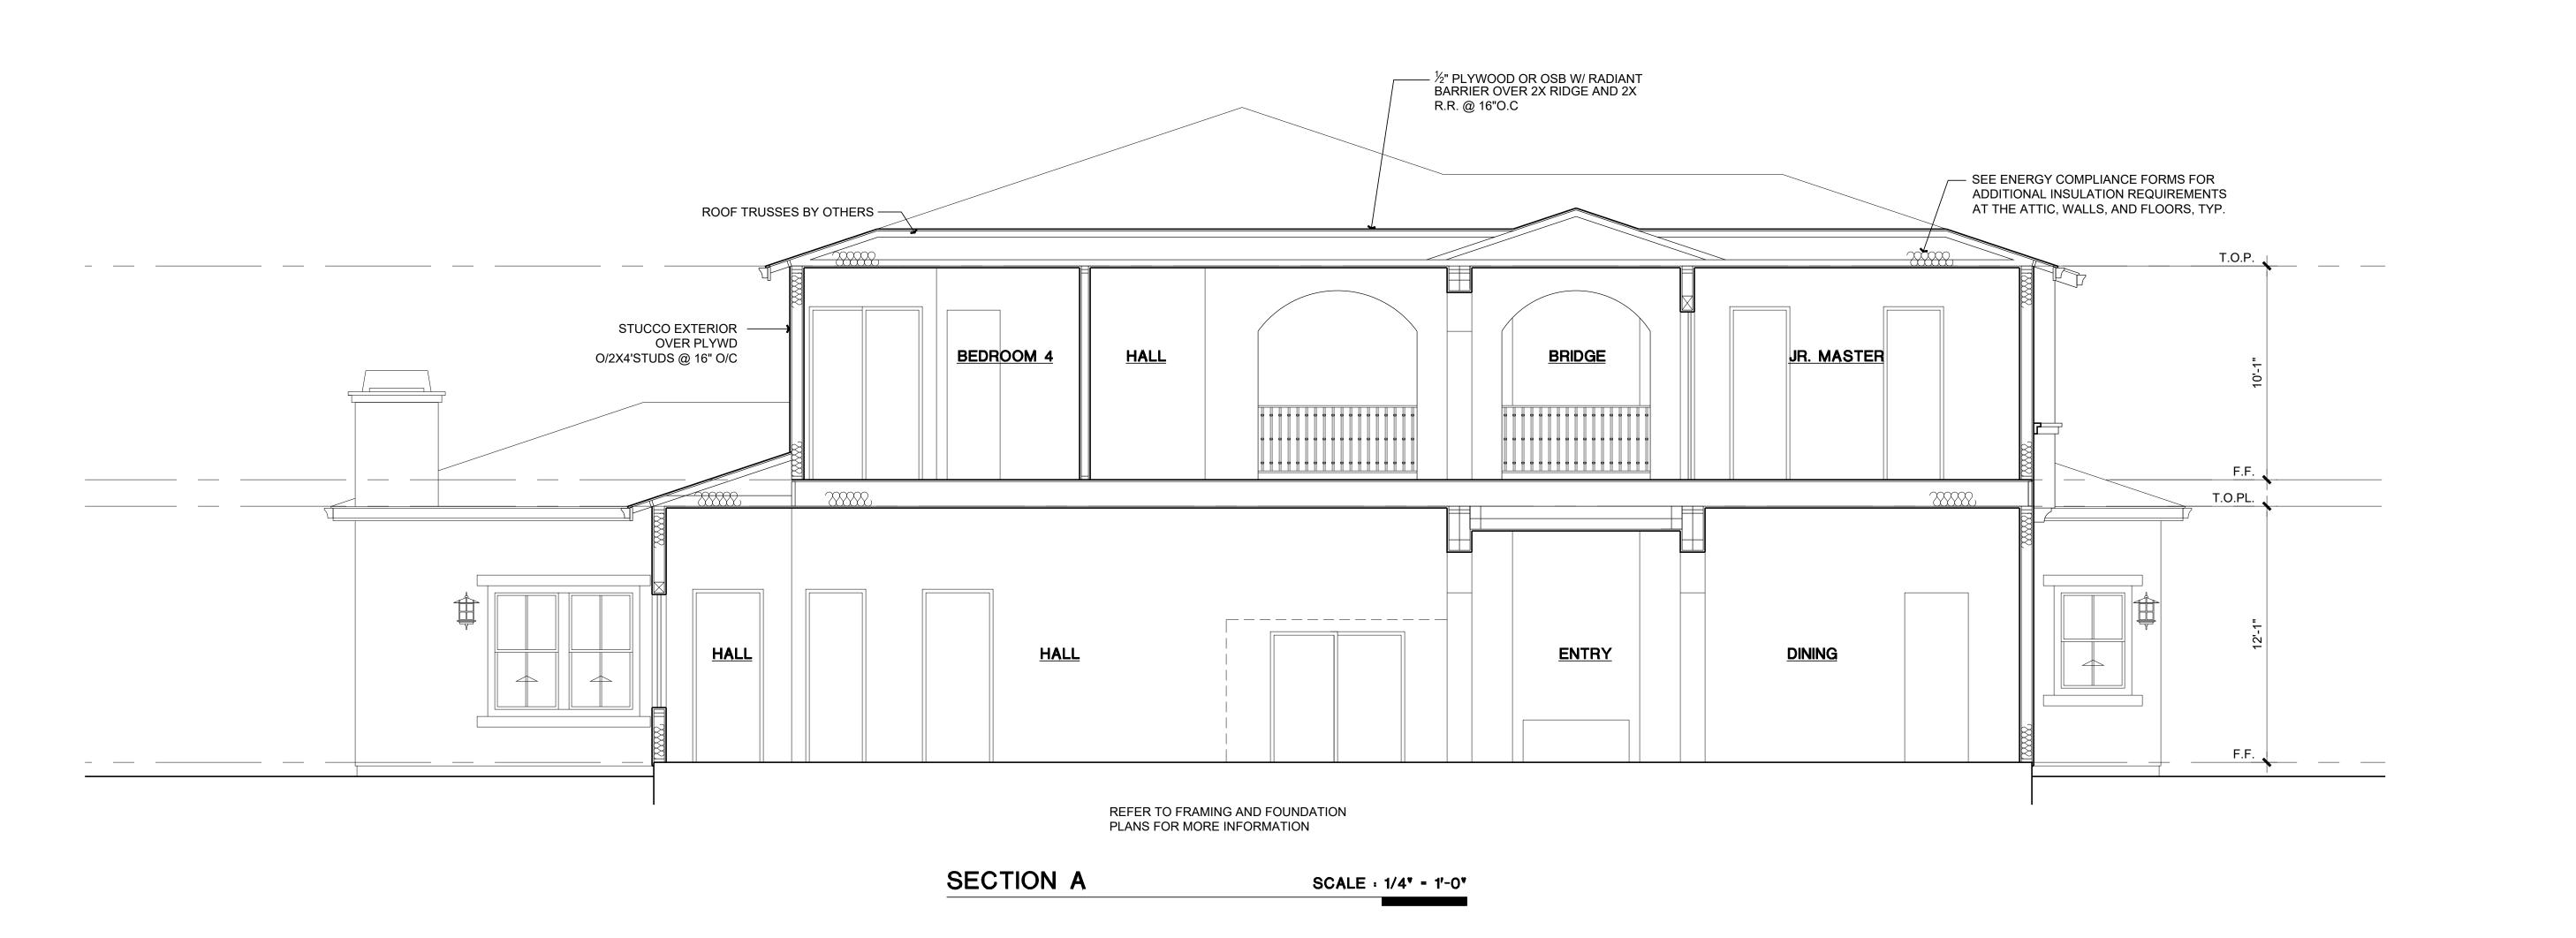

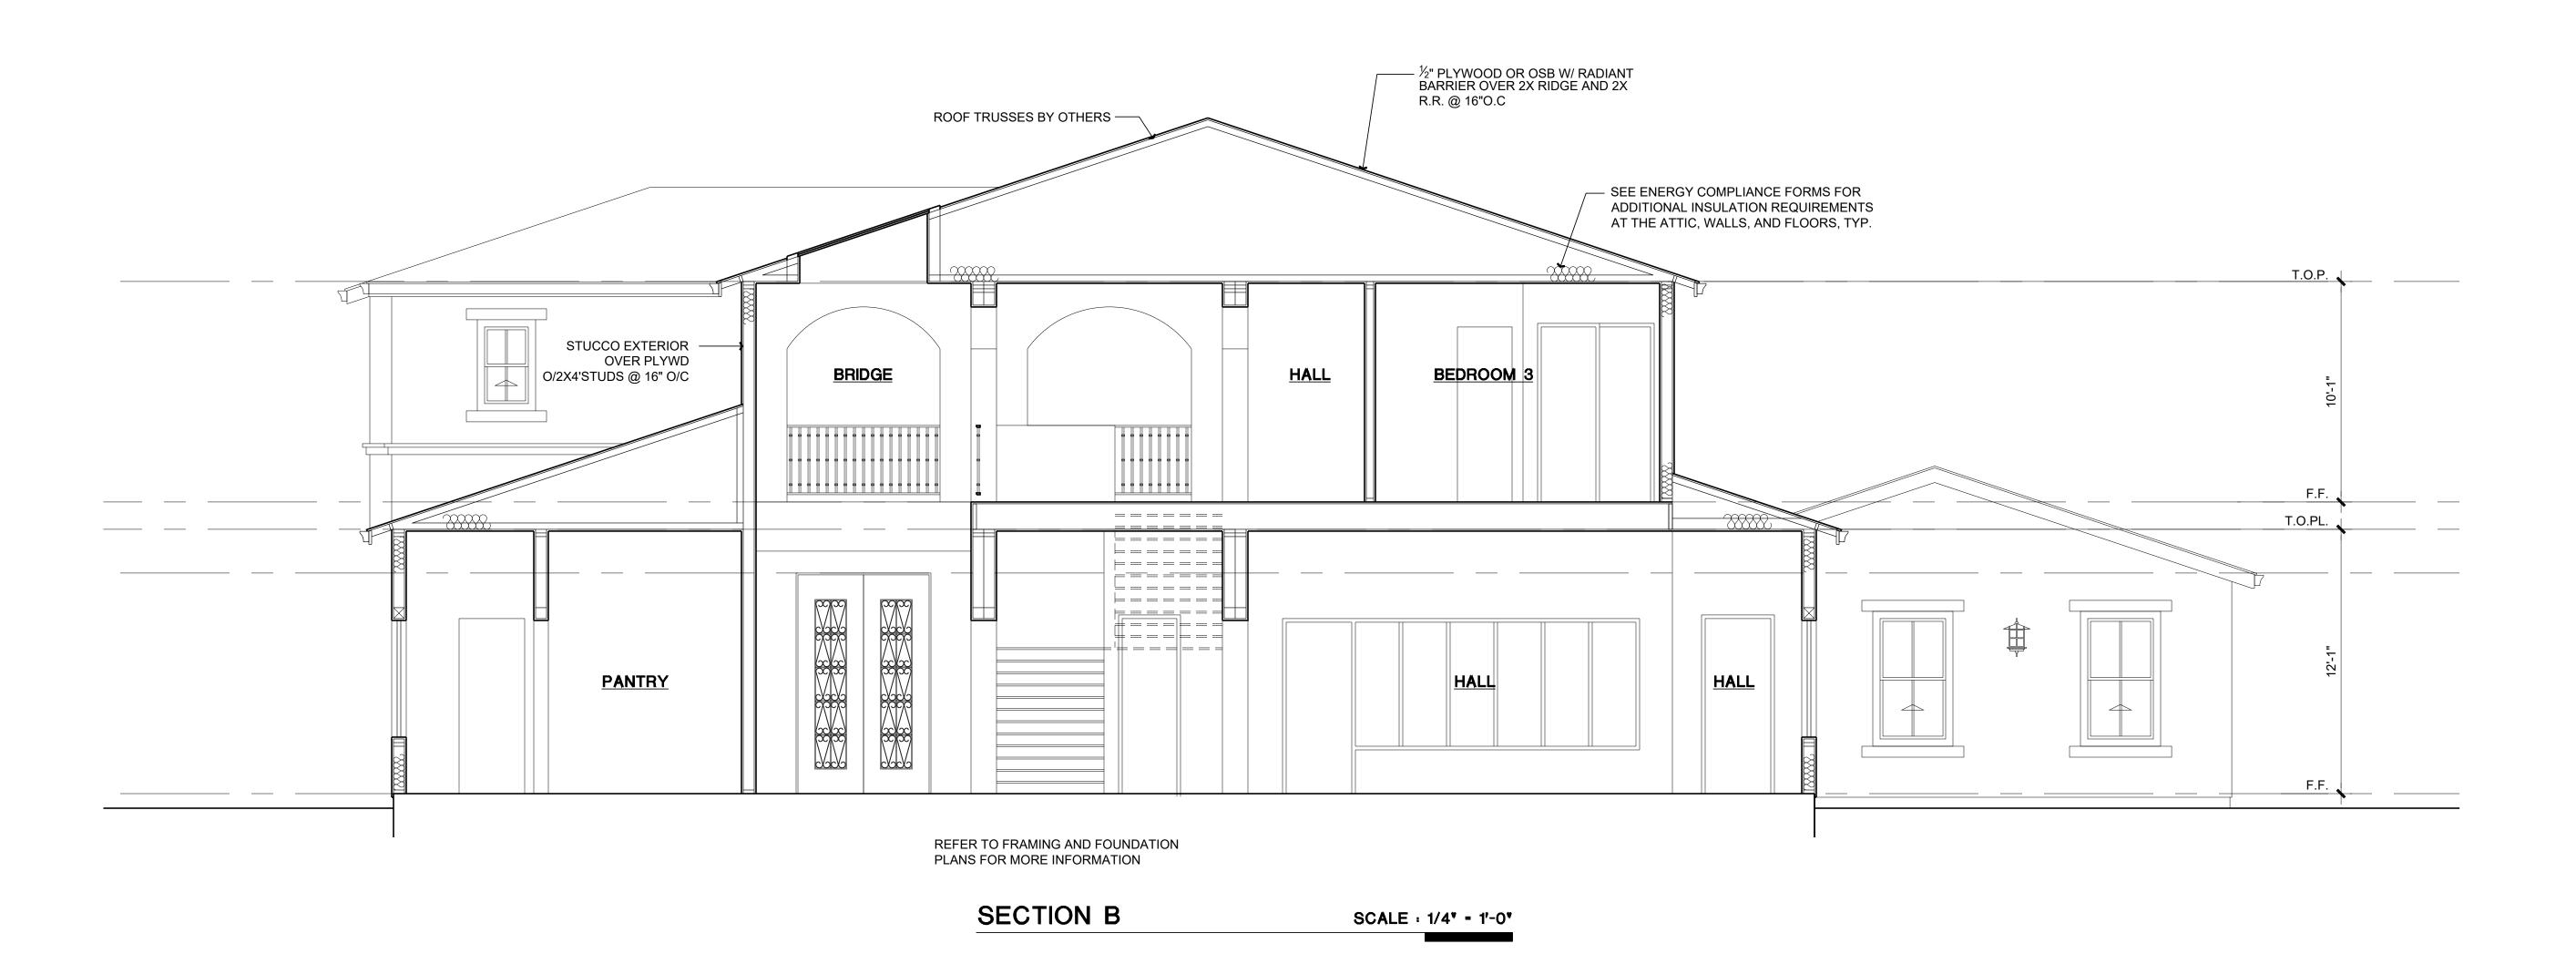

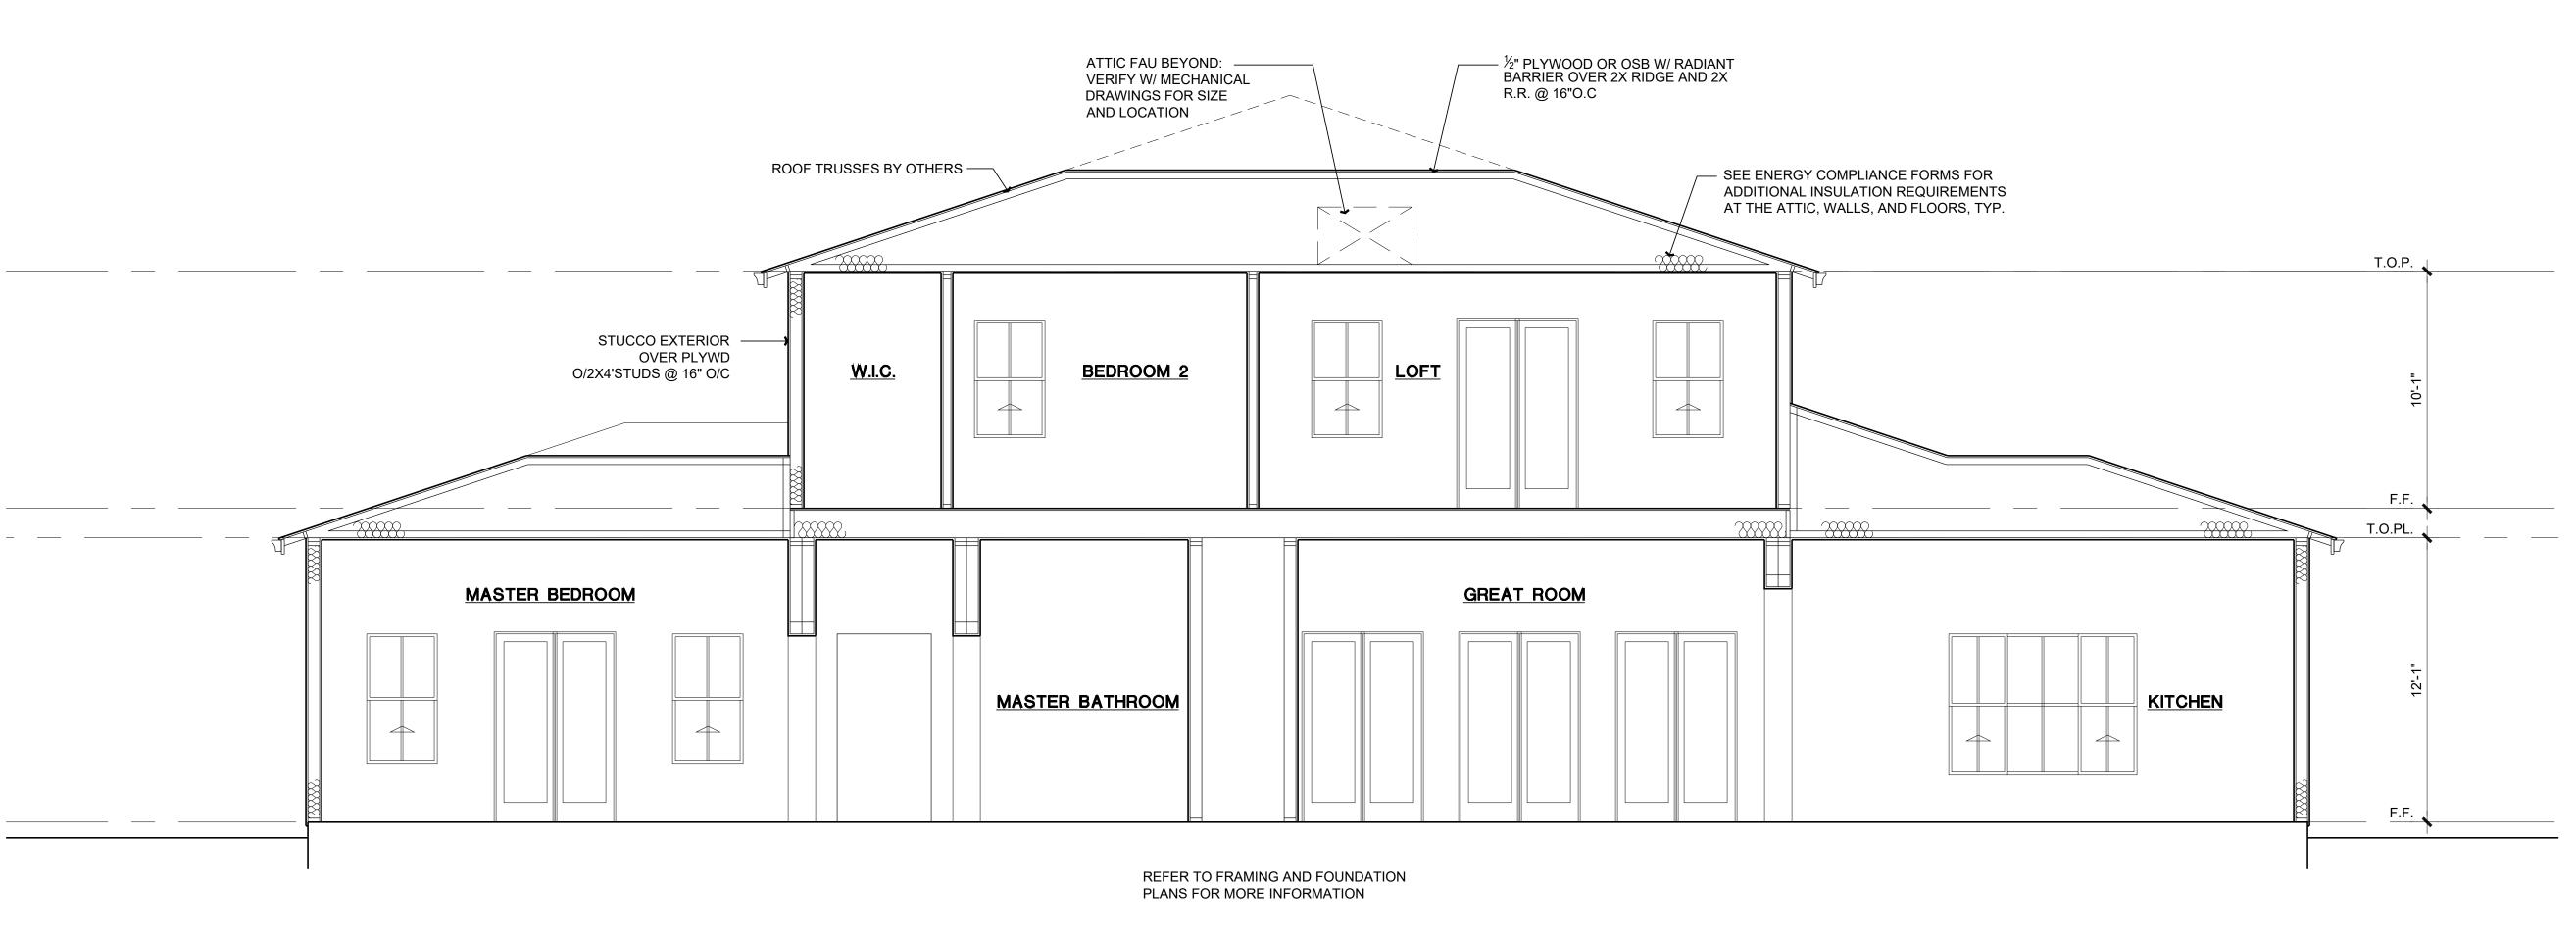

SECTION C SCALE: 1/4" = 1'-0"

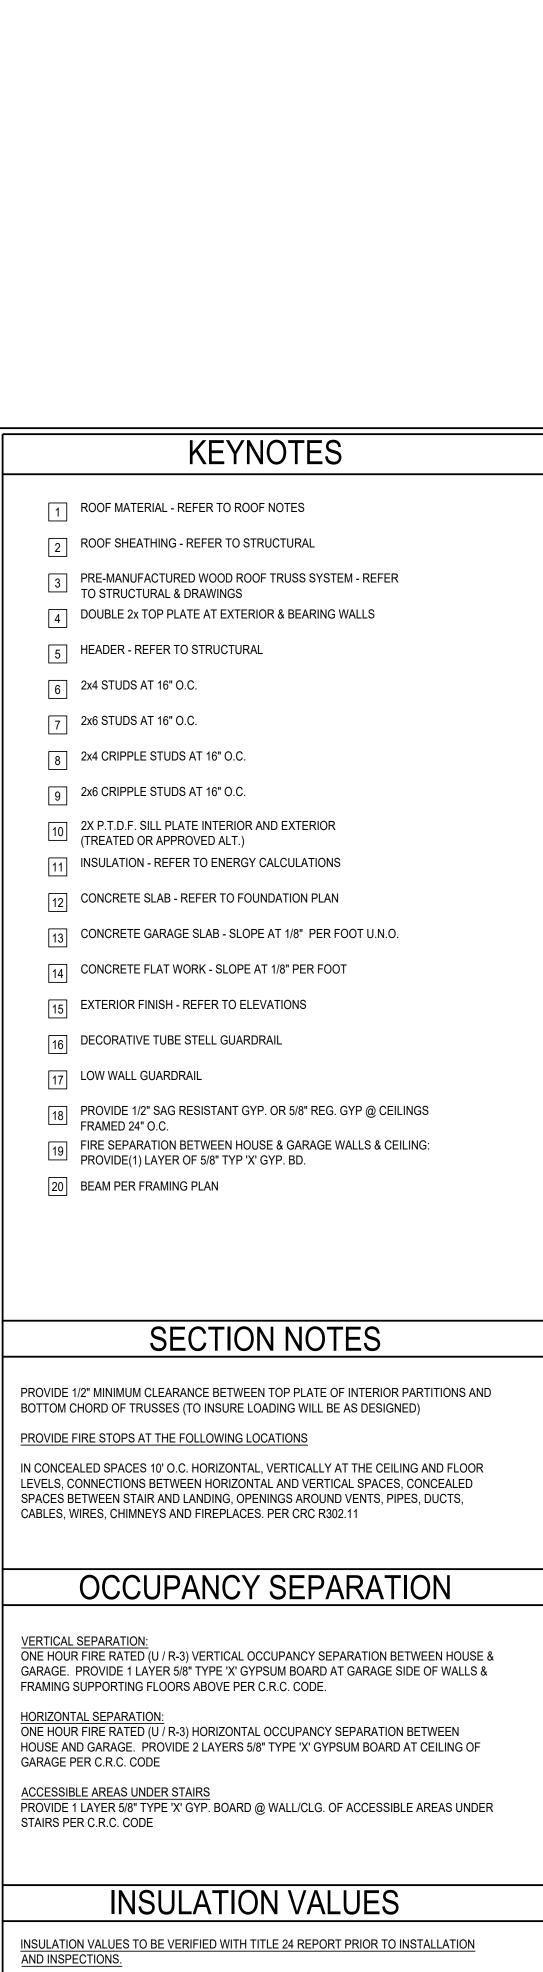

WALLS (2X6) : ROOF (TRUSS) :

R-30

PLANOS

DRAFTING

GONZALO GUILLEN
DESIGNER

718 S. Hickory St. Santa Ana, CA 92701 Tel. 714. 667.0892 Cell 714. 227.1189

Email: gplanos@sbcglobal.net

Job Number: 07/2019

Drawn By: GONZALO

Checked By GONZALO

No. Date: Description:

Scale:

GRANADOS RESIDENC
17312 LOBDELL LANE
SILVERADO, CA 92676

Sheet Title:

Sheet No.:


BUILDING


SECTIONS

02/10/2020


As Shown:

Design DrawingsConstruction Drawings

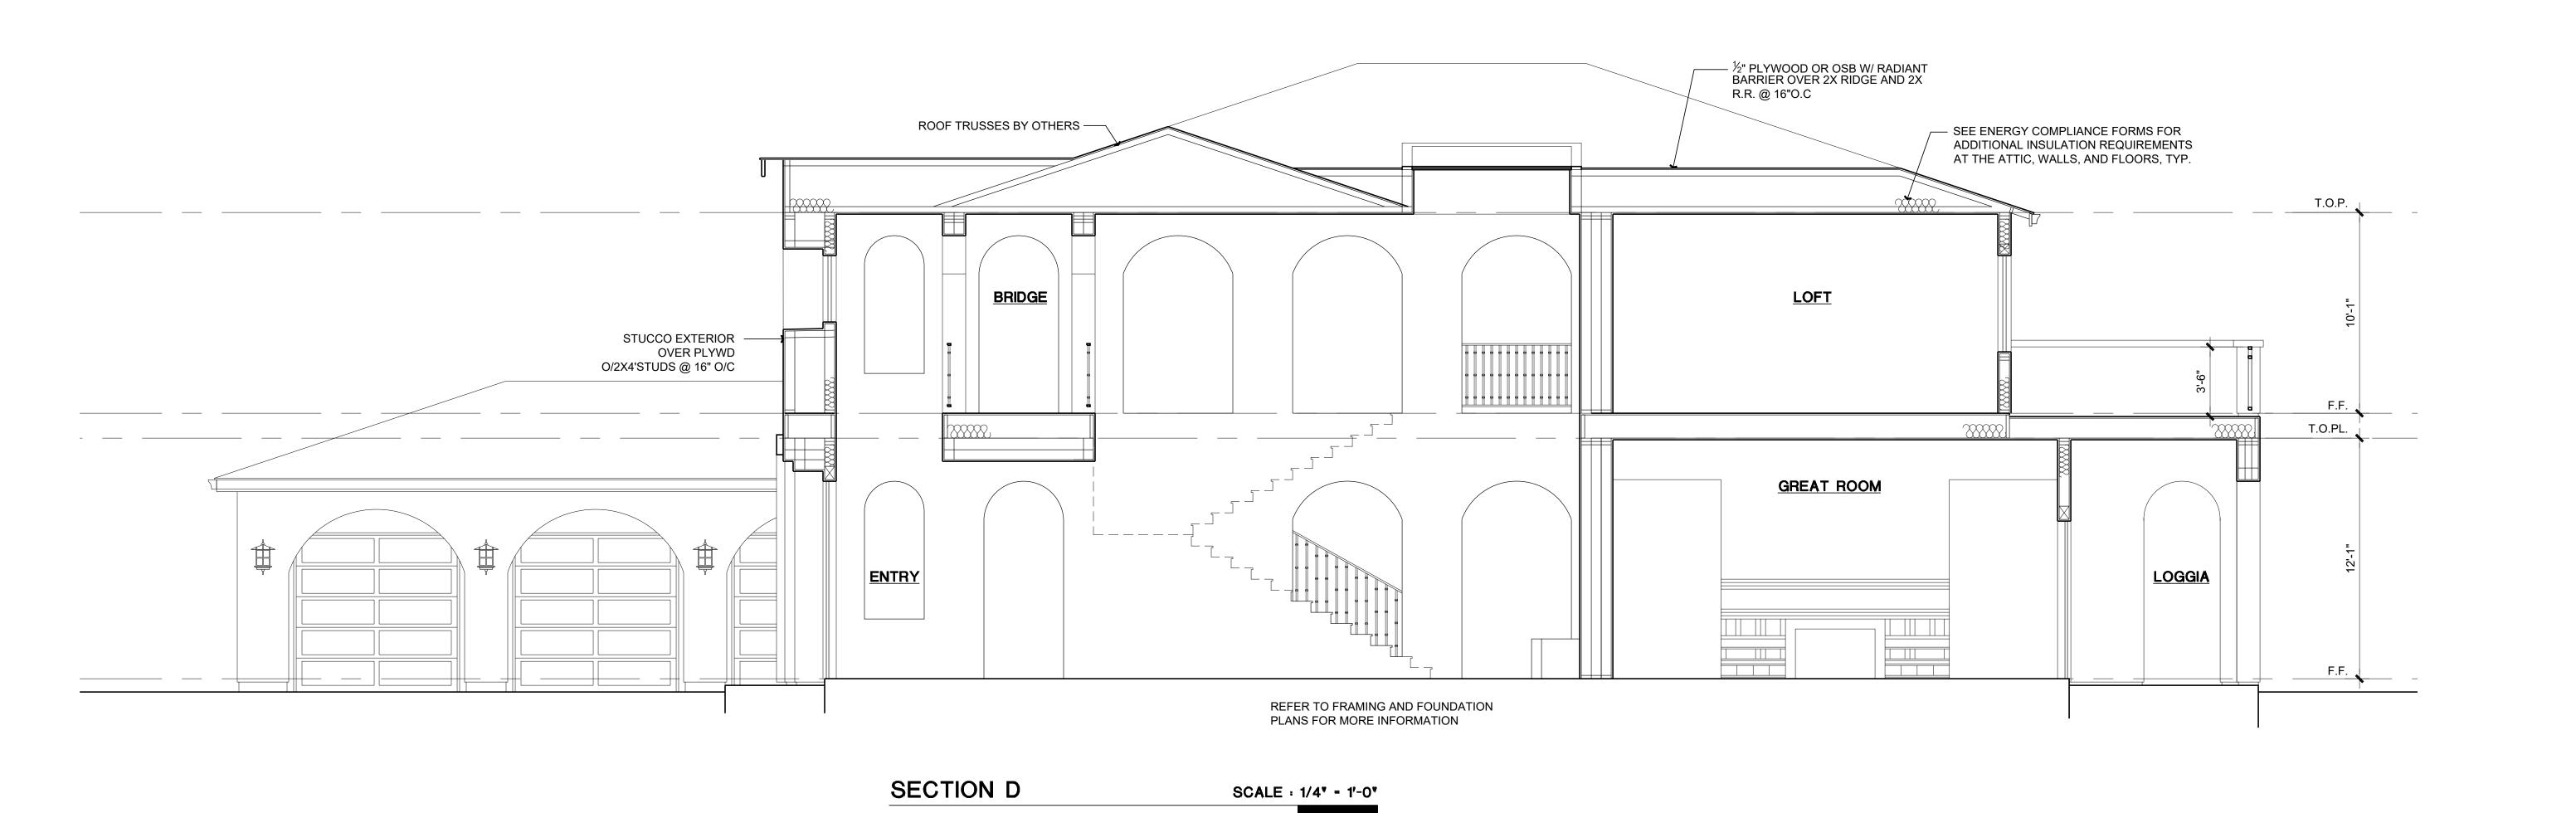

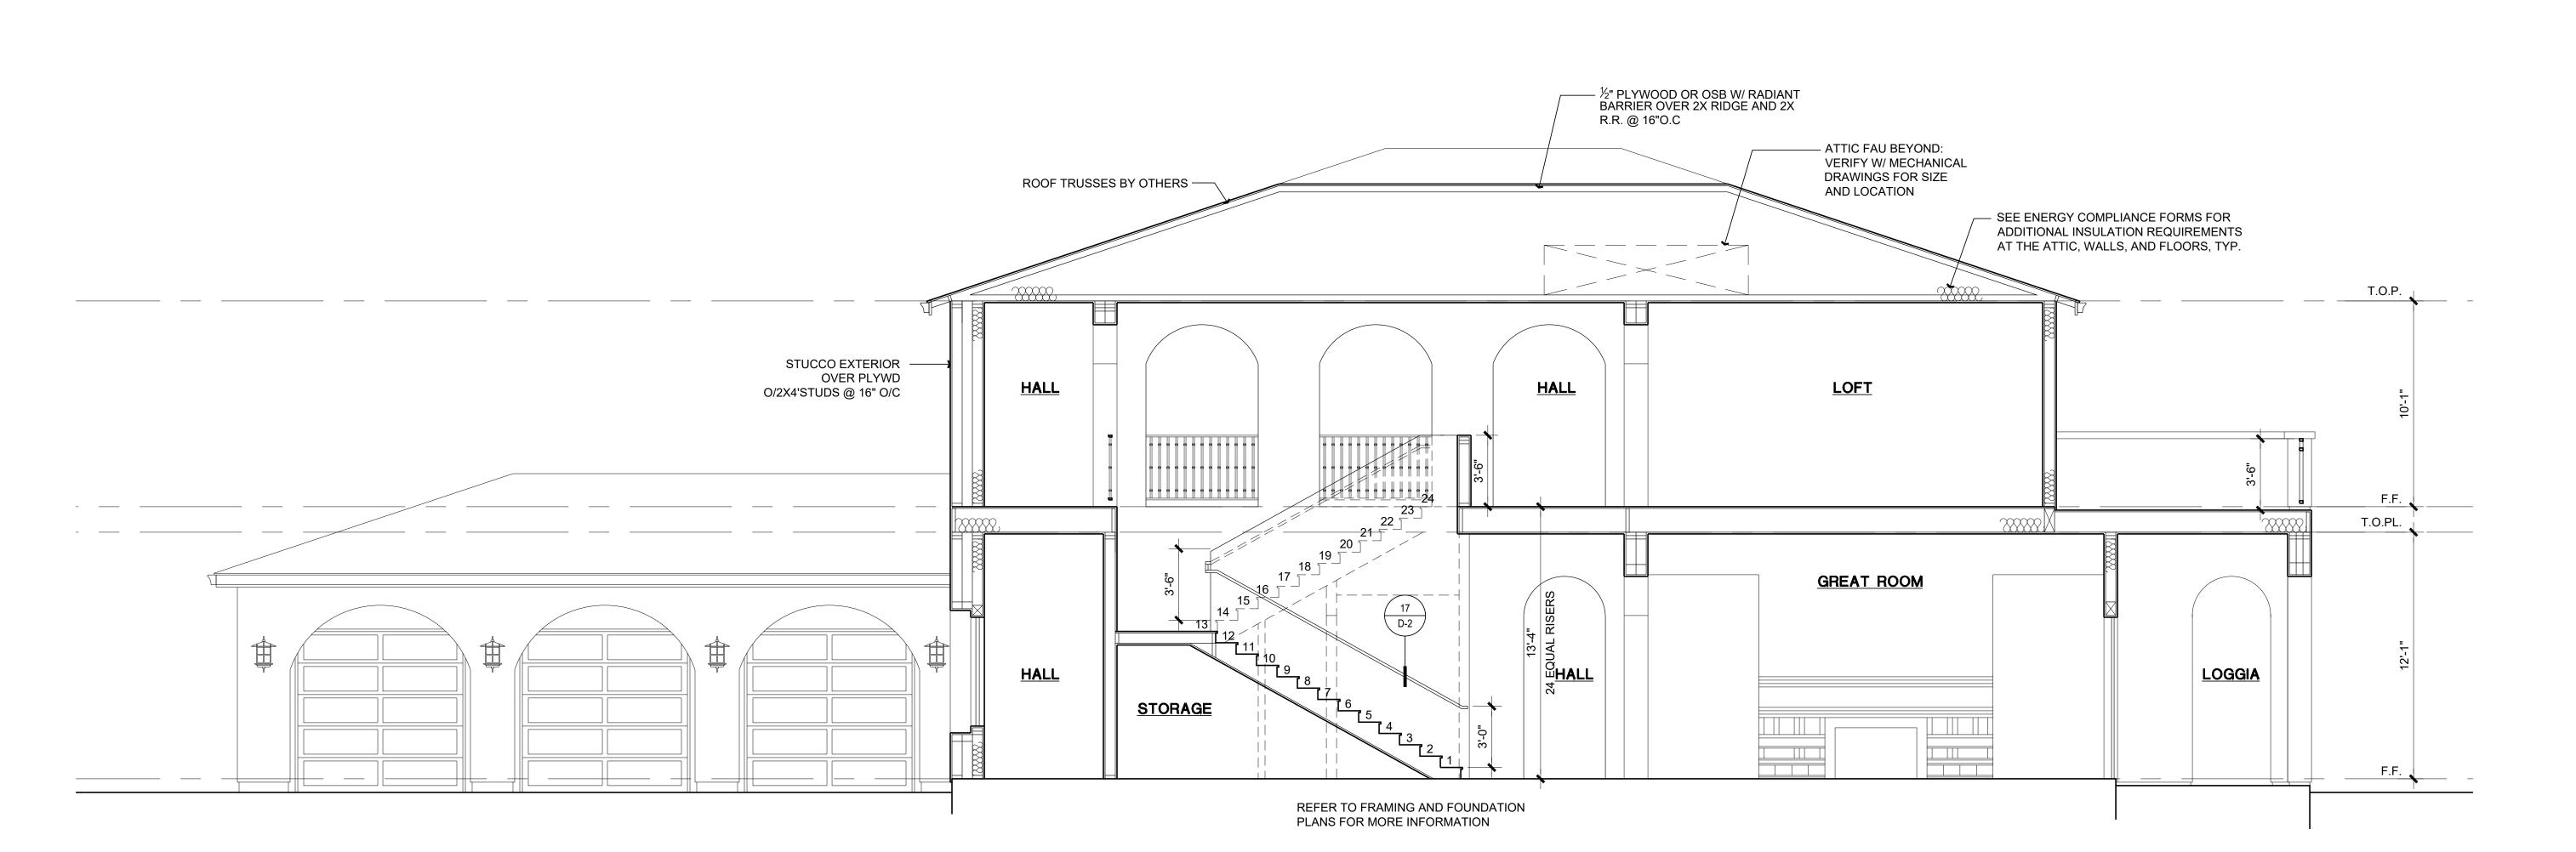


SCALE : 1/4" - 1'-0"

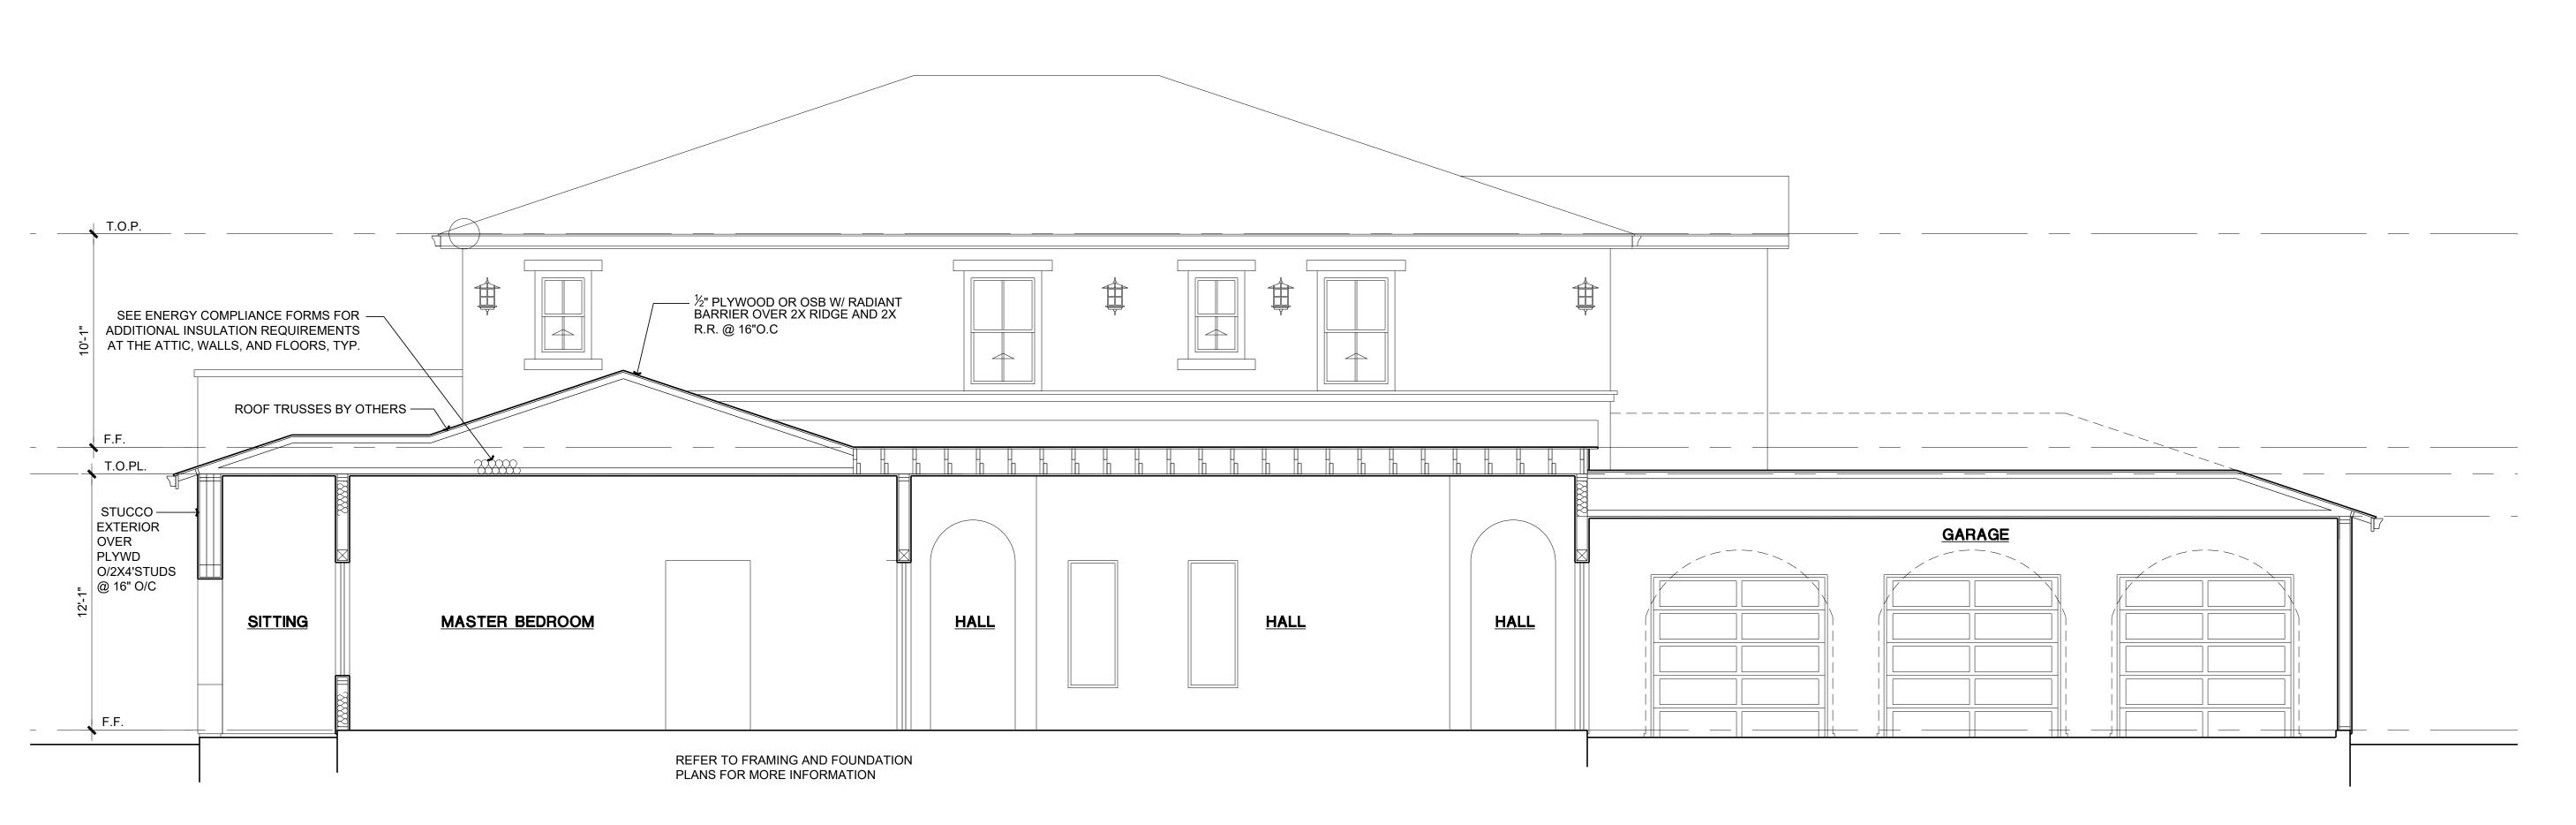

SECTION F SCALE : 1/4" - 1'-0"

SECTION E

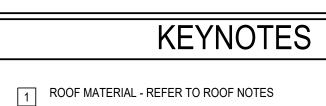

- 2 ROOF SHEATHING REFER TO STRUCTURAL
- PRE-MANUFACTURED WOOD ROOF TRUSS SYSTEM REFER TO STRUCTURAL & DRAWINGS
- DOUBLE 2x TOP PLATE AT EXTERIOR & BEARING WALLS
- 5 HEADER REFER TO STRUCTURAL
- 6 2x4 STUDS AT 16" O.C.
- 7 2x6 STUDS AT 16" O.C.
- 8 2x4 CRIPPLE STUDS AT 16" O.C.
- 9 2x6 CRIPPLE STUDS AT 16" O.C.
- 2X P.T.D.F. SILL PLATE INTERIOR AND EXTERIOR (TREATED OR APPROVED ALT.)

 INSULATION REFER TO ENERGY CALCULATIONS
- CONCRETE SLAB REFER TO FOUNDATION PLAN
- CONCRETE GARAGE SLAB SLOPE AT 1/8" PER FOOT U.N.O.
- CONCRETE FLAT WORK SLOPE AT 1/8" PER FOOT
- EXTERIOR FINISH REFER TO ELEVATIONS

 DECORATIVE TUBE STELL GUARDRAIL
- 5 LOW WALL GUARDRAIL
- LOW WALL GUARDRAIL
- PROVIDE 1/2" SAG RESISTANT GYP. OR 5/8" REG. GYP @ CEILINGS FRAMED 24" O.C.
- FIRE SEPARATION BETWEEN HOUSE & GARAGE WALLS & CEILING: PROVIDE(1) LAYER OF 5/8" TYP 'X' GYP. BD.
- 20 BEAM PER FRAMING PLAN

SECTION NOTES

PROVIDE 1/2" MINIMUM CLEARANCE BETWEEN TOP PLATE OF INTERIOR PARTITIONS AND BOTTOM CHORD OF TRUSSES (TO INSURE LOADING WILL BE AS DESIGNED)

PROVIDE FIRE STOPS AT THE FOLLOWING LOCATIONS

IN CONCEALED SPACES 10' O.C. HORIZONTAL, VERTICALLY AT THE CEILING AND FLOOR LEVELS, CONNECTIONS BETWEEN HORIZONTAL AND VERTICAL SPACES, CONCEALED SPACES BETWEEN STAIR AND LANDING, OPENINGS AROUND VENTS, PIPES, DUCTS, CABLES, WIRES, CHIMNEYS AND FIREPLACES. PER CRC R302.11

OCCUPANCY SEPARATION

VERTICAL SEPARATION:
ONE HOUR FIRE RATED (U / R-3) VERTICAL OCCUPANCY SEPARATION BETWEEN HOUSE &
GARAGE. PROVIDE 1 LAYER 5/8" TYPE 'X' GYPSUM BOARD AT GARAGE SIDE OF WALLS &
FRAMING SUPPORTING FLOORS ABOVE PER C.R.C. CODE.

HORIZONTAL SEPARATION:
ONE HOUR FIRE RATED (U / R-3) HORIZONTAL OCCUPANCY SEPARATION BETWEEN

HOUSE AND GARAGE. PROVIDE 2 LAYERS 5/8" TYPE 'X' GYPSUM BOARD AT CEILING OF GARAGE PER C.R.C. CODE

ACCESSIBLE AREAS UNDER STAIRS
PROVIDE 1 LAYER 5/8" TYPE 'X' GYP. BOARD @ WALL/CLG. OF ACCESSIBLE AREAS UNDER
STAIRS PER C.R.C. CODE

INSULATION VALUES

INSULATION VALUES TO BE VERIFIED WITH TITLE 24 REPORT PRIOR TO INSTALLATION AND INSPECTIONS.

WALLS (2X6): R-19 ROOF (TRUSS): R-30 **A**6

BUILDING

SECTIONS

Sheet Title:

RESIDENCE

PLANOS

DRAFTING

Design Drawings

Construction Drawings

GONZALO GUILLEN
DESIGNER

718 S. Hickory St.

Santa Ana, CA 92701 Tel. 714. 667.0892 Cell 714. 227.1189

Email: gplanos@sbcglobal.net

Job Number: 07/2019


Drawn By: GONZALO


Checked By GONZALO


No. Date: Description:


As Shown:


Scale:

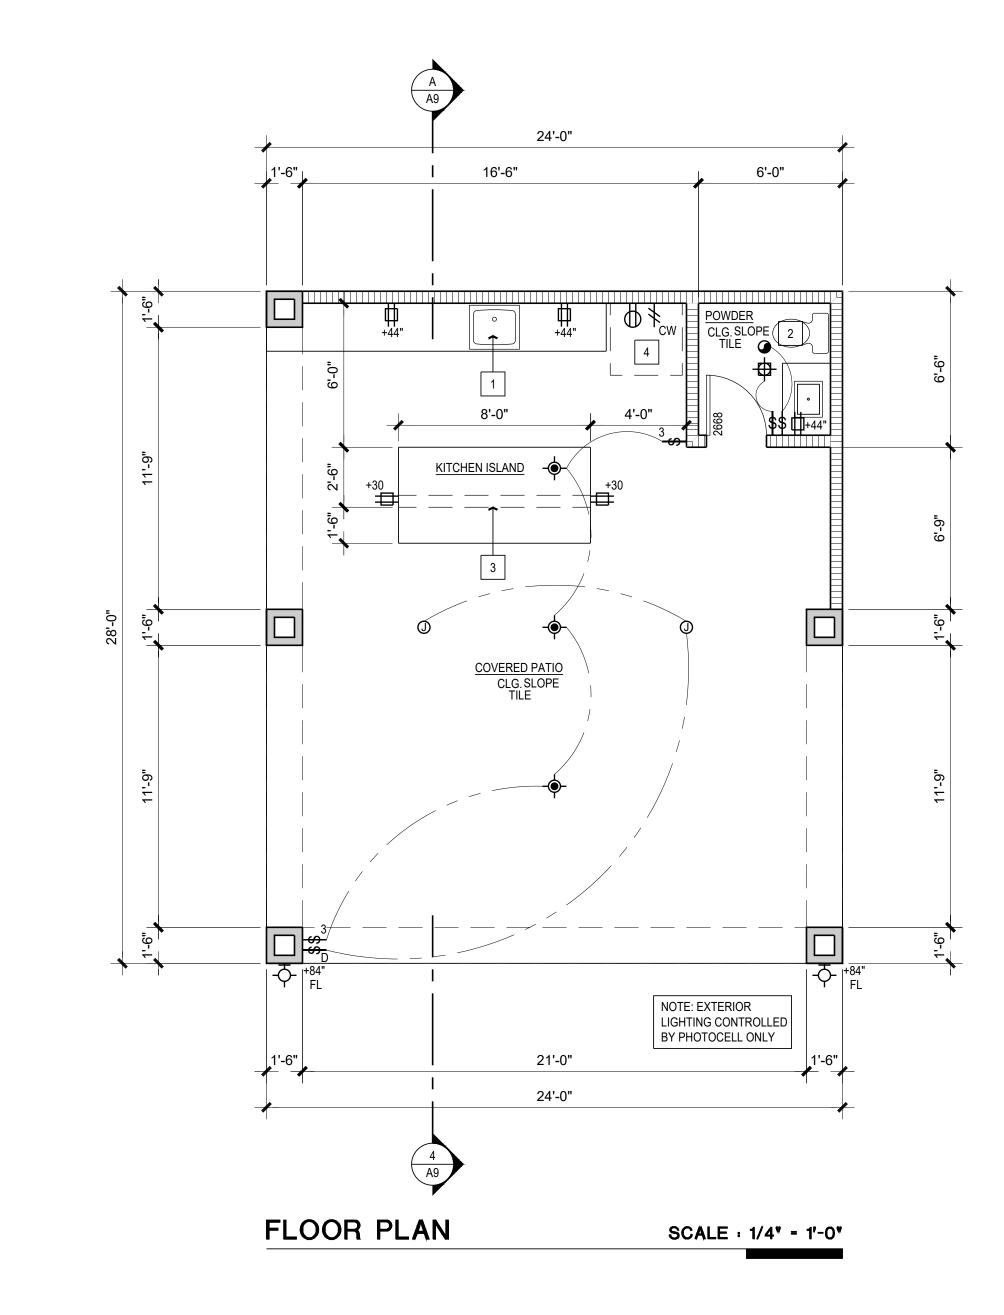


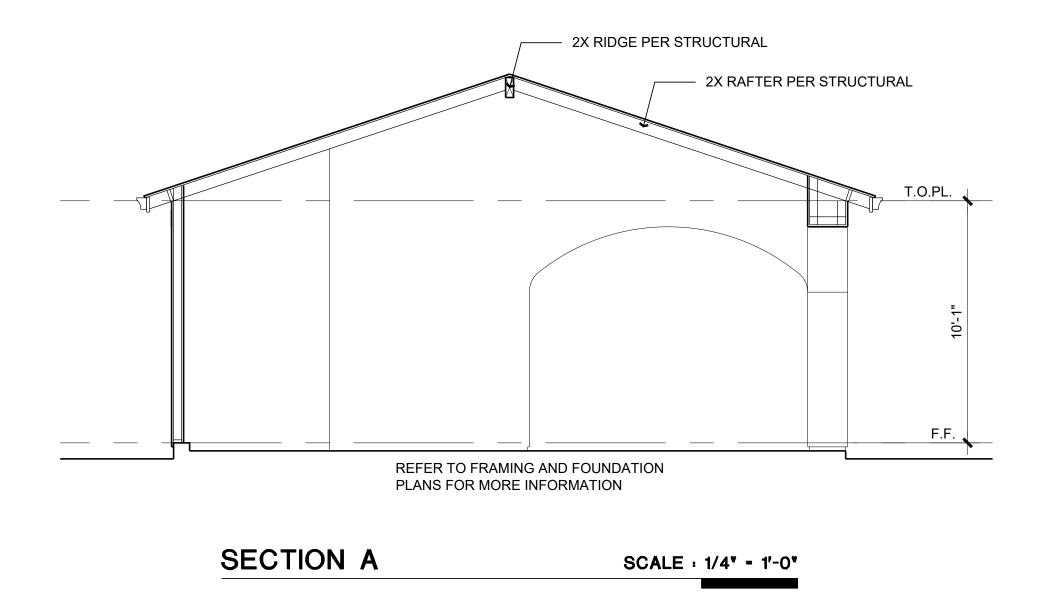


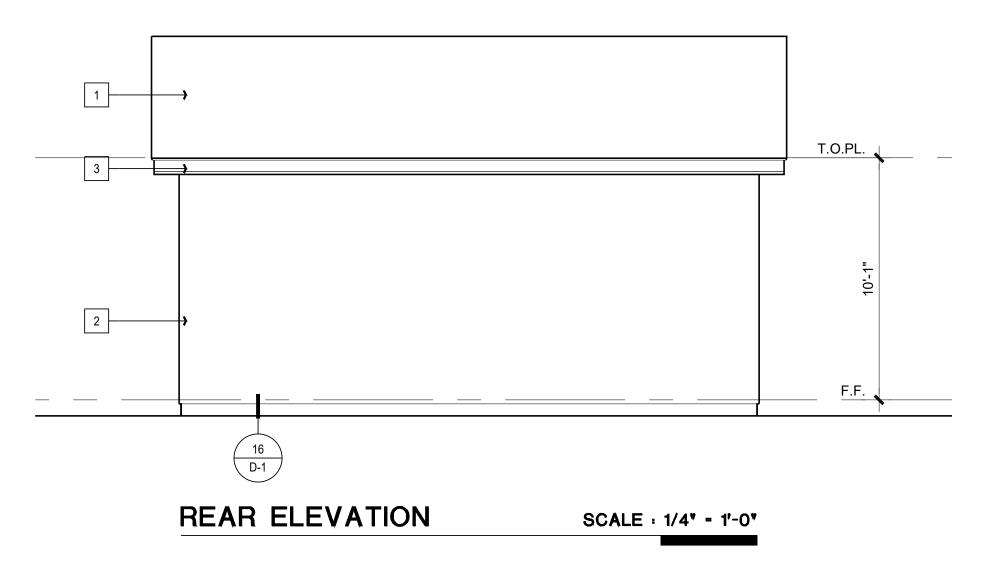


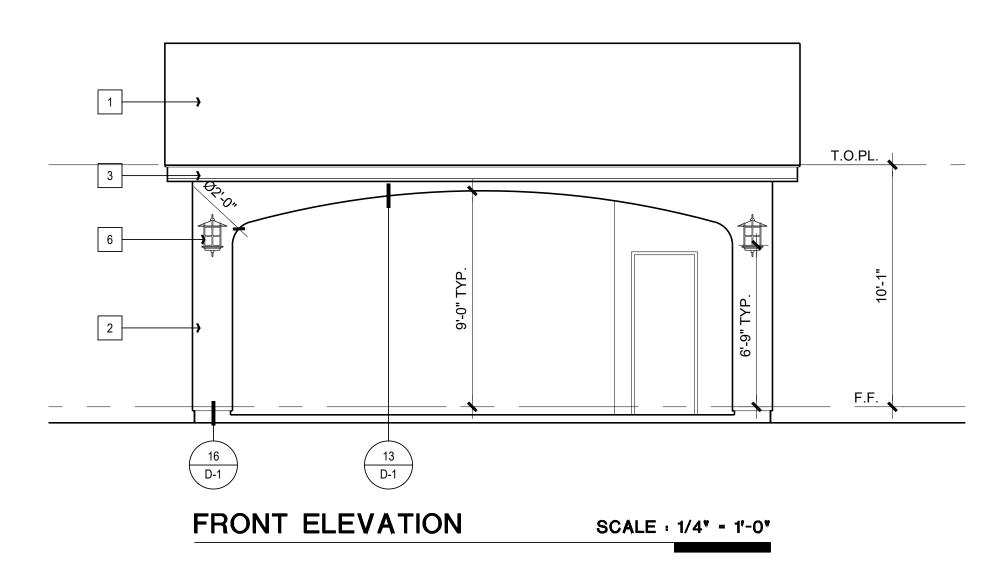

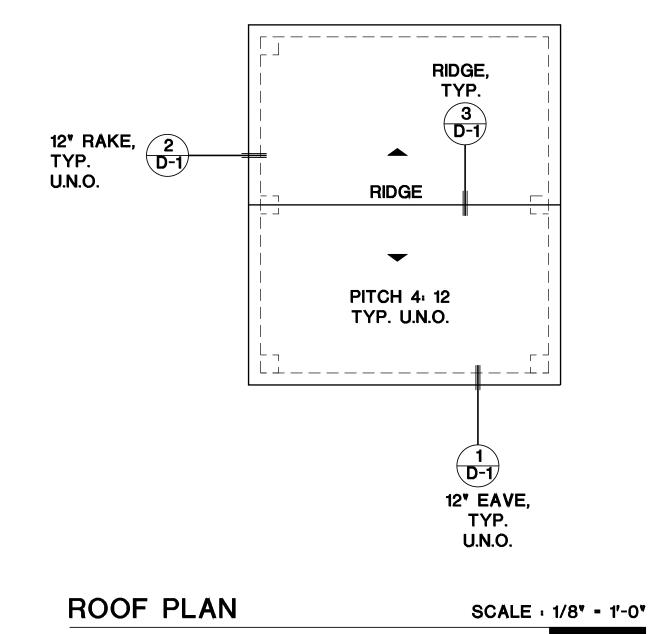

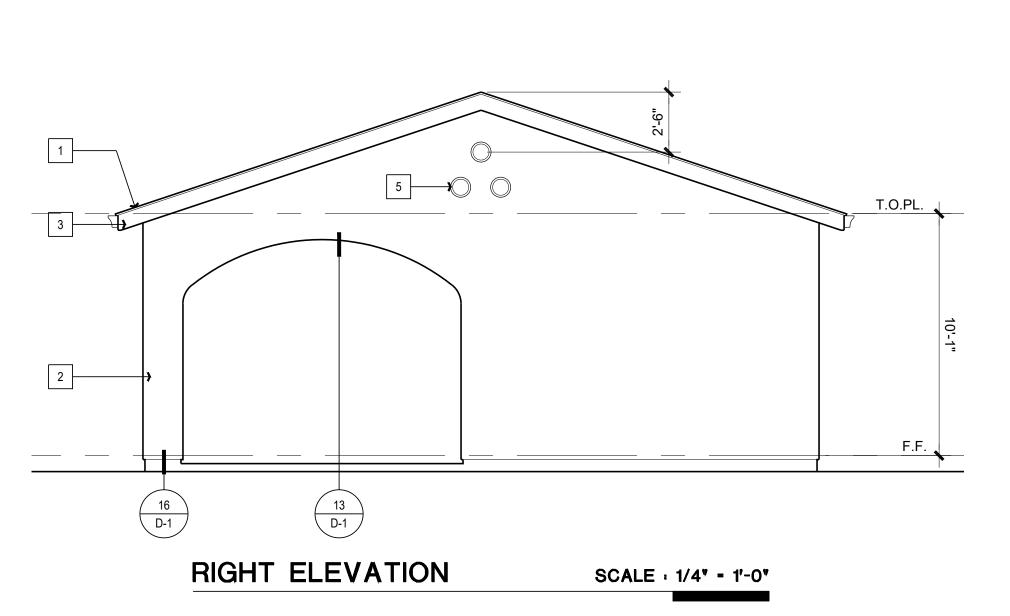

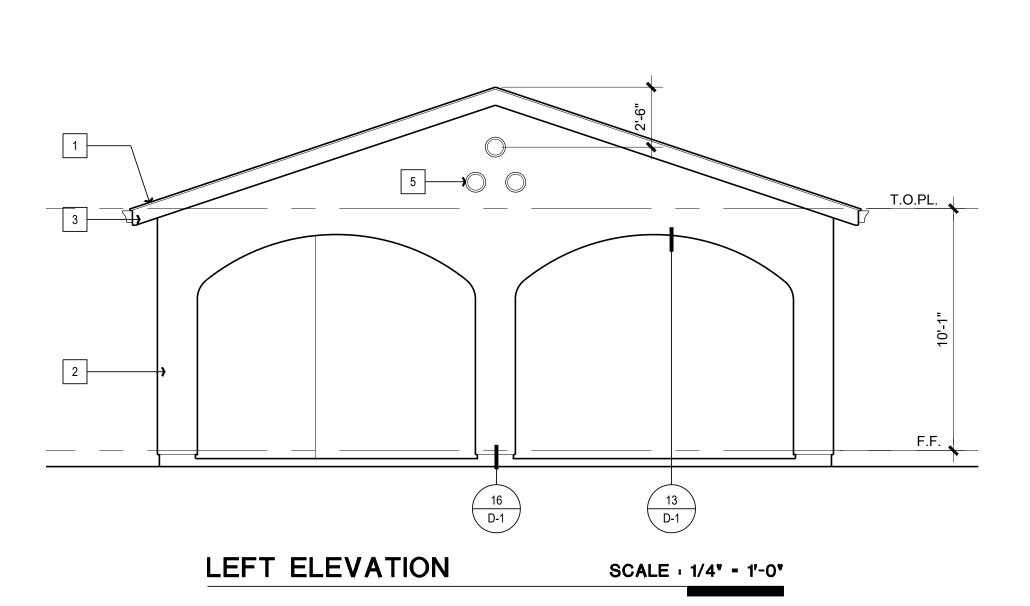

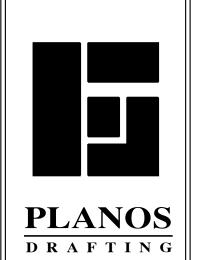

Design Drawings
 Construction Drawings

GONZALO GUILLEN
DESIGNER

718 S. Hickory St. Santa Ana, CA 92701

Tel. 714. 667.0892 Cell 714. 227.1189

Email: gplanos@sbcglobal.net

Job Number: 07/2019

Drawn By: GONZALO

Checked By GONZALO

No. Date: Description:

Scale:

02/10/2020

As Shown:

FLOOR PLAN KEYNOTES

WATER CLOSETS-PROVIDE A MIN. 30" CLR. SPACE PER PLAN AND MAX. OF 1.28 GALLONS PER FLUSH

3 LOW WALL - REFER TO PLAN FOR HEIGHT

36" CLEAR REFRIGERATOR SPACE (PROVIDE RECESSED COLD WATER BIB AND SHUT-OFF FOR ICE-MAKER) PER OWNER'S SPECIFICATIONS

WALL LEGEND

2X4 STUDS AT 16" o.c. U.N.O.
2X6 STUDS AT 16" o.c. U.N.O.

FLOOR PLAN NOTES

CEMENT, FIBER-CEMENT, FIBER-MAT REINFORCED CEMENT, GLASS MAT GYPSUM OR FIBER-REINFORCED GYPSUM BACKERS SHALL BE USED AS A BASE FOR WALL TILE IN TUB AND SHOWER AREAS AND WALL AND CEILING PANELS IN SHOWER AREA PER CRC.
 A MINIMUM 26 GA. CORROSION-RESISTANT OR PLASTIC WEEP SCREED WITH A MINIMUM VERTICAL FLANGE OF 3 ½" SHALL BE PROVIDED AT OR BELOW FOUNDATION PLATE LINE ON EXTERIOR STUD WALLS. SCREED SHALL BE A MINIMUM OF 6" ABOVE

5. WATERCLOSETS TO BE MAXIMUM 1.28 GALLONS PER FLUSH PER CGBSC

EXTERIOR ELEVATION NOTES

EARTH OR 2" ABOVE PAVED AREAS, PER CRC. 3. TYPICAL 6" CLEAR FROM DOOR TO PERPENDICULAR WALL. 4. ALL EXTERIOR DOORS OF CONDITIONED SPACES SHALL BE FULLY WEATHERSTRIPPED.

1 ROOF MATERIAL - REFER TO ROOF NOTES
2 THREE (3) COAT 7/8" CEMENT PLASTER, PAINT COLOR AS SELECTED BY OWNER.

3 BARGE BOARD/FASCIA4 G.I. DRIP SCREED

5 FALSE PIPE VENTS - REFER TO DETAIL

6 LIGHT FIXTURE - REFER TO ELECTRICAL PLANS

ROOF PLAN NOTES



indicates roof slope and direction & pitch unless otherwise noted

GUTTERS SHALL BE SEAMLESS 5" ALUM. PAINT TO MATCH ADJ.

DOWNSPOUT 2"X3" (ROOF LEVEL) - ALUM. PAINT TO MATCH ADJ. SURFACE - REFER TO CIVIL DWGS FOR CONNECTION TO

UNDERGROUND DRAINAGE SYSTEM

ROOF COVERINGS SHALL BE INSTALLED PER MANUFACTURER'S INSTRUCTIONS AND SHALL COMPLY WITH CRC CODE

 ROOF MATERIAL: CONCRETE LOW 'S' EAGLE TILE, CLASS 'A' ER# 1900, REFER TO ROOF PLAN.

2. ALL ROOFING TO BE INSTALLED OVER MINIMUM (1), LAYER OF 30# ROOF FELT,

WEATHERBOARD LAP INSTALL PER TILE MFR. SPECS.

REFER TO EXTERIOR ELEVATIONS FOR ROOF TO WALL FLASHING DETAILS
 REFER TO 9/AD.2 FOR TYPICAL VENT THROUGH ROOF DETAILS

5. REFER TO 8/AD.2 FOR TYPICAL RAKE TO WALL DIVERTER DETAIL

6. 12" TYPICAL ROOF OVERHANG AT EAVE, U.N.O.7. 12" TYPICAL ROOF OVERHANG AT RAKE, U.N.O.

8. RADIANT BARRIER TYPICAL, REFER TO T24 SHEETS

9. INSTALLATION AND FASTENING REQUIREMENTS FOR CONCRETE TILE PER CRC R905.3

UTILITY LEGEND

110 OUTLET

GFCI DUPLEX

\$ SWITCH

\$ SWITCH (3-WAY)

RECESSED CAN LIGHT

-**∳**- PENDANT

FL FLUORESCENT WALL MOUNTED LIGHT

✓ EXHAUST FAN 50 CFM MIN.
 ─-\\(\frac{1}{4}\) H.B. HOSEBIB WITH NON-REMOVABLE BACKFLOW PREVENTION DEVICE

CEILING MOUNTED JUNCTION BOX

GAS PIPING EXTENDING THROUGH FOUNDATION WALL SHALL BE SLEEVED AND HAVE ITS OPENING SEALED ON OUTSIDE. 2019 CPC SEC 1211.0

UTILITY NOTES

2. ALL RECEPTACLES THAT SERVE THE COUNTER AREA SHALL BE GFCI

PROTECTED IN KITCHEN AREA. 2019 CEC 210.52C

3. IN ALL AREAS SPECIFIED IN 2019 CEC 210.52, ALL 125-VOLT, 15 AND 20 AMP

RECEPTACLES SHALL BE LISTED TAMPER-RESISTANT RECEPTACLES.

4. BATHROOM BRANCH CIRCUITS - AT LEAST ONE 20-AMP BRANCH CIRCUIT

BATHROOM BRANCH CIRCUITS - AT LEAST ONE 20-AMP BRANCH CIRCUIT SHALL BE PROVIDED TO SUPPLY BATHROOM RECEPTACLE OUTLETS. SUCH CIRCUITS SHALL HAVE NO OTHER OUTLETS. PER 2019 CEC 210.11C2
 FLUORESCENT LIGHT FIXTURES SHALL BE CONTROLLED BY ELECTORNIC 4-PIN

BALLASTS.

6. ALL RECESSED CAN LIGHTS SHALL BE AIRTIGHT AND IC RATED

ALL RECESSED CAN LIGHTS SHALL BE AIRTIGHT AND IC RATED
 PROVIDE UV RESISTANT COVERING AT AC CONDENSER FOR SUCTION LINE

7. PROVIDE UV RESISTANT COVERING AT AC CONDENSER FOR SUCTION LI
 INSULATION AT EXPOSED EXTERIOR LOCATIONS
 8. FANS SHALL BE ENERGY STAR COMPLIANT AND SHALL BE DUCTED TO

TERMINATE OUTSIDE THE BUILDING

9. HUMIDISTAT CONTROLS SHALL BE CAPABLE OF ADJUSTMENT BETWEEN A RELATIVE HUMIDITY RANGE OF 50 TO 80 PERCENT.

RELATIVE HUMIDITY RANGE OF 50 TO 80 PERCENT.

10. HIGH EFFICACY LUMINAIRES MUST BE PIN BASED.


GRANADOS RESIDENC
17312 LOBDELL LANE
SILVERADO CA COSTO


Sheet Title:
PROPOSED
COVER PATIO

SQUARE FOOTAGE

A9

Sheet No.:

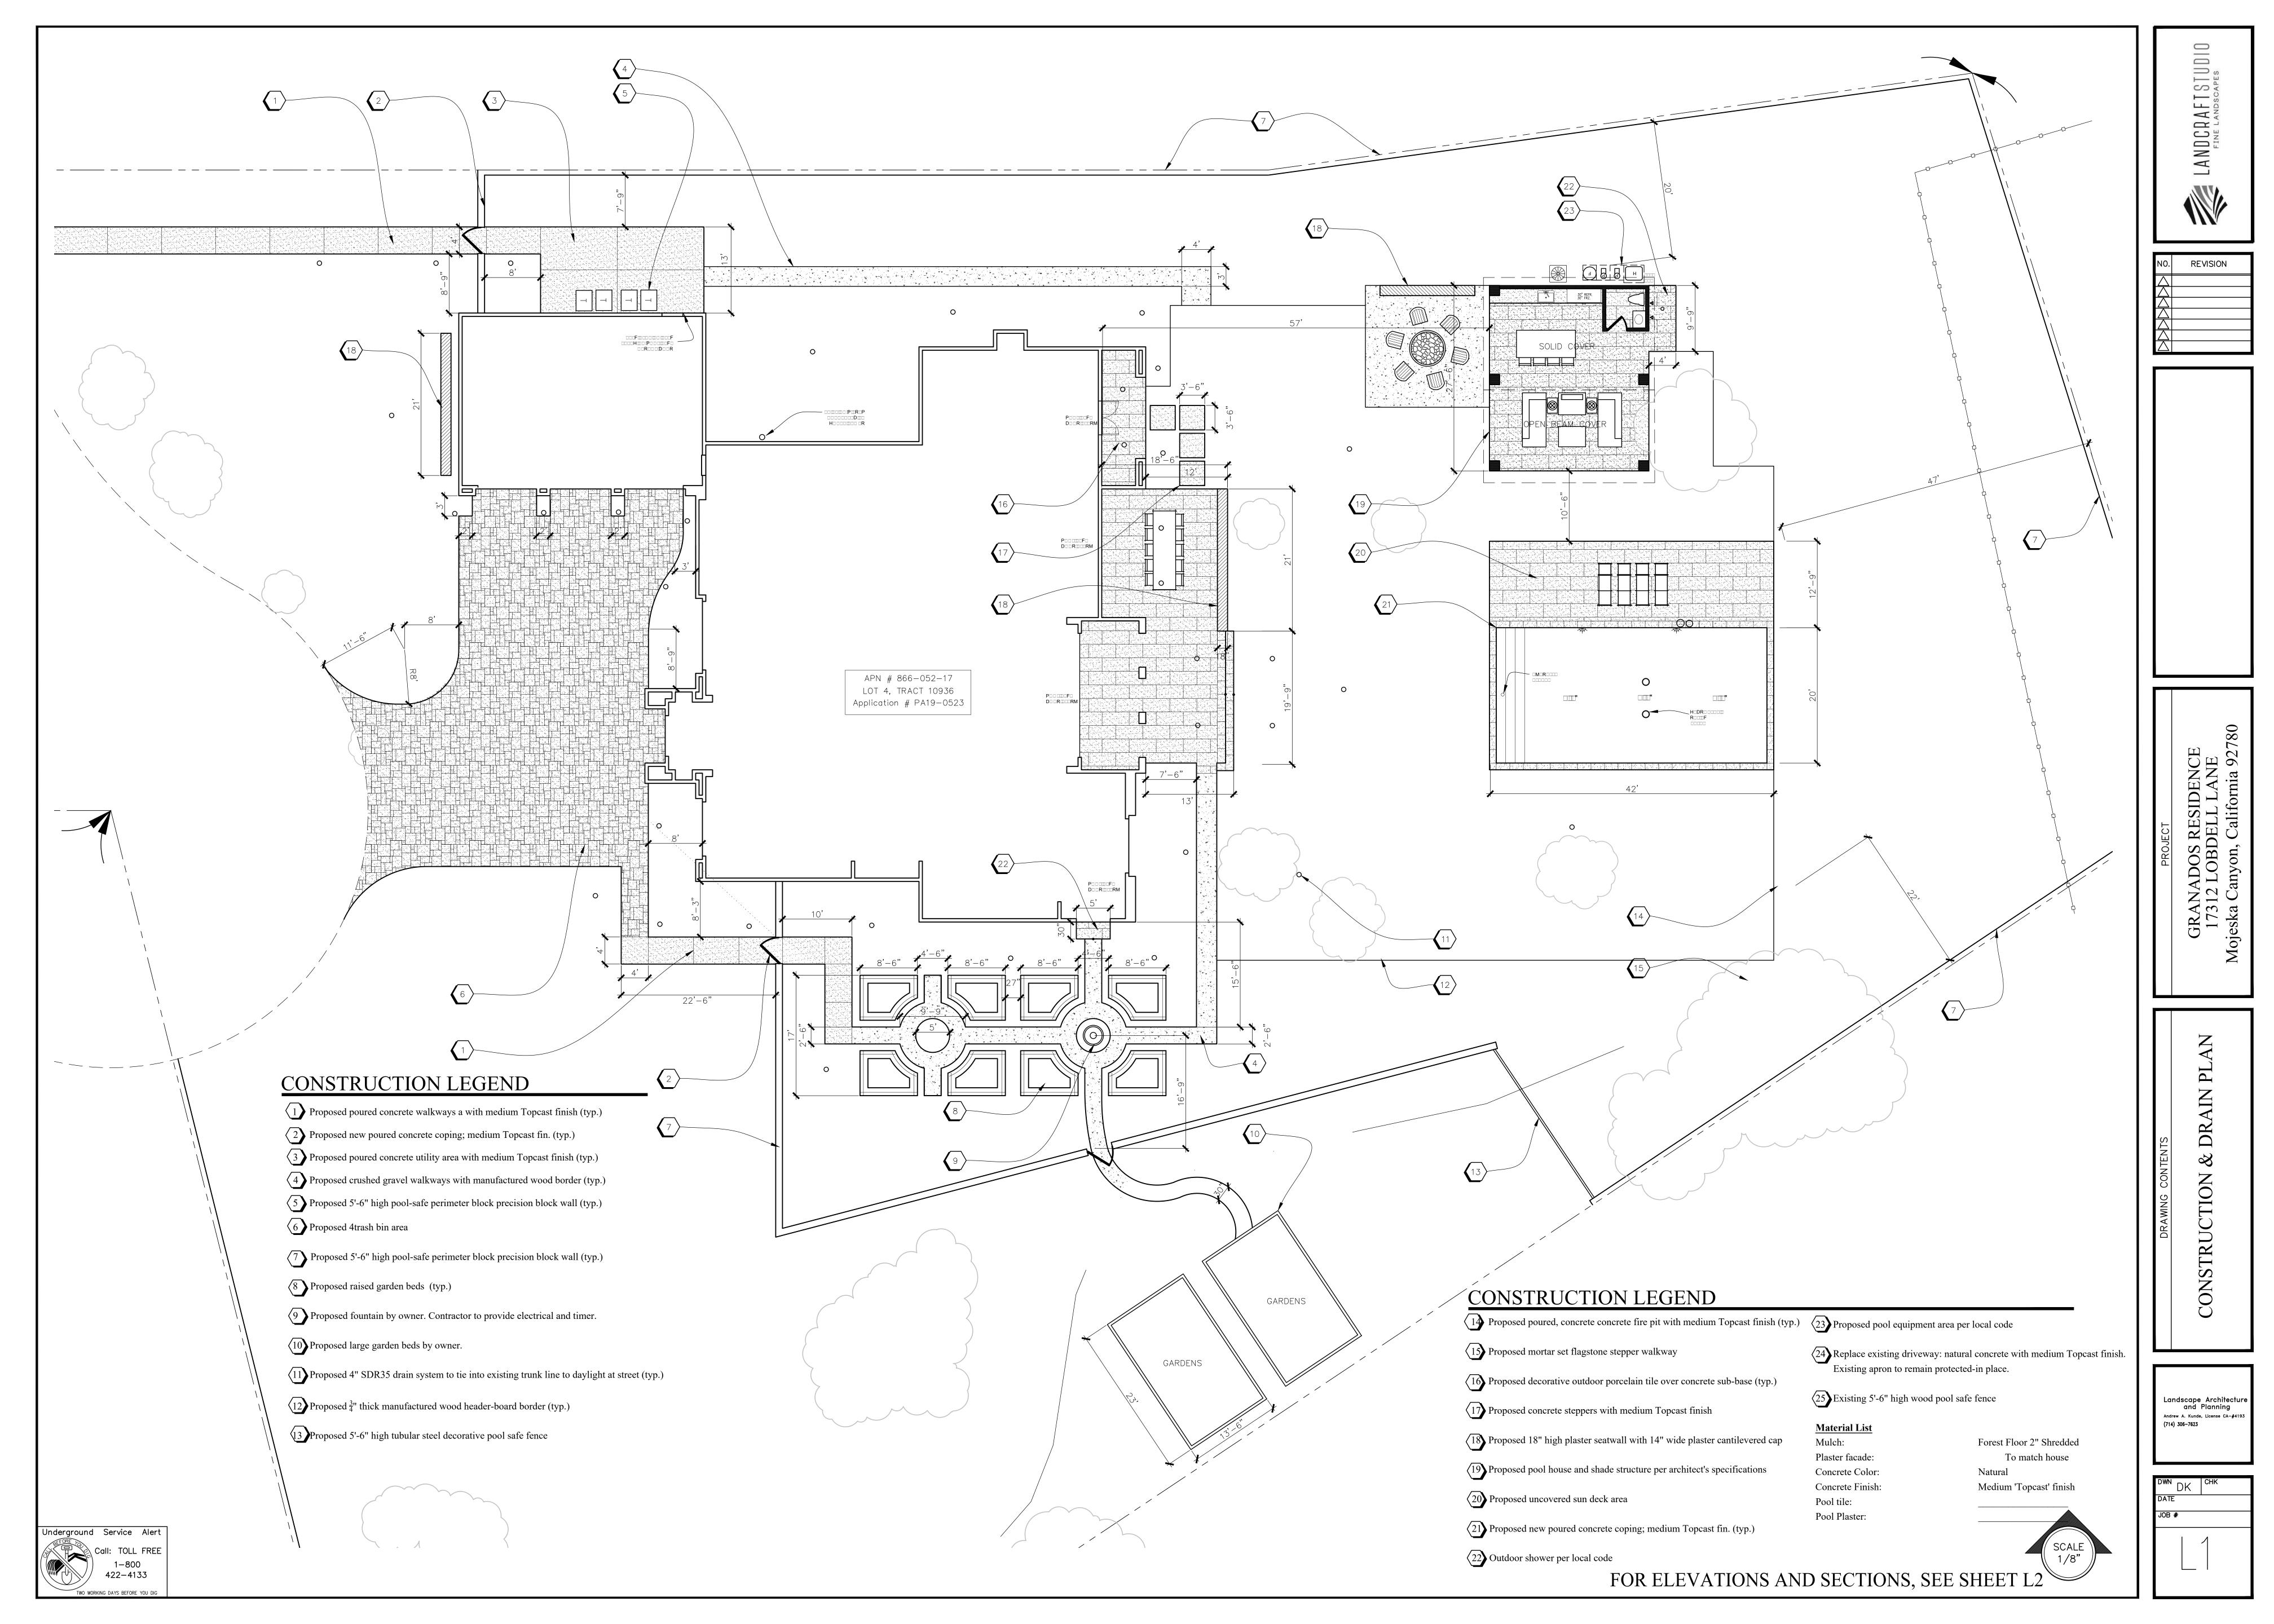

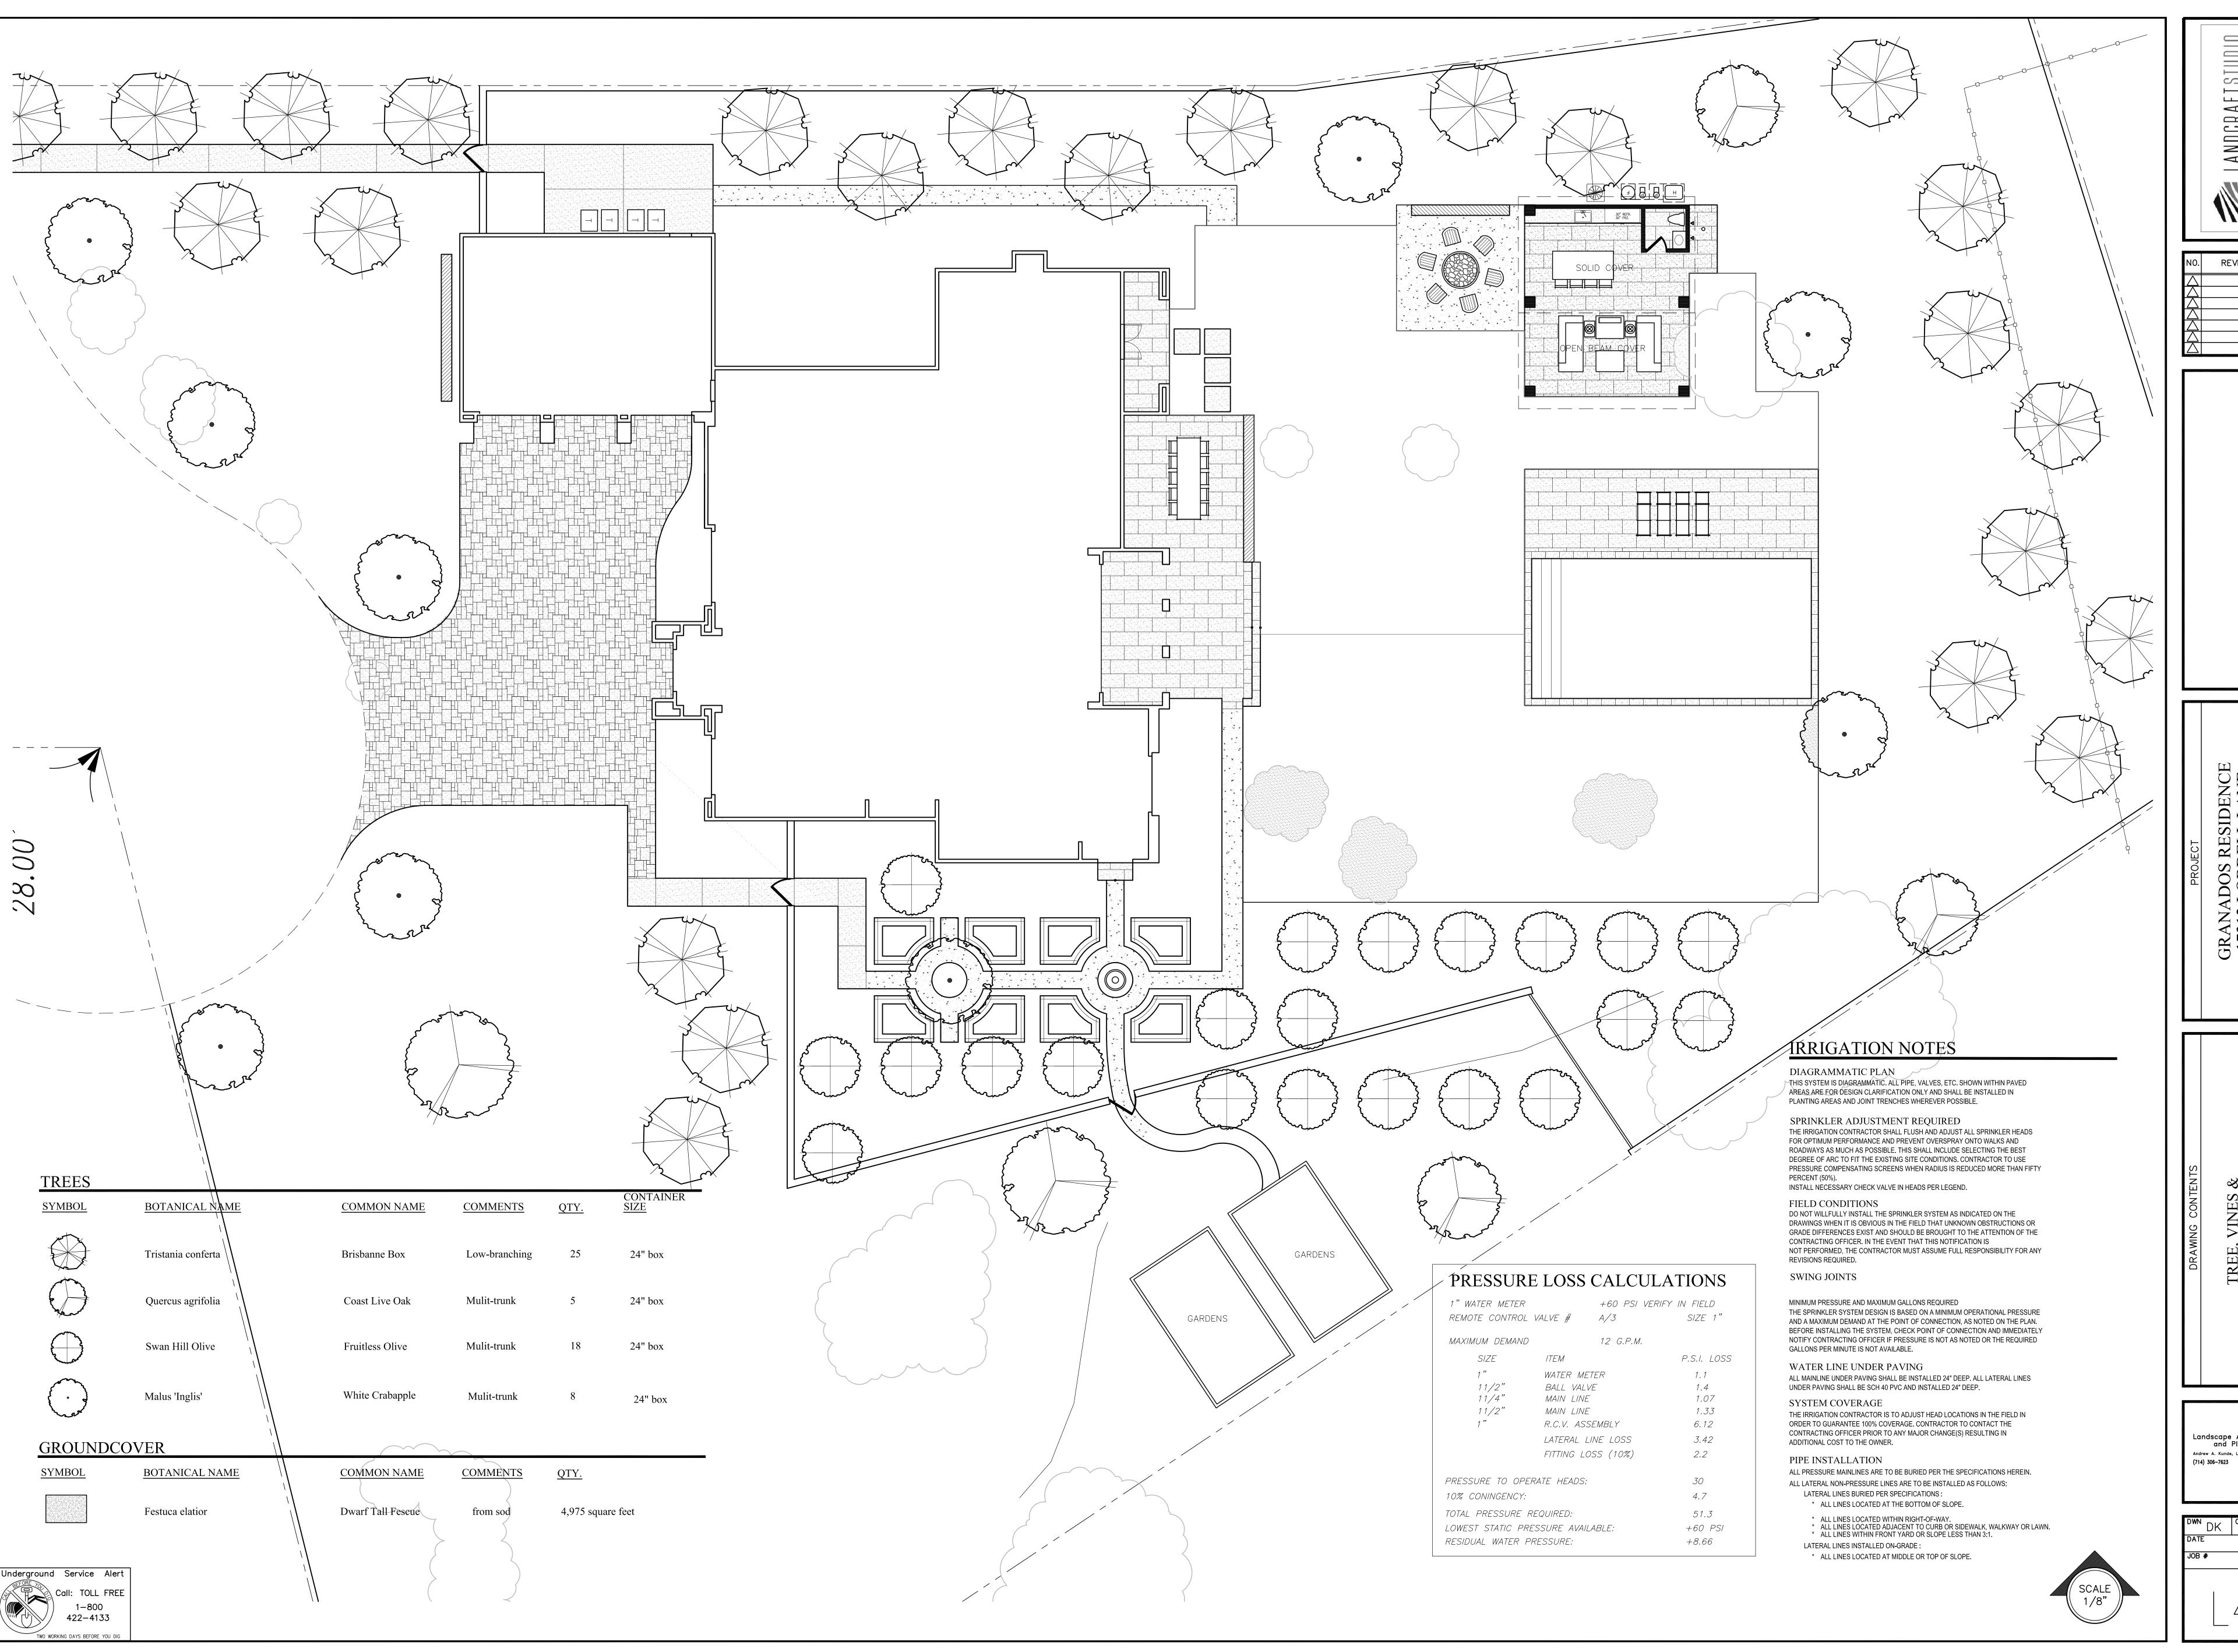

LANDCRAFTSTUDIO

TREE, VINES & ORIP IRRIGATION PLA

Landscape Architecture and Planning Andrew A. Kunde, License CA-#4193

